

GENERAL NOTES

- 1. ALL WORK SHALL CONFORM TO THE REQUIREMENTS OF APPLICABLE BUILDING CODES INCLUDING THE NEW YORK CITY BUILDING CODE, 2008 EDITION, NFPA 101 AND APPLICABLE REFERENCE STANDARDS.
2. THE CONTRACTOR SHALL CHECK AND VERIFY ALL DIMENSIONS AND CONDITIONS IN THE FIELD AND REPORT DISCREPANCIES TO THE ARCHITECT.
3. THE CONTRACTOR SHALL FILE ALL NECESSARY CERTIFICATES OF INSURANCE WITH THE DEPARTMENT OF BUILDINGS. PAY ALL FEES, OBTAIN ALL PERMITS AND PROVIDE ANY AND ALL BONDS REQUIRED BY ANY CITY AGENCY IN ORDER TO DO THE WORK HEREIN DESCRIBED.
4. THE CONTRACTOR SHALL PERFORM ALL OPERATIONS OF SELECTIVE DEMOLITION, DISMANTLING, AND REMOVAL INDICATED ON THE DRAWINGS AND AS MAY BE REQUIRED BY THE WORK AND SHALL WORK CAREFULLY AND NEATLY IN A SYSTEMATIC MANNER.
5. ALL EXISTING SURFACES AND EQUIPMENT TO REMAIN SHALL BE FULLY PROTECTED FROM DAMAGE. THE CONTRACTOR SHALL ASSUME FULL RESPONSIBILITY FOR DAMAGE AND SHALL MAKE REPAIRS (SUBJECT TO THE REVIEW/APPROVAL OF THE ARCHITECT). REPAIRS SHALL BE MADE WITHOUT ADDITIONAL COST TO THE OWNER.
6. NO DEBRIS SHALL BE ALLOWED TO ACCUMULATE ON THE SITE. DEBRIS SHALL BE REMOVED BY THE CONTRACTOR AS THE JOB PROCEEDS. THE SITE SHALL BE LEFT BROOM CLEAN AT THE COMPLETION OF DISMANTLING AS DEFINED IN CONTRACTORS SCOPE OF WORK.
7. THE CONTRACTOR SHALL COORDINATE ALL WORK PROCEDURES WITH REQUIREMENTS OF AUTHORITIES HAVING JURISDICTION.
8. ALL DIMENSIONS ARE TO FINISHED FACE OF SURFACES UNLESS OTHERWISE NOTED.
9. THE CONTRACTOR SHALL NOT SCALE DRAWINGS OR DETAILS. ONLY WRITTEN DIMENSIONS SHALL BE USED.
10. MINOR DETAILS NOT USUALLY SHOWN OR SPECIFIED, BUT NECESSARY FOR PROPER CONSTRUCTION OF ANY PART OF THE WORK SHALL BE INCLUDED AS IF THEY WERE INDICATED ON THE DRAWINGS.
11. THE CONTRACTOR SHALL LAY OUT HIS OWN WORK, AND SHALL PROVIDE ALL DIMENSIONS REQUIRED FOR OTHER TRADES.
12. THE CONTRACTOR SHALL PROVIDE ALL CUTTING, PATCHING, REPAIRS AS REQUIRED TO PERFORM ALL OF THE WORK INDICATED ON THE DRAWINGS, AND ALL OTHER WORK THAT MAY BE REQUIRED TO COMPLETE THE JOB. PROVIDE ALL CORE DRILLING, FLOOR AND WALL OPENINGS, ETC., REQUIRED BY HVAC AND ELECTRICAL RETROFIT AND CLOSURE FO EXISTING HOLES AND OPENINGS NOT USED.
13. PROVIDE A PROTECTION PLAN FOR ALL ALL EXISTING HISTORICAL ELEMENTS SCHEDULED TO REMAIN, INCLUDING ALL CORNICES, PILASTERS AND FIREPLACE MANTLES.
14. EXISTING WOODWORK SHALL BE PATCHED WITH WOODWORK TO MATCH EXISTING WHERE IT HAS BEEN COMPROMISED BY THE WORK.
15. NO STRUCTURAL ELEMENTS SHALL BE REMOVED UNLESS PORTIONS AFFECTED ARE ADEQUATELY SUPPORTED BY EITHER TEMPORARY SHORING OR NEW STRUCTURAL ELEMENTS AS REQUIRED TO PROTECT THE STABILITY AND INTEGRITY OF THE EXISTING STRUCTURE. ALL STRUCTURAL REMOVALS SHALL BE COORDINATED WITH STRUCTURAL DRAWINGS.
16. SKIM COAT PLASTER ONLY WHERE THE PLASTER SURFACES HAVE BEEN COMPROMISED BY THE WORK.
17. CONTRACTOR SHALL PROVIDE, ERECT AND MAINTAIN ALL TEMPORARY BARRIERS AND GUARDS AND ALL TEMPORARY SHORING, BRACING AND HEAT AS REQUIRED BY OSHA.
18. CONTRACTOR SHALL PROVIDE ADEQUATE WEATHER PROTECTION FOR THE BUILDING AND ITS CONTENTS DURING THE COURSE OF THE WORK. ALL OPENINGS IN ANY WALL OR ROOF SHALL BE PROTECTED FROM ALL FORMS OF WATER PENETRATION.
19. CONTRACTOR SHALL PROTECT EXISTING DOORS. SELECTED DOORS AS IDENTIFIED ON DOOR SCHEDULE. SHALL BE RESTORED AND REINSTALLED AT DESIGNATED LOCATIONS.
20. ALL ANNOTATIONS REFER TO NEW WORK UNLESS NOTED AS EXISTING.
21. THE TERM "PROVIDE" USED IN THE CONTRACT DOCUMENTS MEANS FURNISH AND INSTALL.
22. THE USE OF ANY OPEN FLAME OR TORCH IS NOT PERMITTED ANYWHERE IN THE BUILDING. BRAZING AND TORCH WORK WILL BE AS A LAST RESORT AND STRICTLY LIMITED IN IT USE IN THE TUNNEL. ANY WORK IN LIEU OF TORCH WORK SHOULD BE EXPLORED FIRST SUCH AS MECHANICAL OR CHEMICAL FASTENERS OR MECHANIZED CUTTING TOOLS. IN THE EVENT THAT THE PIPES NEED TO BE BRAZED IN THE TUNNEL SECTION OF THE BUILDING THE CONTRACTOR SHALL CLOSELY ADHERE TO SAFETY GUIDELINES. FDNY SHALL SUGGEST A PROTOCOL PRIOR TO THE START OF WORK. CONTRACTOR SHALL HAVE ON DUTY CERTIFIED FIRE GUARDS WITH FDNY APPROVED CERTIFICATE OF FITNESS. HAVE AVAILABLE ON SITE FIRE BLANKETS, 5 GALLON WATER FIRE EXTINGUISHERS, "SMOKE EATERS" FOR SMOKE MITIGATION, ETC. CONTRACTOR SHALL SUBMIT A WORK PLAN THAT INCLUDES ALL SAFETY ASPECT REQUIRED BY FDNY. SUCH WORK SHALL ONLY BE ALLOWED IN THE TUNNEL AND UNDER CLOSE SUPERVISION OF DDC EMPLOYEES AND CERTIFIED FIRE GUARDS. THE MAYOR'S OFFICE MUST BE NOTIFIED PRIOR TO COMMENCEMENT OF ANY SUCH WORK.

CULTURAL RESOURCE MANAGEMENT (ARCHAEOLOGICAL) SERVICES

AS PART OF THE PROPOSED CITY HALL RENOVATION PROJECT, BEYER BLINDER BELLE ARCHITECTS & PLANNERS LLP (BBB) HAS RETAINED THE SERVICES OF A CULTURAL RESOURCE MANAGEMENT (CRM) (ARCHAEOLOGICAL) FIRM.

IN ORDER TO MEET EXISTING CITY OF NEW YORK REGULATIONS RELATING TO ARCHAEOLOGY, THE CITY OF NEW YORK - LANDMARKS PRESERVATION COMMISSION (LPC) HAS SET FORTH SPECIFIC REQUIREMENTS FOR ARCHAEOLOGICAL SERVICES. THE CRM FIRM RETAINED BY BBB WILL MEET ALL OF THE REQUIREMENTS OF THE LPC.

THE CRM FIRM WILL WORK IN CONSORT WITH THE ON-SITE CONTRACTOR (S) TO ENSURE ALL LPC REQUIREMENTS ARE MET. THE CRM FIRM WILL BE ON SITE TO EITHER MONITOR OR EXCAVATE SPECIFIC AREAS EITHER PRIOR TO OR DURING THE CONTRACTOR'S EXCAVATIONS IN SUPPORT OF THE UNDERPINNING OF THE EXISTING FOUNDATION. THE TEST TRENCHING FOR THE LOCATION OF THE EXISTING UTILITIES AND POTENTIALLY EITHER EXCAVATION OR MONITORING OF THE EXCAVATION FOR THE INSTALLATION OF THE UPGRADED UTILITIES.

A CRM WORK PLAN AND AN UNANTICIPATED FINDS PLAN HAVE BEEN CREATED FOR THE PROJECT, WHICH BOTH THE CRM FIRM AND THE CONTRACTOR WILL FOLLOW. DURING MONITORING, THE CRM FIRM WILL HAVE THE AUTHORITY TO HALT EXCAVATION IN THE EVENT THAT SIGNIFICANT BURIED RESOURCES ARE UNCOVERED, AS DETERMINED BY THE ON-SITE ARCHAEOLOGIST. THE CONTRACTOR WILL BE ALLOWED TO CONTINUE EXCAVATION IN THE AFFECTED AREA UPON COMPLETION OF THE ARCHAEOLOGIST'S INSPECTION.

LIST OF SPECIAL INSPECTIONS

THE FOLLOWING ITEMS ARE SUBJECT TO SPECIAL INSPECTION PER THE NYC BLDG CODE. DDC SHALL ENGAGE A NY STATE LICENSED PROFESSIONAL ENGINEER.

TO PERFORM THE SPECIAL INSPECTIONS. SUCH INSPECTION ENGINEER WILL BE APPROVED BY THE ARCHITECT.

- 1. STRUCTURAL STEEL - WELDING BC 1704.3.1
2. STRUCTURAL STEEL - ERECTION & BOLTING BC 1704.3.2
3. STRUCTURAL COLD-FORMED STEEL BC 1704.3.3
4. CONCRETE - CAST-IN-PLACE BC 1704.3.4
5. MASONRY (LEVEL 1) BC 1704.4
6. SOILS - SITE PREPARATION BC 1704.5
7. SOILS - FILL PLACEMENT & IN-PLACE DENSITY BC 1704.7.1
8. STRUCTURAL SAFETY - STRUCTURAL STABILITY BC 1704.7.2
9. FIRESTOP, DRAFTSTOP, AND FIREBLOCK SYSTEMS BC 1704.25
10. CONCRETE TEST CYLINDERS BC 1905.6
11. CONCRETE DESIGN MIX BC 1905.3
12. FOOTING AND FOUNDATION BC 109.3.1
13. FRAME INSPECTION BC 109.3.3
14. FIRE-RESISTANCE RATED CONSTRUCTION BC 109.3.4
15. FINAL DIRECTIVE 14 OF 1975

ITEMS TO BE FILED SEPARATELY

- 1. MECHANICAL & PLUMBING WORK SHALL BE FILED SEPERATELY
2. FIRE PROTECTION WORK SHALL BE FILED SEPERATELY
3. FIRE ALARM WORK SHALL BE FILED SEPERATELY
4. ELECTRICAL WORK THE GENERAL CONTRACTOR SHALL OBTAIN APPROVAL FOR THE WORK PERTAINING TO THE ELECTRICAL WORK.
5. LULA ELEVATOR WORK SHALL BE FILED SEPERATELY

BUILDING DEPARTMENT NOTES

- 1. COMPLY WITH THE NEW YORK CITY BUILDING CODE, ADAAG AND ANSI STANDARDS. ALL PRODUCTS SHALL DISPLAY MEA NUMBER. SUBMIT TO THE ARCHITECT BSA CERTIFICATION NUMBERS AND MEA NUMBERS FOR MATERIALS, ASSEMBLIES AND EQUIPMENT SCHEDULED TO BE PART OF THE WORK.
2. OBTAIN REQUIRED PERMITS AND PAY ASSOCIATED FEES AT NO ADDITIONAL COST TO THE OWNER.
3. COORDINATE AND SCHEDULE INSPECTIONS WITH AGENCIES AND THE ARCHITECT IN A TIMELY FASHION IN ORDER TO AVOID DELAY IN THE WORK.
4. MAINTAIN MEANS OF EGRESS FREE AND CLEAR OF DEBRIS AND CONSTRUCTION MATERIALS AT ALL TIMES.
5. FIRESTOP ALL OPENINGS BETWEEN FLOORS AT THE FLOOR DECK AND AROUND EDGE OF GYPSUM BOARD OR PLASTER CEILING. FIRESTOP ALL WALL OPENINGS.
6. MAINTAIN THE FIRE-RESISTANCE RATING OF EXISTING ASSEMBLIES, INCLUDING BUT NOT LIMITED TO PARTITIONS, SLABS AND STRUCTURAL MEMBERS.

APPLICABLE BUILDING CODES

- A. BUILDING CODE NEW YORK CITY BUILDING CODE (ADMINISTRATIVE CODE TITLE 27-CHAPTER 1) EFFECTIVE DECEMBER 6, 1998
B. FIRE CODE NEW YORK CITY FIRE CODE, EFFECTIVE JULY 1, 2008.
C. ACCESSIBILITY NEW YORK CITY LOCAL LAW 58 OF 1987

REFERENCED STANDARDS

- NATIONAL FIRE PROTECTION ASSOCIATION (NFPA) STANDARDS, AS REFERENCED BY THE BUILDING AND FIRE CODES OF THE CITY OF NEW YORK, INCLUDING, BUT NOT LIMITED TO:
NFPA 13, STANDARD FOR INSTALLATION OF SPRINKLER SYSTEMS - 2002 EDITION, WITH NEW YORK CITY MODIFICATIONS, AS REFERENCED BY THE 2008 NYC BUILDING CODE AND THE NYC MODIFICATIONS INCLUDED IN APPENDIX Q.
NFPA 14 STANDPIPE SYSTEMS - 2002 EDITION, WITH NEW YORK CITY MODIFICATIONS, AS REFERENCED BY THE 2008 EDITION OF THE NYC BUILDING CODE AND THE NYC MODIFICATIONS INCLUDED IN APPENDIX Q.
NFPA 72 NATIONAL FIRE ALARM CODE - 2002 EDITION, WITH NEW YORK CITY MODIFICATIONS, AS REFERENCED BY THE 2008 EDITION OF THE NYC BUILDING CODE AND THE NYC MODIFICATIONS INCLUDED IN APPENDIX Q.

ZONING DATA

OWNER: DEPARTMENT OF CITYWIDE ADMINISTRATIVE SERVICES
LOCATION: CITY HALL PARK
BLOCK: 122
LOT: 1
ZONING: C 6-4
LOT AREA: 391,456 SF
OCCUPANCY CLASSIFICATION: E (BUSINESS)
CONSTRUCTION CLASSIFICATION: II C (COMBUSTIBLE/UNPROTECTED WOOD JOIST)
EXTERIOR WALL: 2 HR
FLOOR AND ROOF: 0 HR
ELEVATOR SHAFT AND MACHINE ROOM: 2 HR


SELECTIVE DEMOLITION NOTES

- 1. NO DEMOLITION WORK SHALL PROCEED BEFORE A PRECONSTRUCTION CONFERENCE TAKES PLACE BETWEEN CONTRACTOR, OWNER, ARCHITECT, AND STRUCTURAL ENGINEER.
2. CONTRACTOR SHALL PERFORM ALL OPERATIONS OF DEMOLITION AND REMOVAL INDICATED ON THE DRAWINGS AND AS MAY BE REQUIRED FOR THE WORK. ALL WORK SHALL BE DONE CAREFULLY AND NEATLY, IN A SYSTEMATIC MANNER.
3. CONTRACTOR SHALL PERFORM ALL OPERATIONS IN THE FIELD, AND NOTIFY ARCHITECT OF DISCREPANCIES BETWEEN DRAWINGS AND FIELD CONDITIONS. CONTRACTOR SHALL PERFORM REMOVAL WORK IN AREAS DESIGNATED EVEN IF THERE ARE DISCREPANCIES BETWEEN DRAWINGS AND FIELD CONDITIONS.
4. ALL EXISTING SURFACES AND EQUIPMENT TO REMAIN SHALL BE FULLY PROTECTED FROM DAMAGE. THE CONTRACTOR SHALL ASSUME FULL RESPONSIBILITY FOR DAMAGE AND SHALL MAKE REPAIRS REQUIRED (SUBJECT TO THE REVIEW/APPROVAL OF THE ARCHITECT) WITHOUT ADDITIONAL COST TO THE OWNER.
5. SEE STRUCTURAL DEMOLITION DRAWINGS BEFORE PROCEEDING WITH DEMOLITION WORK. NO STRUCTURAL ELEMENTS SHALL BE REMOVED UNLESS PORTIONS AFFECTED ARE ADEQUATELY SUPPORTED BY EITHER TEMPORARY SHORING OR NEW STRUCTURAL ELEMENTS AS REQUIRED TO PROTECT THE STABILITY AND INTEGRITY OF THE EXISTING STRUCTURES.
6. ALL ADJOINING PROPERTY AFFECTED BY ANY OPERATIONS OR DEMOLITION SHALL BE PROTECTED PER THE REQUIREMENTS OF ARTICLE 19 OF THE NEW YORK CITY BUILDING CODE.
7. SEE MECHANICAL, ELECTRICAL AND PLUMBING DRAWINGS FOR REMOVALS OF MECHANICAL, ELECTRICAL, AND PLUMBING SYSTEMS AND EQUIPMENT.
8. THE CONTRACTOR SHALL PROVIDE, ERECT, AND MAINTAIN ALL TEMPORARY BARRIERS AND GUARDS, AND ALL TEMPORARY SHORING AND BRACING AS REQUIRED BY THE NEW YORK CITY DEPARTMENT OF BUILDINGS RULES AND REGULATIONS.
9. THE CONTRACTOR SHALL PROVIDE, INSTALL, AND MAINTAIN ADEQUATE WEATHER PROTECTION FOR THE EXISTING BUILDINGS AND THEIR CONTENTS DURING THE COURSE OF THE WORK. ALL OPENINGS IN ANY WALL OR ROOF SHALL BE PROTECTED FROM ALL FORMS OF WEATHER OR WATER PENETRATION.
10. THE CONTRACTOR SHALL FILE ALL NECESSARY CERTIFICATES OF INSURANCE WITH THE DEPARTMENT OF BUILDINGS AND DEPARTMENT OF TRANSPORTATION. PAY ALL FEES, OBTAIN ALL PERMITS AND PROVIDE ANY AND ALL BONDS REQUIRED BY ANY CITY AGENCY IN ORDER TO PERFORM THE WORK HEREIN DESCRIBED.
11. CONTRACTOR SHALL CAREFULLY REMOVE, PROTECT, AND STORE ON THE SITE ITEMS INDICATED TO BE SALVAGED AND SAVED FOR REUSE, AT A LOCATION DETERMINED BY THE OWNER.
12. PROTECT EXISTING BUILDING INTERIORS FROM DAMAGE AND WEATHER. REFER TO MECHANICAL DRAWINGS AND SPECIFICATIONS FOR TEMPORARY HVAC CRITERIA TO BE MAINTAINED IN THE EXISTING BUILDINGS.
13. NO DEBRIS SHALL BE ALLOWED TO ACCUMULATE ON THE SITE. DEBRIS SHALL BE REMOVED BY THE CONTRACTOR AS THE JOB PROCEEDS. THE SITE SHALL BE LEFT BROOM CLEAN AT THE COMPLETION OF DEMOLITION AS DEFINED IN CONTRACTORS SCOPE OF WORK.
14. PERFORM CUTTING AND PATCHING REQUIRED FOR SELECTIVE MECHANICAL, ELECTRICAL AND PLUMBING REMOVALS IN EXISTING BUILDINGS TO REMAIN. MINIMIZE CUTTING AND REMOVAL WORK AND PROTECT ADJACENT FINISHES AND CONSTRUCTION TO REMAIN.
15. CONTRACTOR SHALL PATCH ALL FINISHES WHERE WHERE PIPING, CONDUIT, EQUIPMENT, DUCTWORK AND CEILINGS ARE CALLED TO BE REMOVED.
16. REFER TO DIVISION 1 AND 2 SPECIFICATION SECTIONS FOR ADDITIONAL INFORMATION REGARDING DEMOLITION, SELECTIVE DEMOLITION AND PROCEDURES.
17. REFER TO THE MEP / FP / FS / AV DRAWINGS AND RELATED SEPCIFICATIONS FOR DEMOLITION OF MECHANICAL SYSTEMS.
18. COORDINATE LOCATION FOR DEMOLITION OF EXISTING WALLS, FLOROS AND CEILINGS WITH THE INSTALLATION OF NEW WORK AS SHOWN ON ARCHITECTURAL MEP / FP / FS DRAWINGS.


DRAWING LIST

ARCHITECTURAL / CIVIL


- 1. G-001 GENERAL NOTES, DRAWING LIST & LOCATION PLANS
2. G-002 ABBREVIATIONS, SYMBOLS & BUILDING OCCUPANCY PLAN
3. G-003 ADA ACCESSIBILITY DIAGRAMS & NOTES
4. G-004 FIRE RATED PARTITION PLANS
5. DM-101 BASEMENT FLOOR DEMOLITION PLAN
6. DM-102 FIRST FLOOR DEMOLITION PLAN
7. DM-103 SECOND FLOOR DEMOLITION PLAN
8. DM-104 THIRD FLOOR DEMOLITION PLAN
9. DM-105 ROOF DEMOLITION PLAN
10. A-100 CELLAR FLOOR PLAN
11. A-101 BASEMENT FLOOR PLAN
12. A-102 FIRST FLOOR PLAN
13. A-103 SECOND FLOOR PLAN
14. A-104 THIRD FLOOR PLAN
15. A-301 SOUTH ELEVATION
16. A-302 NORTH ELEVATION
17. A-303 EAST ELEVATIONS
18. A-304 WEST ELEVATIONS
19. A-311 BUILDING SECTION AA
20. A-312 BUILDING SECTION CC,DD AND EE
21. A-421 ENLARGED TOILET PLANS AND ELEVATIONS -1
22. A-422 ENLARGED TOILET PLANS AND ELEVATIONS -2
23. A-423 INTERIOR STAIR DETAILS.
24. A-601 PARTITION TYPES
25. A-602 DOOR SCHEDULE - 1
26. A-603 DOOR SCHEDULE - 2
27. A-604 DOOR SCHEDULE - 3
28. A-605 DOOR SCHEDULE - 4
29. S-102 BASEMENT FLOOR FRAMING PLAN
30. S-103 FIRST FLOOR FRAMING PLAN SHOWN ON BASEMENT WALL PLAN
31. S-104 SECOND FLOOR FRAMING PLAN SHOWN ON FIRST FLOOR WALL PLAN
32. S-105 THIRD FLOOR & ATTIC FRAMING PLAN SHOWN ON SECOND FLOOR WALL PLAN
33. S-106 ROOF FRAMING PLAN
34. S-201 GENERAL NOTES & TYPICAL DETAILS
35. S-202 TYPICAL DETAILS
36. S-203 TYPICAL DETAILS
37. S-301 SECTIONS
38. S-302 SECTIONS
39. S-303 SECTIONS
40. S-304 DETAILS
41. S-305 PENETRATION SCHEDULE
42. S-401 SECTIONS/DETAILS

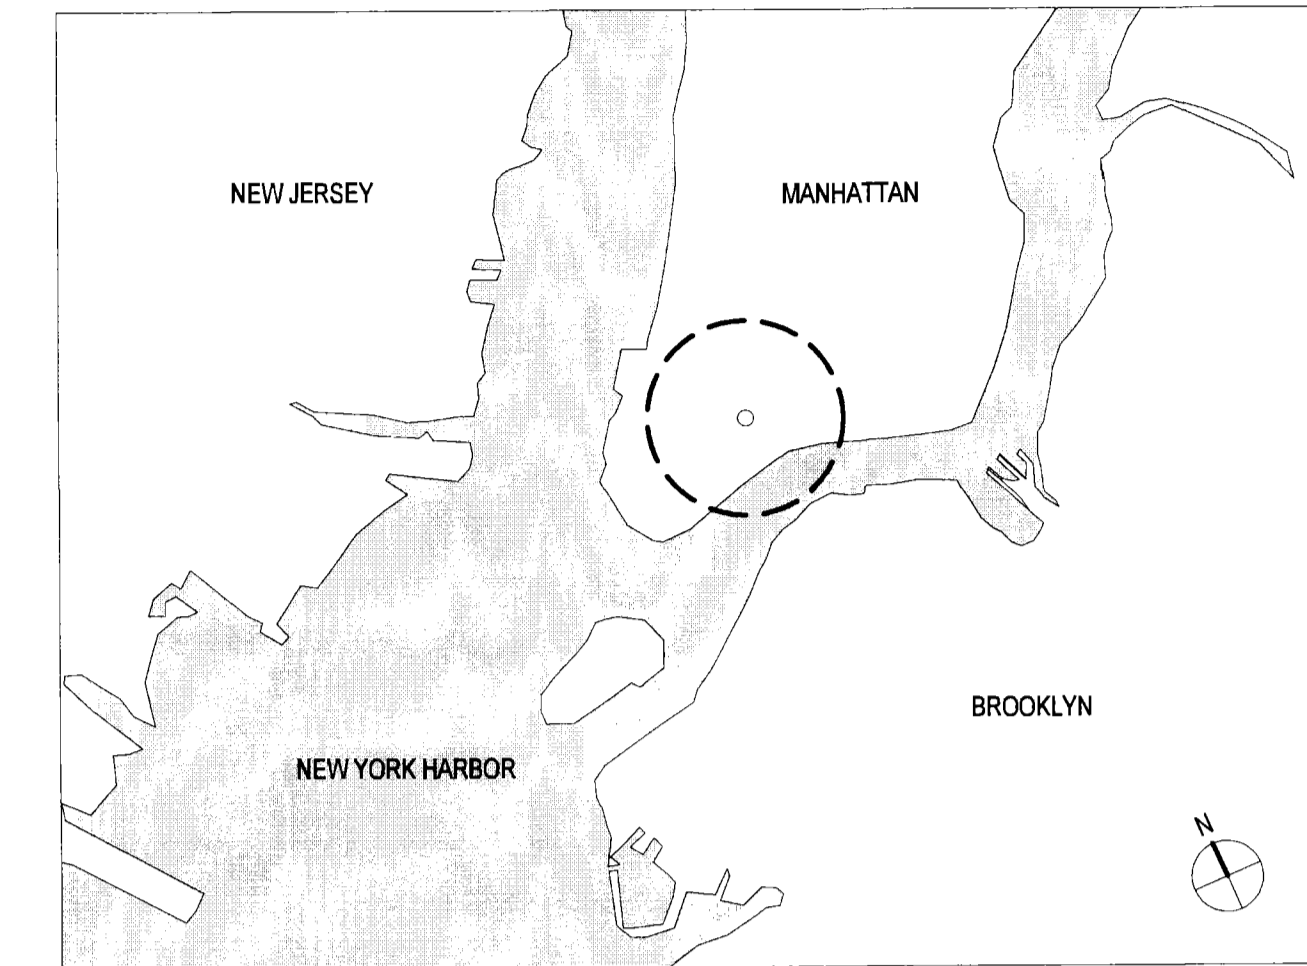


LOCATION MAP

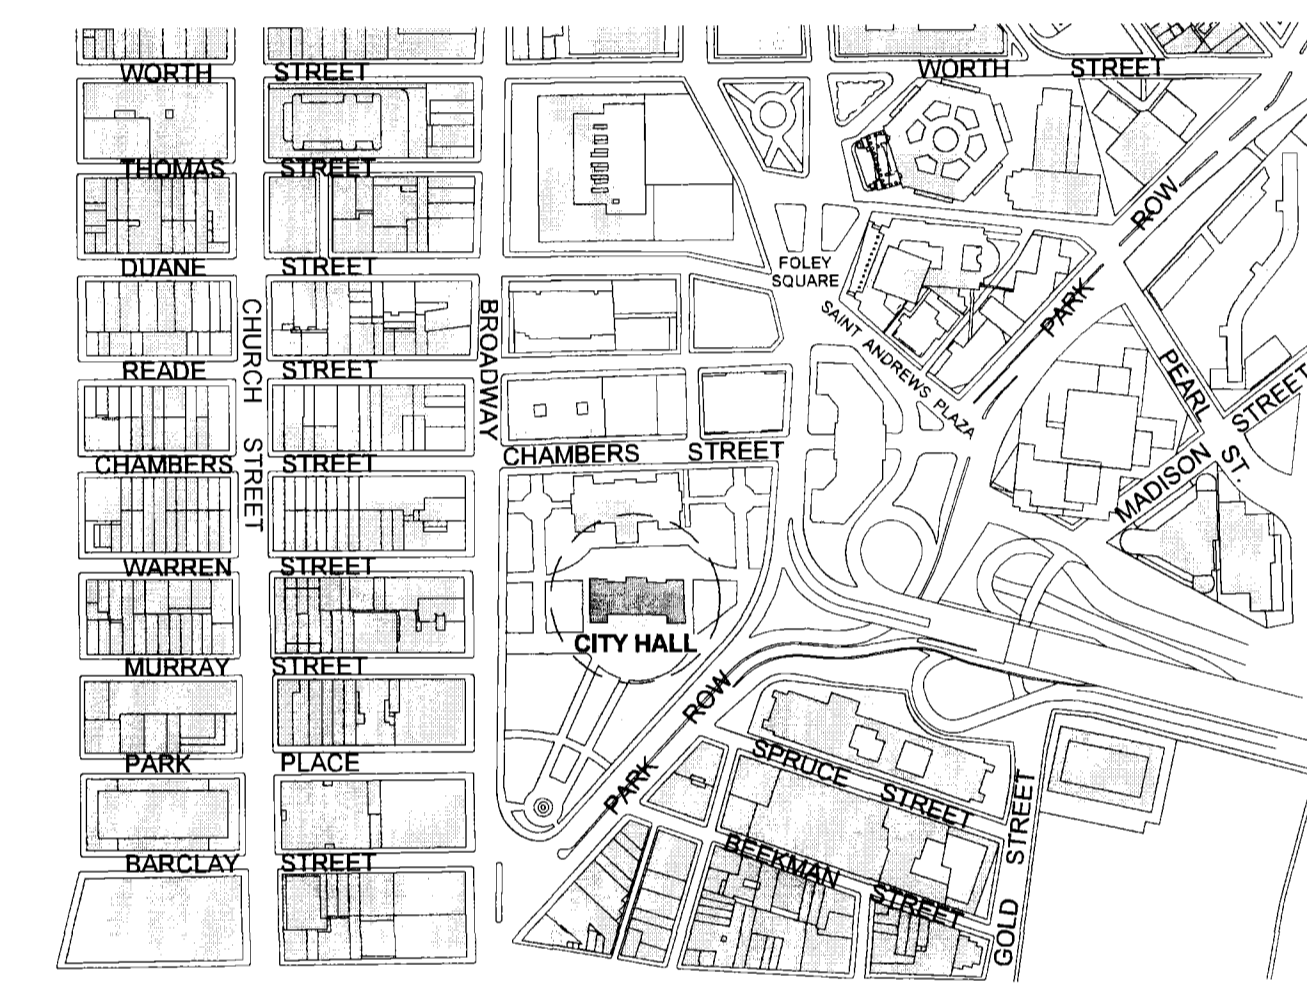


VICINITY MAP

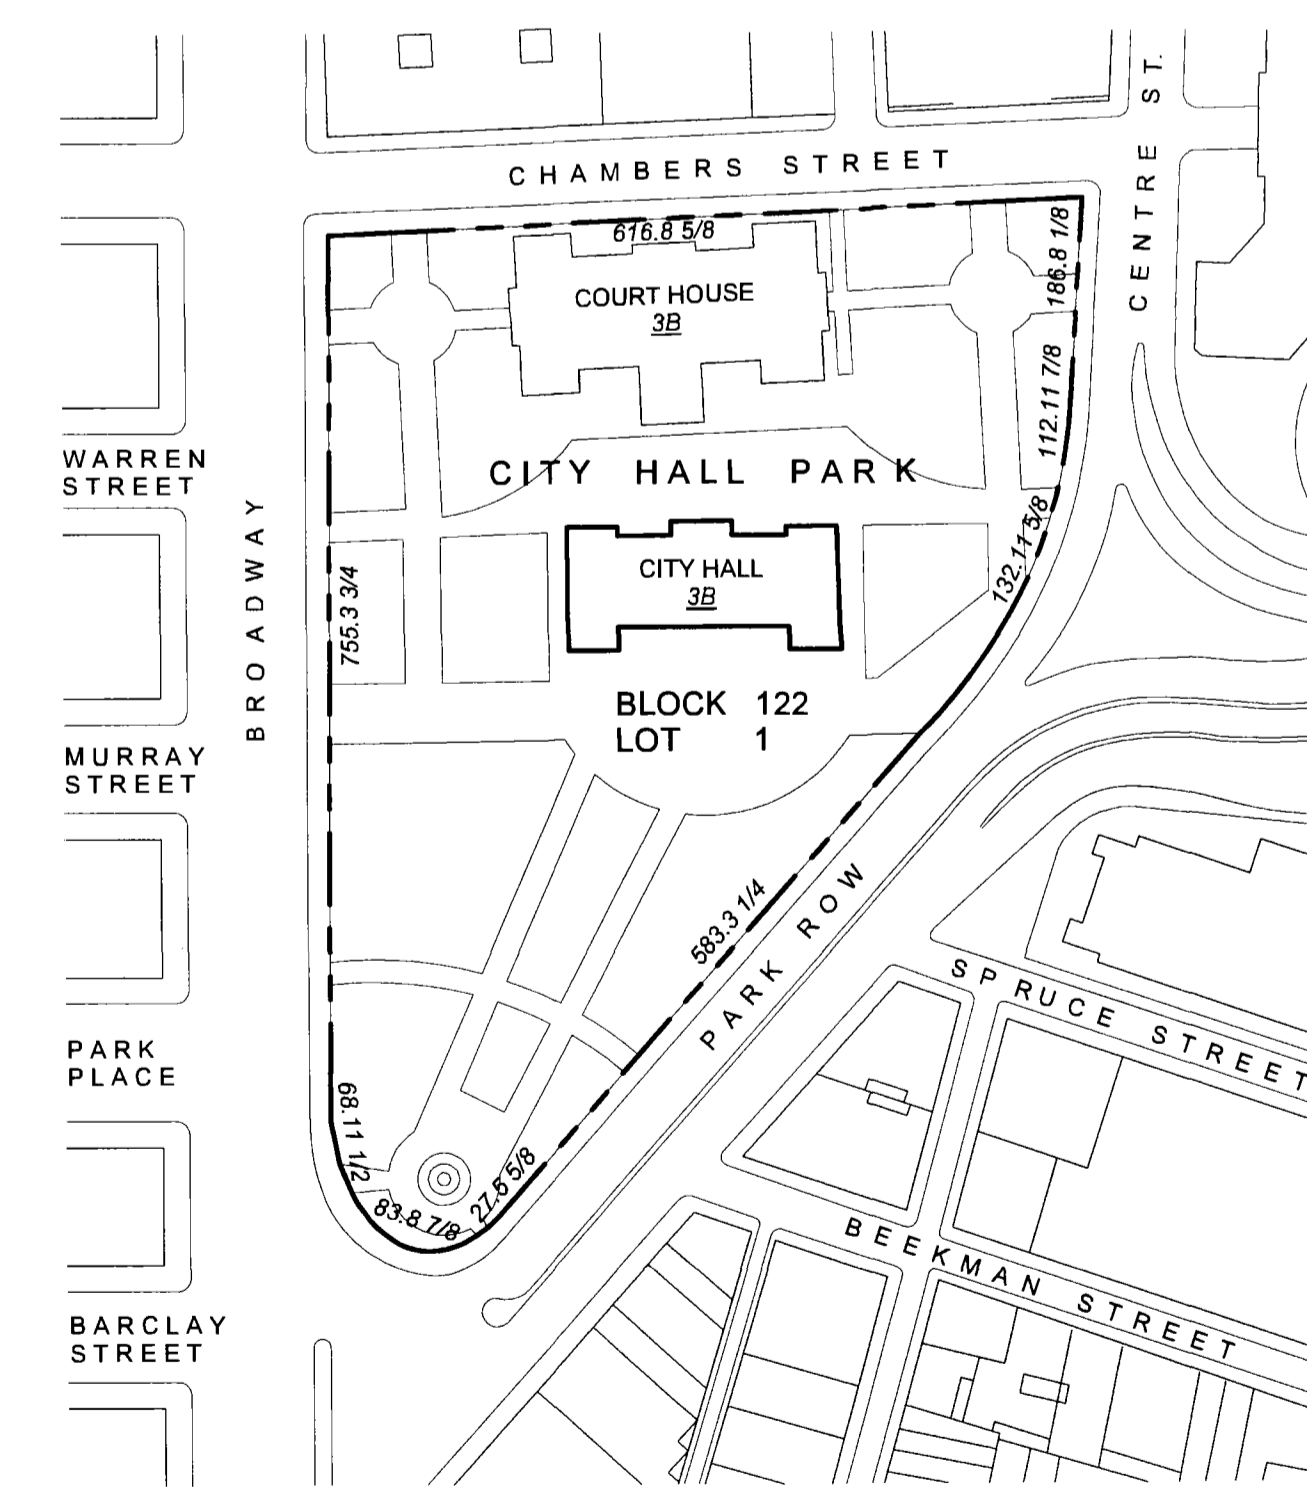

PLOT PLAN

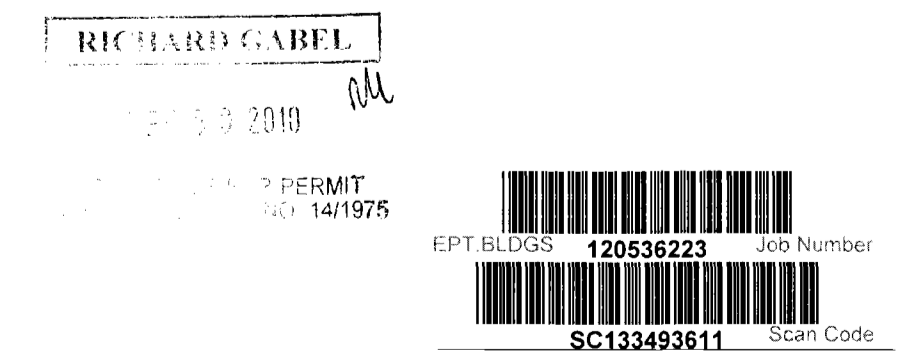

DOB PERMIT APPLICATION

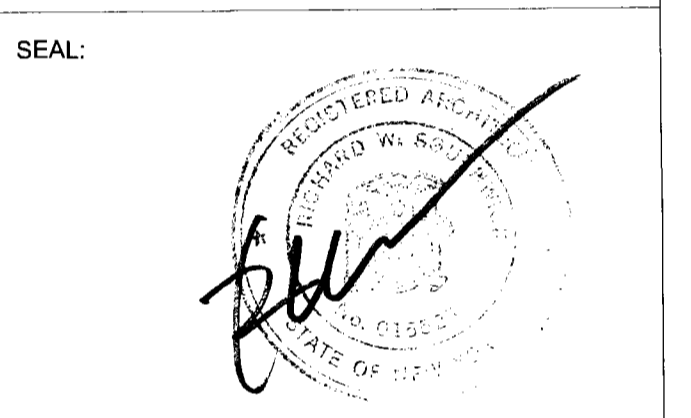

REVISIONS:

Table with columns: NUMBER, DESCRIPTION, DATE. Contains one revision entry.



DIVISION OF STRUCTURES BUREAU OF ARCHITECTURE & ENGINEERING
CAPITAL PROJECT NUMBER: CITYHALL2
PROJECT NAME: Renovation of City Hall Bid Package 2

FOR THE:

General Notes, Drawing List & Location Plans

DRAWN BY: TB SCALE: NTS
CHECKED BY: NA DATE: 10.08.10



G-001.00

SHEET NUMBER: 1 OF 42

ABBREVIATIONS







&	AND	HW	HOT WATER	TR	TREAD
@	AT	HDW	HARDWOOD	TC	TERRA COTTA
AB	ANCHOR BOLT (SEE EB)	ID	INSIDE DIAMETER	T/CONC	TOP OF CONCRETE
A/C	AIR CONDITIONING	IN	INCHES	T/STEEL	TOP OF STEEL
ACM	ASBESTOS CONTAINING MATERIAL	INCL	INCLUDING/INCLUDED	T/WALL	TOP OF WALL
ACP	ACOUSTICAL PANEL (OVER 12x12")	INSUL	INSULATE/INSULATED/INSULATION	T&B	TOP AND BOTTOM
ACT	ACOUSTICAL TILE	INT	INTERIOR	T&G	TONGUE AND GROOVE
ACU	AIR CONDITIONING UNIT	INV	INVERTED/INVERT	TEL	TELEPHONE
AD	ACCESS DOOR (SEE AP)	JB	JUNCTION BOX	TEMP	TEMPERATURE (F UNLESS NOTED)
ADJ	ADJACENT/ADJOINING	JC	JANITORS CLOSET	TEMP GL	TEMPERED GLASS
AFF	ABOVE FINISH FLOOR	JT	JOINT	TF	TEMPORARY FIXTURE
AGG	AGGREGATE	KIT	KITCHEN	THK	THICK/THICKNESS
AHU	AIR HANDLING UNIT	KO	KNOCKOUT	TOS	TOP OF SLAB
ALT	ALTERNATE	L	LONG/LENGTH	TV	TELEVISION
ALUM	ALUMINUM	LAM	LAMINATED	TYP	TYPICAL
AP	ACCESS PANEL (SEE AD)	LAV	LAVATORY	TYP OS	TYPICAL OTHER SIDE
APPD	APPROVED	LCC	LEAD COATED COPPER	TZ	TERRAZZO
APPRX	APPROXIMATE	LB(S)	POUND(S)	UR	URINAL
ARCH	ARCHITECTURAL	LH	LEFT HAND	UC	UNDERCUT
ASPH	ASPHALT	LHR	LEFT HAND REVERSE	UNFIN	UNFINISHED
AUTO	AUTOMATIC	LF	LINEAR FEET	UNGD	UNDERGROUND
AVE	AVENUE	LL	LIVE LOAD	U.O.N.	UNLESS OTHERWISE NOTED
AVG	AVERAGE	LP	LOW POINT	US	UNDER SIDE
BD	BOARD	LT	LIGHT	UTIL	UTILITIES
BEV	BEVELED	LTG	LIGHTING	VL	VOLT
BIT	BITUMINOUS	LULA	LIMITED USE LIMITED APPLICATION	V JT	VEE JOINT
BLDG	BUILDING	LWC	LIGHTWEIGHT CONCRETE	VB	VALVE BOX
BLKG	BLOCKING	MBL	MARBLE	VCB	VINYL COVE BASE
BM	BEAM	MACH	MACHINE	VCT	VINYL COMPOSITION TILE
BOT	BOTTOM	MANUF	MANUFACTURER	VERT	VERTICAL
BRG	BEARING	MAS	MASONRY	VIF	VERIFY IN FIELD
BSMT	BASEMENT	MAT	MATERIAL	VEST	VESTIBULE
BTW	BETWEEN	MAX	MAXIMUM	VIF	VERIFY IN FIELD
		MECH	MECHANICAL	VL	VAULT
CAP	CEILING ACCESS PANEL	MECP	MECHANICAL, ELECTRICAL & PLUMBING	VOL	VOLUME
CB	CATCH BASIN	MEMB	MEMBRANE	VRJT	VERTICAL RELIEF JOINT
C/C	CENTER TO CENTER	MTL	METAL	VRA	VALVE RIG ASSEMBLY
CCTV	CLOSED CIRCUIT TELEVISION	MEZZ	MEZZANINE	VWB	VINYL WALL BASE (NOT COVERED)
CEM	CEMENT	MFR	MANUFACTURE(R)	WVC	WALL COVERING
CFLSH	COUNTER FLASHING	MH	MANHOLE	WD	WOOD
CFM	CUBIC FEET PER MINUTE	MIN	MINIMUM	WGL	WIRE GLASS
CI	CAST IRON	MISC	MISCELLANEOUS	WL	WORK LINE
CIP	CAST IN PLACE	MO	MASONRY OPENING	WP	WORKING POINT
CJ	CONTROL JOINT (SEE EXP JT)	MTD	MOUNTED	WS	WROUGHT STEEL
CLG	CEILING	MTG	MOUNTING	WSCT	WAINSCOTTING
CL	CLOSET	N	NORTH	WT	WEIGHT
CLR	CLEAR/CLEARANCE	NE	NORTHEAST	WWF	WELDED WIRE FABRIC
CM	CONSTRUCTION MANAGER	NIC	NOT IN CONTRACT		
CMU	CONCRETE MASONRY UNIT	NOM	NOMINAL		
COL	COLUMN	NRC	NOISE REDUCTION COEFFICIENT		
CONC	CONCRETE	NTS	NOT TO SCALE		
CONN	CONNECTION	NO	NUMBER		
CONST	CONSTRUCT/CONSTRUCTION	NW	NORTHWEST		
CONT	CONTINUOUS/ CONTINUATION	OA	OVERALL		
CORR	CORRIDOR	OC	ON CENTER(S)		
CARP	CARPET	OD	OUTSIDE DIAMETER		
CT	CERAMIC TILE	OIO	OUT TO OUT		
CU	CONDENSING UNIT	OPG	OPENING		
CW	COLD WATER	OPH	OPPOSITE HAND		
		OPP	OPPOSITE		
DA	DOUBLE ACTING	ORN	ORNAMENTAL		
D	DEEP	OS	OTHER SIDE		
DBL	DOUBLE	OZ	OUNCE		
DIA	DIAMETER	P	PAINT		
DIM	DIMENSION	PA	PUBLIC ADDRESS		
DL	DEAD LOAD	PB	PULL BOX		
DN	DOWN	PCF	POUNDS PER CUBIC FOOT		
DTL	DETAIL	PCST	PRECAST		
DWG	DRAWING	PFAB	PREFABRICATED		
		PIP	POURED IN PLACE		
E	EAST	PL	PLATE		
EA	EACH	PLS	PLASTER		
EB	EXPANSION BOLT (SEE AB)	POL	POLISHED		
EJ	EXPANSION JOINT (SEE CJ)	PPT	PRESSURE PRESERVATIVE TREATED		
EL	ELEVATION	PR	PAIR		
ELEC	ELECTRICAL/ELECTRIC	PSF	POUNDS PER SQUARE FOOT		
ELEV	ELEVATOR	PSI	POUNDS PER SQUARE INCH		
EMER	EMERGENCY	PT	POINT		
ENCL	ENCLOSURE/ENCLOSED	PTD	PAINTED		
ENGR	ENGINEER	PTN	PARTITION		
ENTR	ENTRANCE	PTV	PARTITION		
EQ	EQUAL	PVC	POLYVINYL CHLORIDE		
EQP	EQUIPMENT	P/MT	PAVEMENT		
EWC	ELECTRIC WATER COOLER	PWD	PLYWOOD		
EXCAV	EXCAVATE/EXCAVATION	R	RISER		
EXH	EXHAUST	RCP	REFLECTED CEILING PLAN		
EXP	EXPOSED	RAD	RADIUS		
EXPAN	EXPANDED/EXPANSION	RD	ROOF DRAIN		
EXT	EXTERIOR WP WORKING POINT	REBAR	REINFORCING BAR		
		REF	REFERENCE/REFER TO		
FA	FIRE ALARM	REINF	REINFORCE/REINFORCING		
FAB	FABRICATED	REQ	REQUIRED		
FAP	FLOOR ACCESS PANEL	REV	REVISION		
FD	FIRE DAMPER	RH	RIGHT HANDED (SWING)		
FEC	FIRE EXTINGUISHER CABINET (WITH EXTINGUISHER)	RHR	RIGHT HANDED REVERSE (SWING)		
		RM	ROOM		
F/F	FACE TO FACE (CLEAR DISTANCE)	RO	ROUGH OPENING		
FHC	FIRE HOSE CABINET	RTN	RETURN		
FIN	FINISH	S	SOUTH		
FIX	FIXTURE	SE	SOUTHEAST		
FL	FLOOR/FLOORING	SCHED	SCHEDULE		
FLD	FLOOR DRAIN	SCT	STRUCTURAL CLAY TILE SECTION		
FLG	FLANGE	SEN	SENATE		
FND	FOUNDATION	SFT	STANDARD FIXTURE TYPE		
FO	FACE	SFN	STANDARD FIXTURE NUMBER		
FOM	FACE OF MASONRY	SHT	SHEET		
FP	FIREPROOF	SIM	SIMILAR		
FPM	FEET PER MINUTE	SPEC	SPECIFICATION		
FPNG	FIREPROOFING	SQ	SQUARE		
FPSC	FIRE PROOF SELF CLOSING	SF	SQUARE FEET		
FRT	FIRE RETARDANT TREATED	SS	STAINLESS STEEL		
FS	FLOOR SINK	ST	STREET		
FT	FOOT/FEET	ST STL	STAINLESS STEEL		
		STA	STATION		
G	GAGE (GAUGE)	STAG	STAGGERED/STAGGER		
GAL	GALLON	STC	SOUND TRANSMISSION CLASS		
GALV	GALVANIZED	STD	STANDARD		
GC	GENERAL CONTRACTOR	STL	STEEL		
GL	GLASS	STL DR	STEEL DOOR		
GOV	GOVERNMENT	STL FR	STEEL FRAME		
GPM	GALLONS PER MINUTE	STOR	STORAGE		
GRL	GRILLE	STR	STRUCTURE/STRUCTURAL		
GRTG	GRATING	STR	SELF-TAPPING SCREW		
GYP	GYPSON	STS	SUSPEND/SUSPENDED		
		SUSP	SUSPEND/SUSPENDED		
H	HIGH	SYM	SYMMETRICAL		
HB	HOSE BIB	SYS	SYSTEM		
HDWR	HARDWARE	SW	SOUTHWEST		
HGR	HANGER				
HIST	HISTORIC				
HM	HOLLOW METAL				
HOR	HORIZONTAL				
HP	HIGH POINT				
HR	HOUR				
HS	HOUSE				
HT	HEIGHT				
HRJT	HORIZONTAL RELIEF JOINT				
HTG	HEATING				
HVAC	HEATING, VENTILATION & AIR				

GRAPHIC SYMBOLS

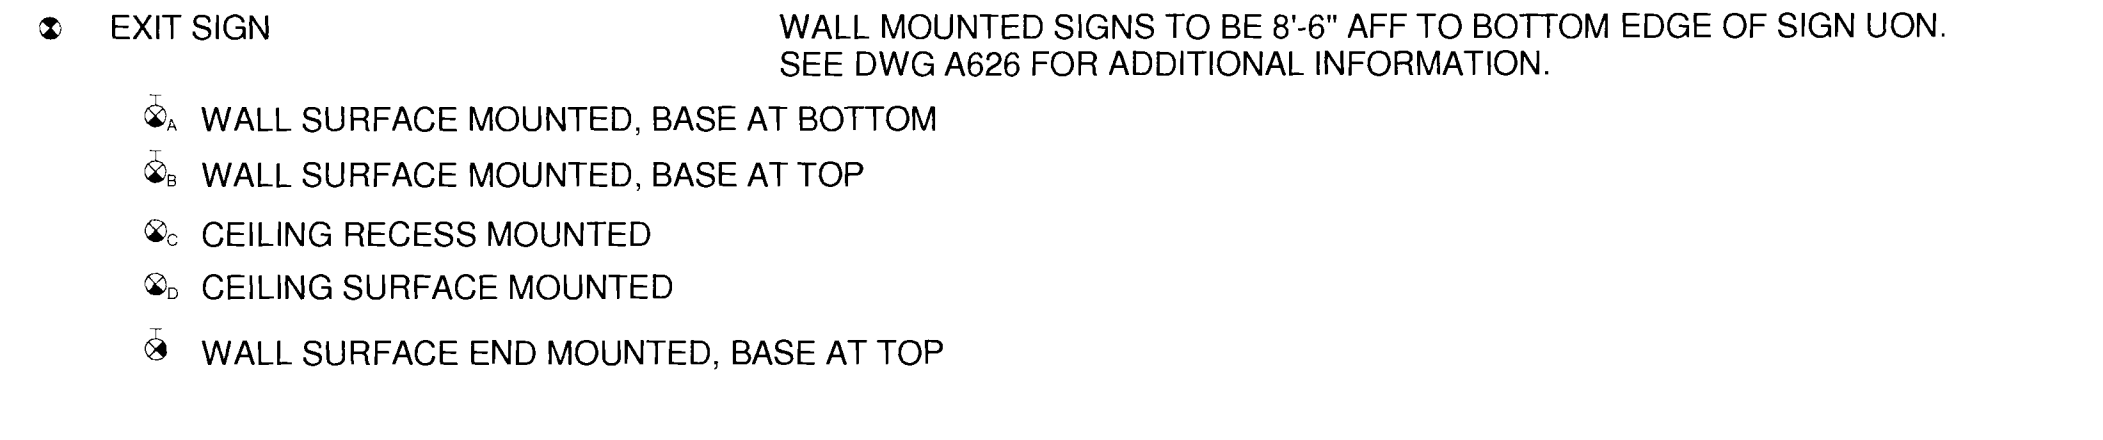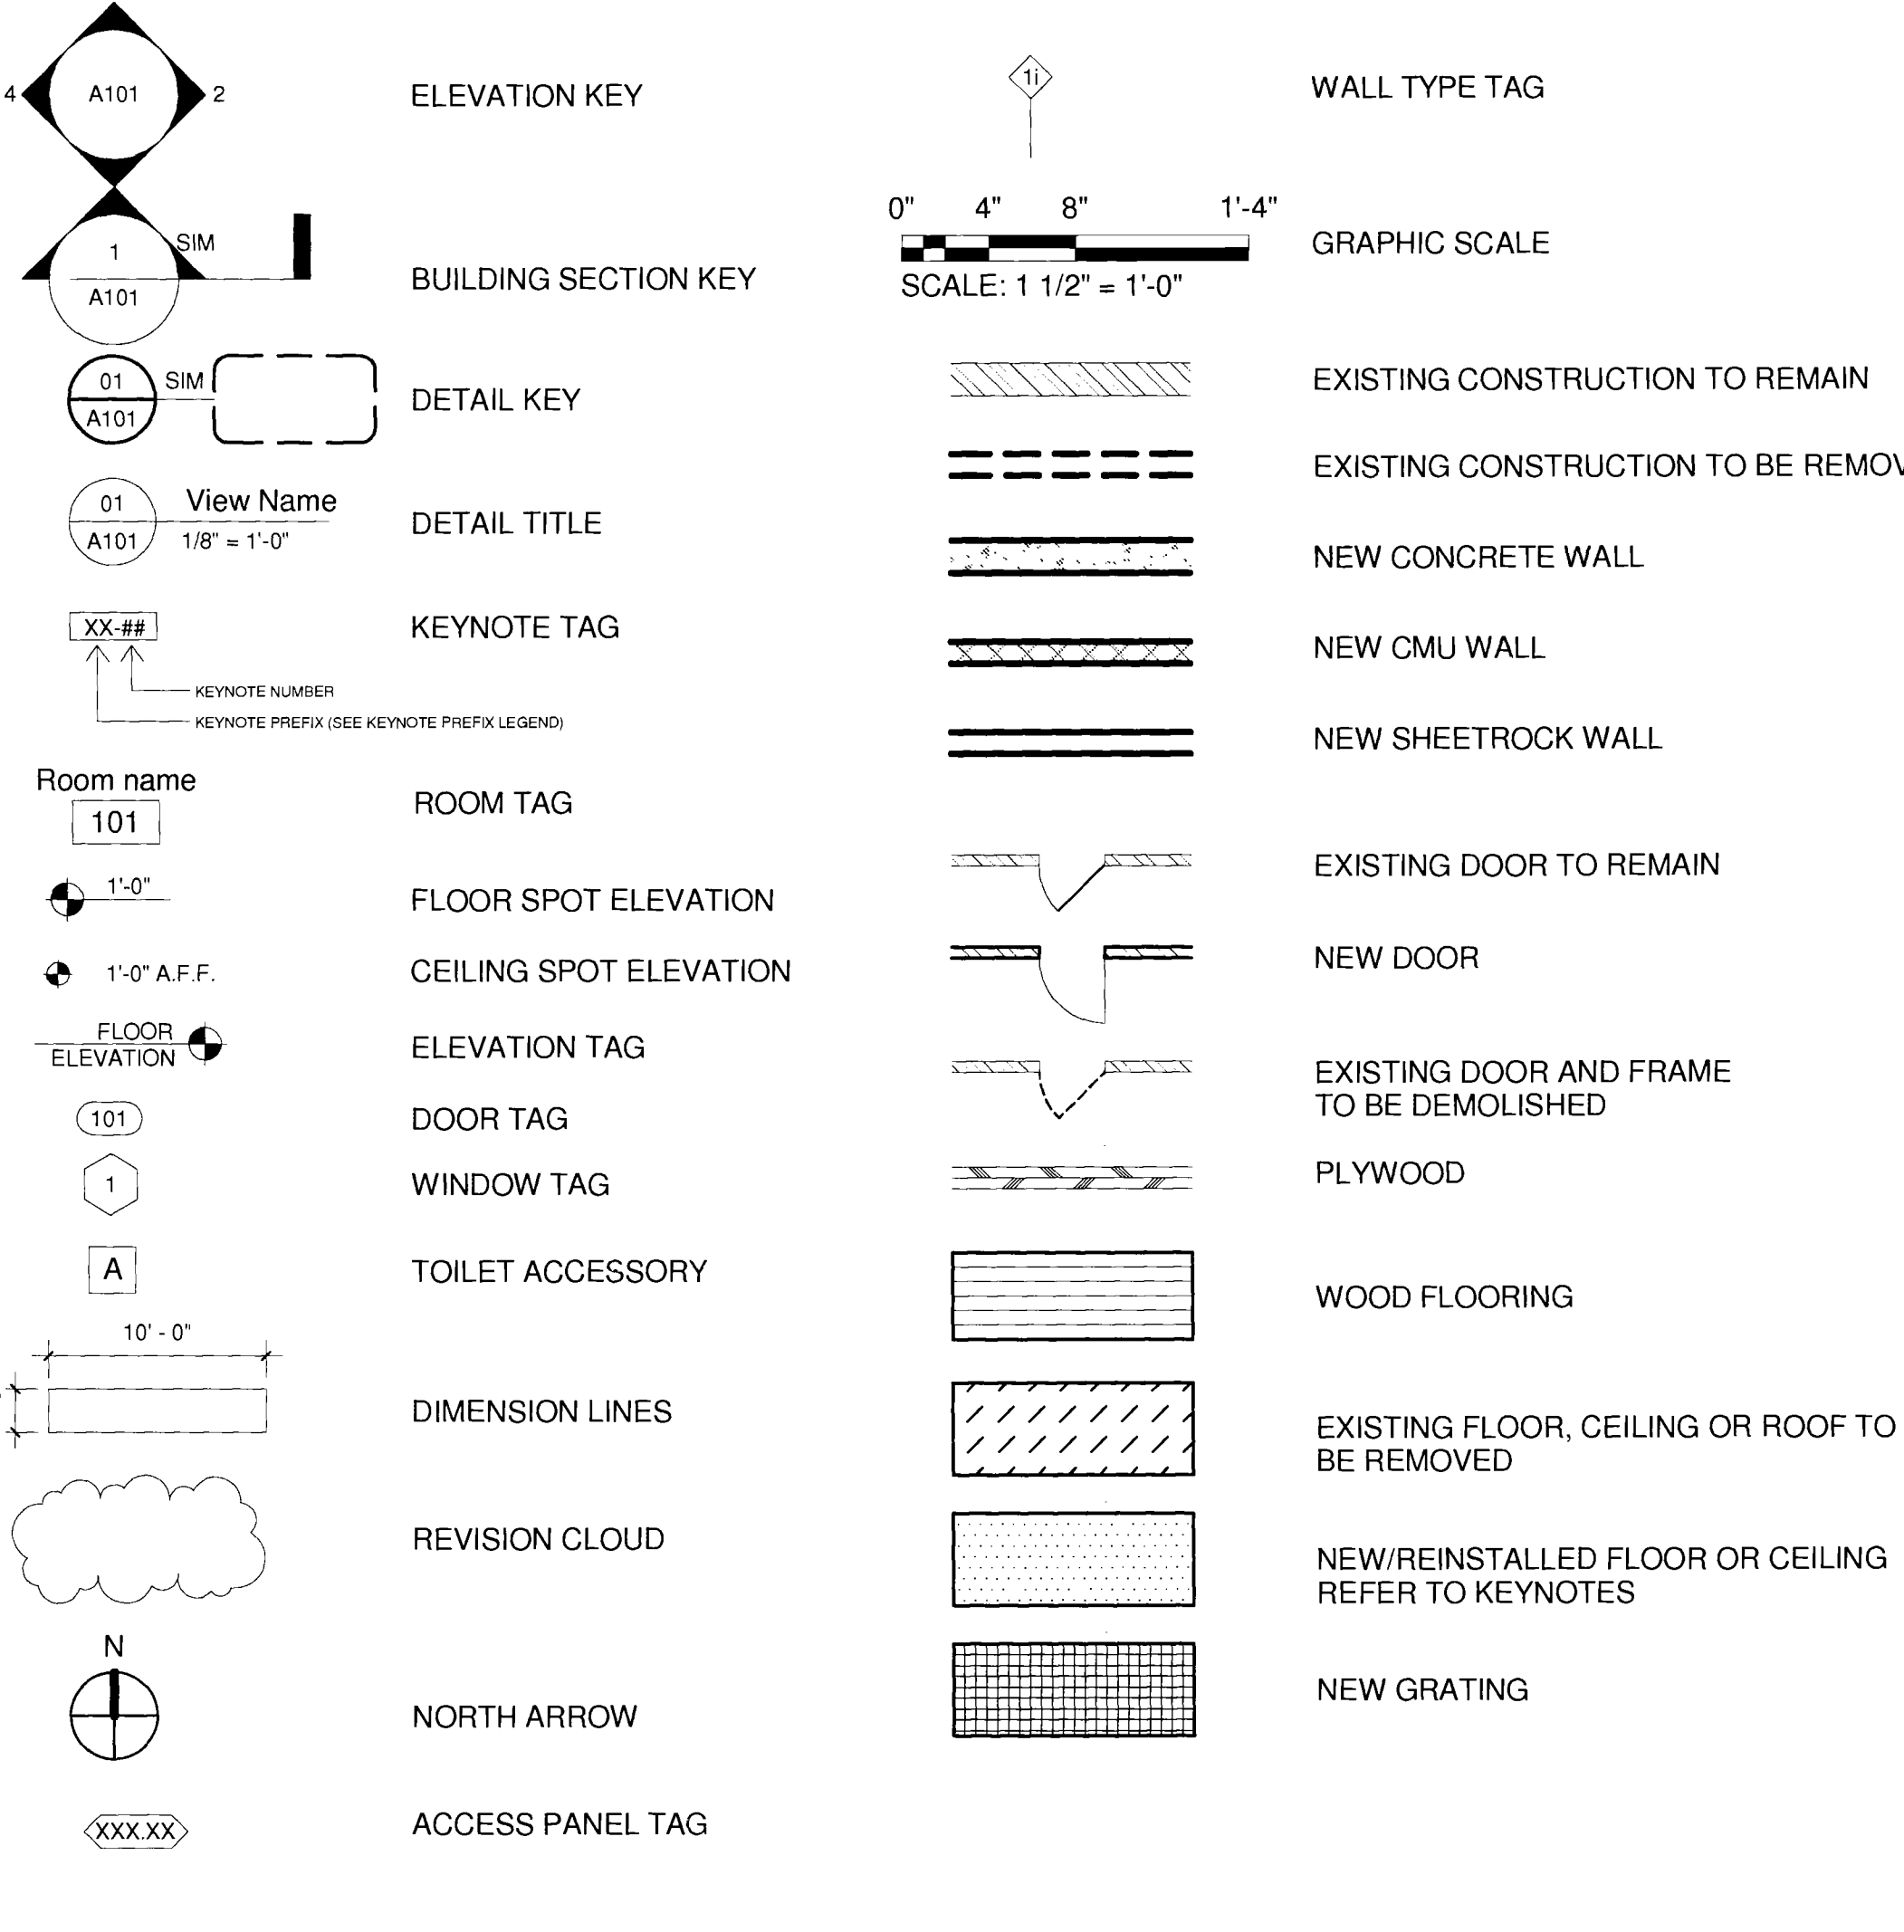

PARTIAL BUILDING OCCUPANCY DURING CONSTRUCTION

THE BUILDING WILL BE PARTIALLY OCCUPIED DURING CONSTRUCTION. SEE OCCUPANCY DIAGRAMS BELOW. THE CONTRACTOR SHALL NOTE THAT CERTAIN OCCUPIED AREAS THAT REQUIRE MAJOR WORK MAY BE VACATED FOR A SHORT PERIOD OF TIME TO ALLOW FOR CONSTRUCTION ACTIVITIES. ALL SUCH REQUESTS SHALL BE BROUGHT TO THE ATTENTION OF THE MAYOR'S OFFICE AT THE COMMENCEMENT OF THE PROJECT FOR SCHEDULING.

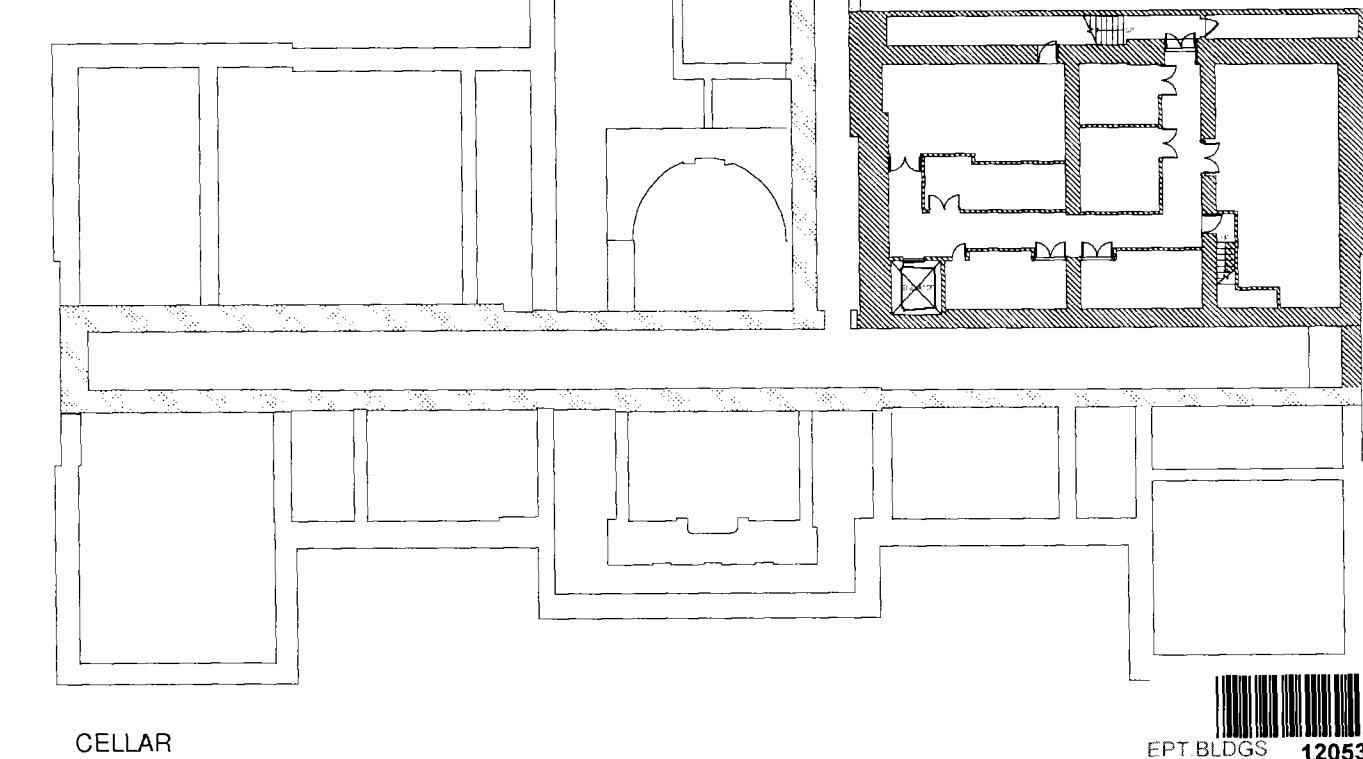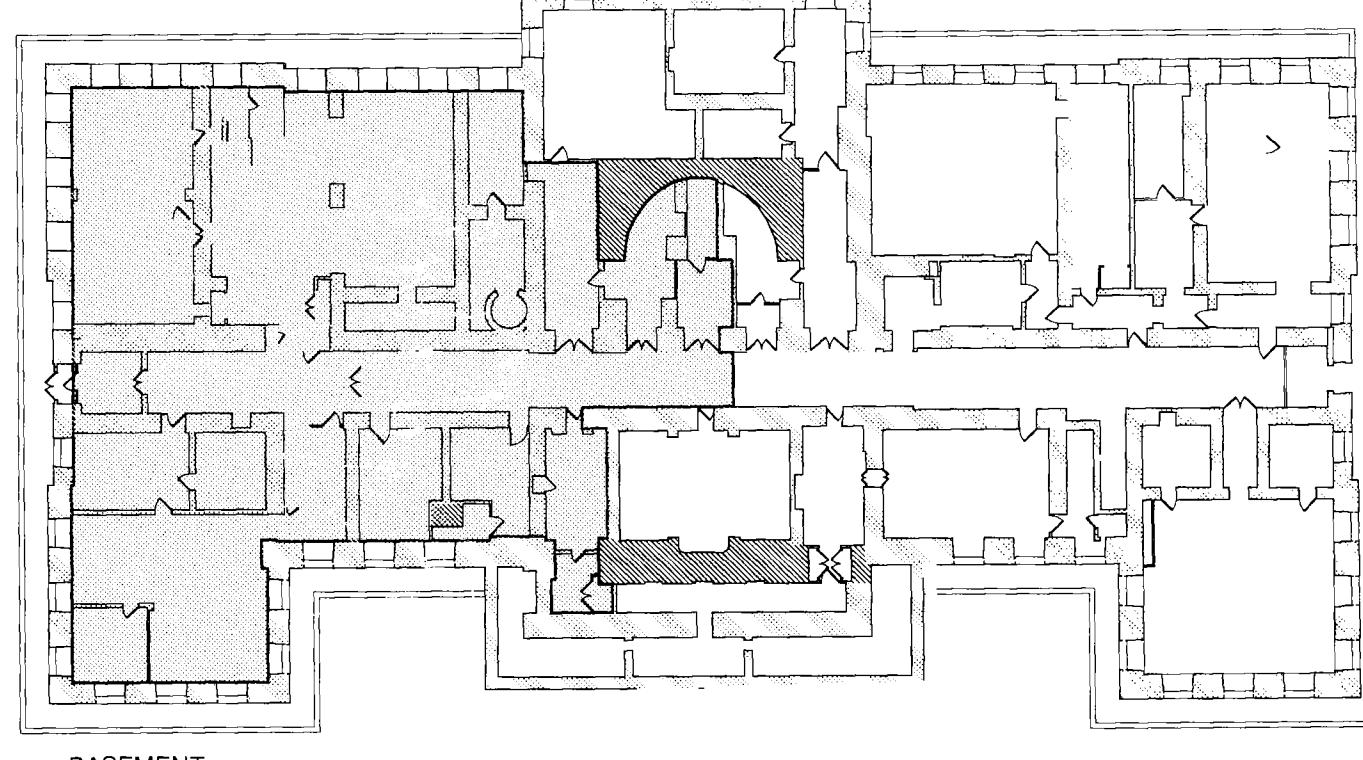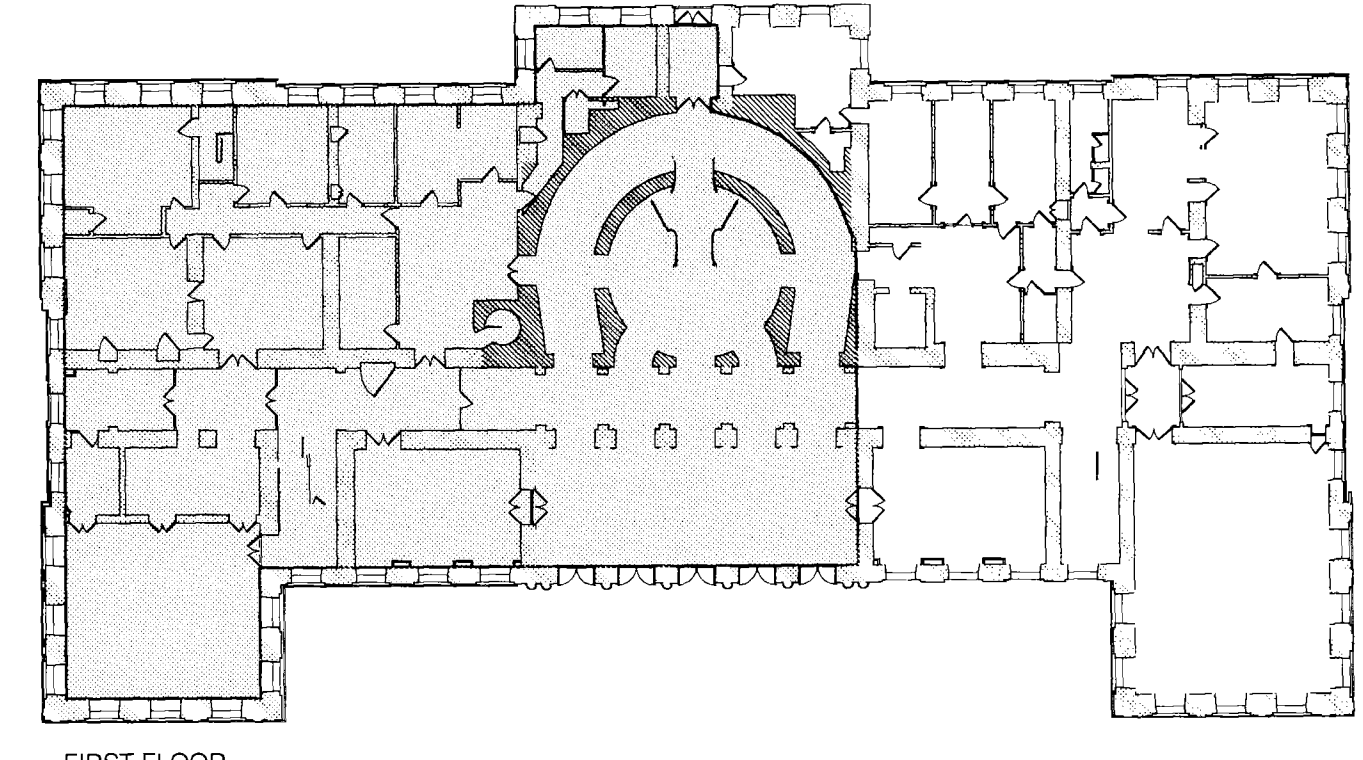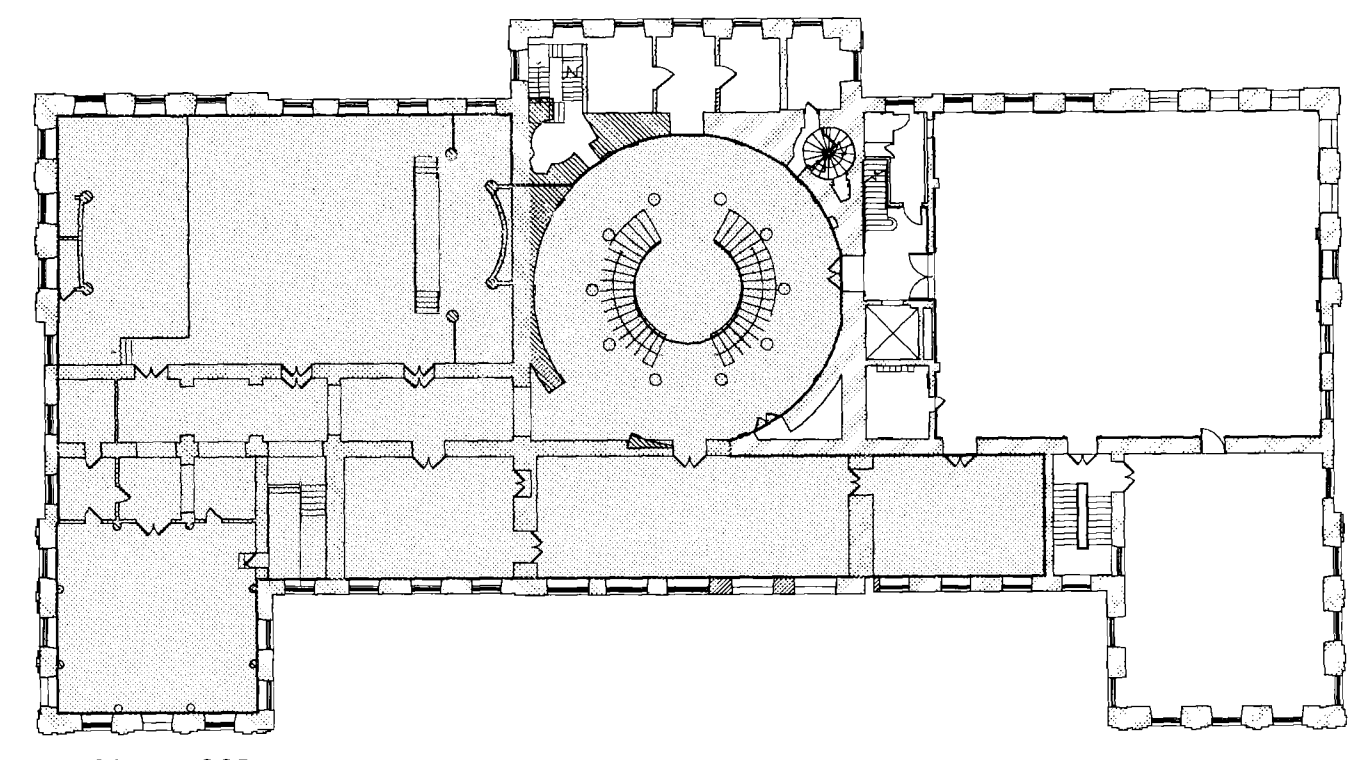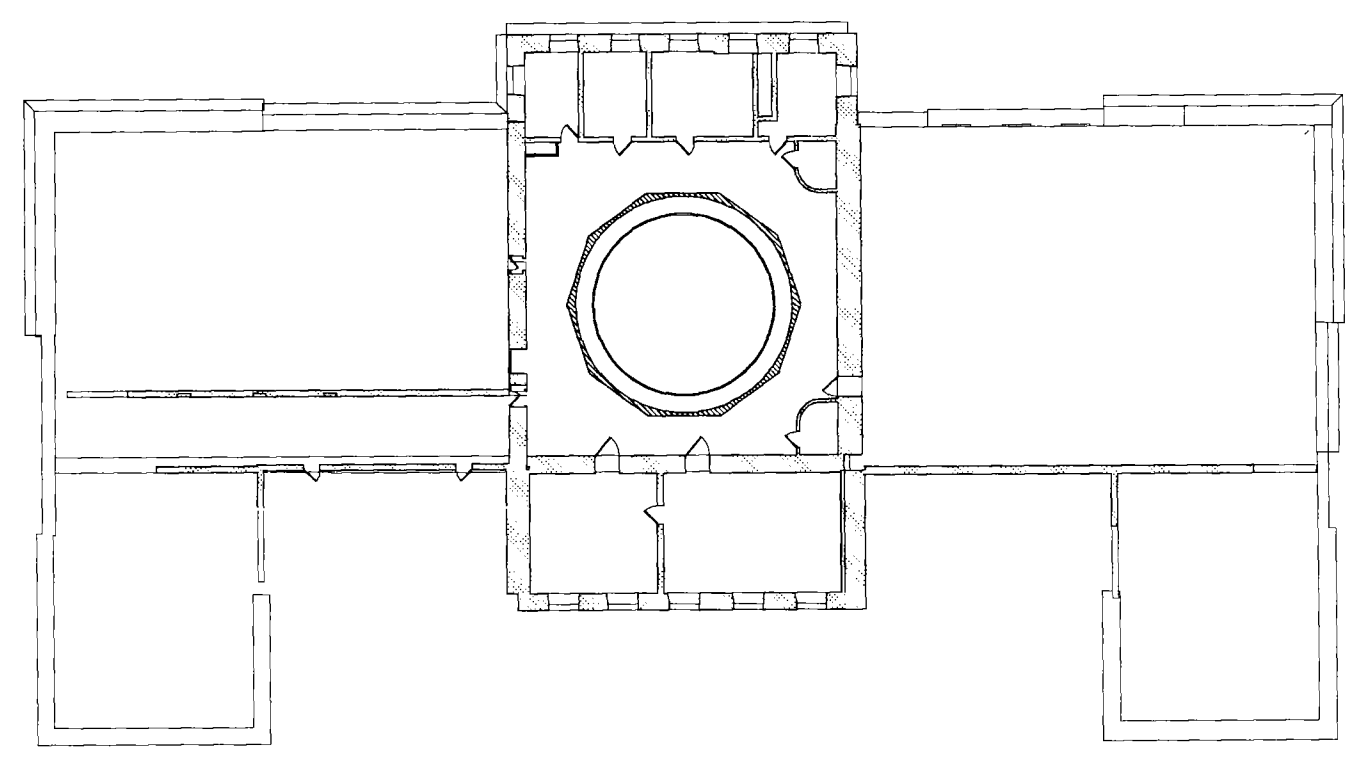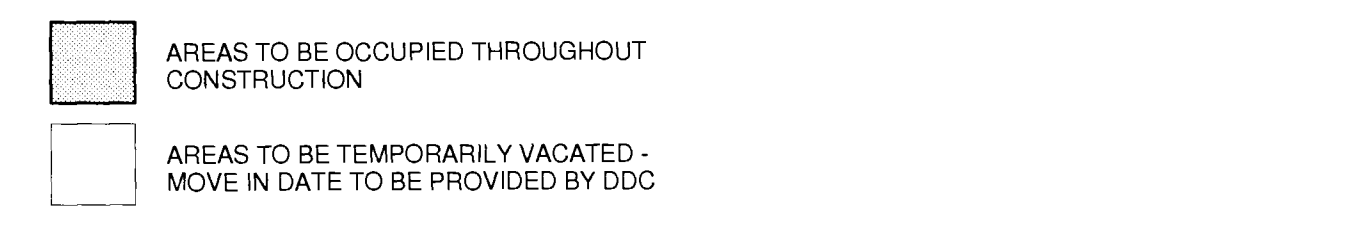

2 Occupied spaces
1/32" = 1'-0"

DOB PERMIT APPLICATION

BEYER BLINDER
Architects & Planners LLP
41 East 110th Street
New York, NY 10003
Tel: 212.777.7800
Fax: 212.475.7424

SEAL: *[Signature]*

REVISIONS:

NUMBER	DESCRIPTION	DATE

NEW YORK CITY DEPARTMENT OF DESIGN + CONSTRUCTION

DIVISION OF STRUCTURES
BUREAU OF ARCHITECTURE & ENGINEERING

CAPITAL PROJECT NUMBER:
CITYHALL2

PROJECT NAME:
Renovation of City Hall
Bid Package 2

FOR THE:

DRAWING TITLE:
Abbreviations, Symbols & Building Occupancy

DRAWN BY: TB SCALE: NTS
CHECKED BY: NA DATE: 10.08.10

DRAWING NUMBER:
G-002.00

SHEET NUMBER:
2 OF 42

HANDICAPPED ACCESSIBILITY NOTES:

1. PROPOSED WORK TO COMPLY WITH APPLICABLE REQUIREMENTS OF ANSI A117.1-86, LOCAL LAW #58/87, SECTION 27-231 AND SUBARTICLE 2 OF ARTICLE 2 OF SUBCHAPTER 4 FOR HANDICAPPED ACCESS.

2. CONTROLS AND OPERATING MECHANISMS SHALL BE OPERABLE WITH ONE HAND AND SHALL NOT REQUIRE TIGHT GRASPING, PINCHING OR TWISTING OF THE WRIST, AS PER RS 4-6, 4.25.4.

3. ACCESSIBLE ROUTES TO BE PROVIDED BETWEEN FACILITIES ON THE GROUND FLOOR, PROVIDING A MINIMUM OF 36 INCHES OF WIDTH ALONG THE ACCESSIBLE ROUTE AS PER RS 4-6, 4.3.1 AND A MINIMUM OF 32 INCHES OF WIDTH AT DOORWAYS, AS PER RS 4-6, 4.13.5.

4. SMOKE DETECTORS TO BE INSTALLED WHICH MEET THE REQUIREMENTS OF SECTION 27-292.9(b), ADAPTABLE TO PROVIDE FLASHING LIGHTS ARRANGED TO FLASH IN CONJUNCTION WITH AUDIBLE SMOKE DETECTOR ALARMS.

4.2. SPACE ALLOWANCES AND REACH RANGES
a. A CLEAR FLOOR SPACE OF 30"x48" SHALL BE PROVIDED FOR FORWARD AND PARALLEL APPROACHES (SEE FIGURE 4)
b. 60" DIAMETER SPACE SHALL BE PROVIDED FOR WHEELCHAIR TURNING (SEE FIGURE 3)

4.8. RAMPS
a. THE MAXIMUM SLOPE OF A RAMP IN NEW CONSTRUCTION SHALL BE 1:12 THE MAXIMUM RISE OF ANY SLOPE SHALL BE 30"
b. THE CLEAR WIDTH (BETWEEN HANDRAILS) SHALL BE 36"
c. LANDINGS LOCATED AT THE BOTTOM AND TOP OF EACH RUN SHALL BE AT LEAST AS WIDE AS THE WIDEST PART OF THE RAMP AND THE LENGTH SHALL BE 60" CLEAR
d. DIRECTION CHANGES AT LANDINGS SHALL HAVE A MINIMUM SIZE OF 60"x60"
e. IF A DOORWAY IS LOCATED AT A LANDING, THEN THE AREA IN FRONT OF THE DOORWAY SHALL COMPLY WITH 4.13.6

4.8.5. HANDRAILS
a. PROVIDE HANDRAILS ON BOTH SIDES OF RAMP SEGMENTS
b. THE CLEAR SPACE BETWEEN THE HANDRAIL AND THE WALL SHALL BE 1-1/2"
c. THE GRIPPING SURFACE SHALL BE 1-1/4" OR 1-1/2" DIAMETER
d. THE TOP OF THE GRIPPING SURFACE SHALL BE MOUNTED BETWEEN 30" AND 34" ABOVE THE RAMP SURFACE

4.13. DOORS
a. DOORWAYS SHALL HAVE A MINIMUM CLEAR OPENING OF 32" WITH THE DOOR OPEN 90 DEGREES MEASURED BETWEEN THE FACE OF THE DOOR AND THE STOP. FOR CLEARWAY WIDTH AND DEPTH, SEE FIGURE 24
b. FOR MANEUVERING CLEARANCES AT DOORS, SEE FIGURE 25

4.15. DRINKING FOUNTAINS
a. THE SPOUT HEIGHT SHALL BE NO HIGHER THAN 36" ABOVE THE FLOOR.

4.1. WATER CLOSETS
a. THE HEIGHT OF WATER CLOSETS SHALL BE 17" TO 19" ABOVE THE FLOOR TO THE TOP OF THE TOILET SEAT. FOR HEIGHTS, CONFIGURATIONS AND GRAB BARS, SEE FIGURES 28 AND 29, FOR STALLS SEE FIGURE 30

4.19. LAVATORIES AND SINKS
a. LAVATORIES SHALL BE MOUNTED WITH A CLEARANCE OF 29" FROM THE FLOOR TO THE BOTTOM OF THE APRON, KNEE AND TOE CLEARANCE TO COMPLY WITH FIGURE 31
b. SINKS SHALL BE MOUNTED WITH THE COUNTER OR RIM NO HIGHER THAN 34" FROM THE FLOOR
c. A CLEAR FLOOR SPACE OF 30"x48" SHALL BE PROVIDED IN FRONT OF A LAVATORY OR SINK TO ALLOW A FORWARD APPROACH AND TO COMPLY WITH FIGURE 32
d. HOT WATER AND DRAIN PIPES UNDER LAVATORIES OR SINKS SHALL BE INSULATED.

5. PROPOSED STORAGE FACILITIES SUCH AS CABINETS, SHELVES, CLOSETS AND DRAWERS SHALL COMPLY WITH APPLICABLE REQUIREMENTS OF LOCAL LAW #58/87 AND RS 4-6, 4.23.

5.21. CLEAR FLOOR SPACE OF A MINIMUM OF 30 INCHES BY 48 INCHES IS PROVIDED FOR APPROACH TO ALL STORAGE FACILITIES

5.22. STORAGE SPACES SHALL COMPLY WITH AT LEAST ONE OF THE REACH RANGES SPECIFIED IN 4.6, 4.2.5 AND 4.2.6. CLOTHES RODS SHALL BE A MAXIMUM OF 54 INCHES FROM THE FLOOR.

5.23. HARDWARE FOR STORAGE FACILITIES SHALL BE OPERABLE WITH ONE HAND AND SHALL NOT REQUIRE TIGHT GRASPING, PINCHING OR TWISTING OF THE WRIST.

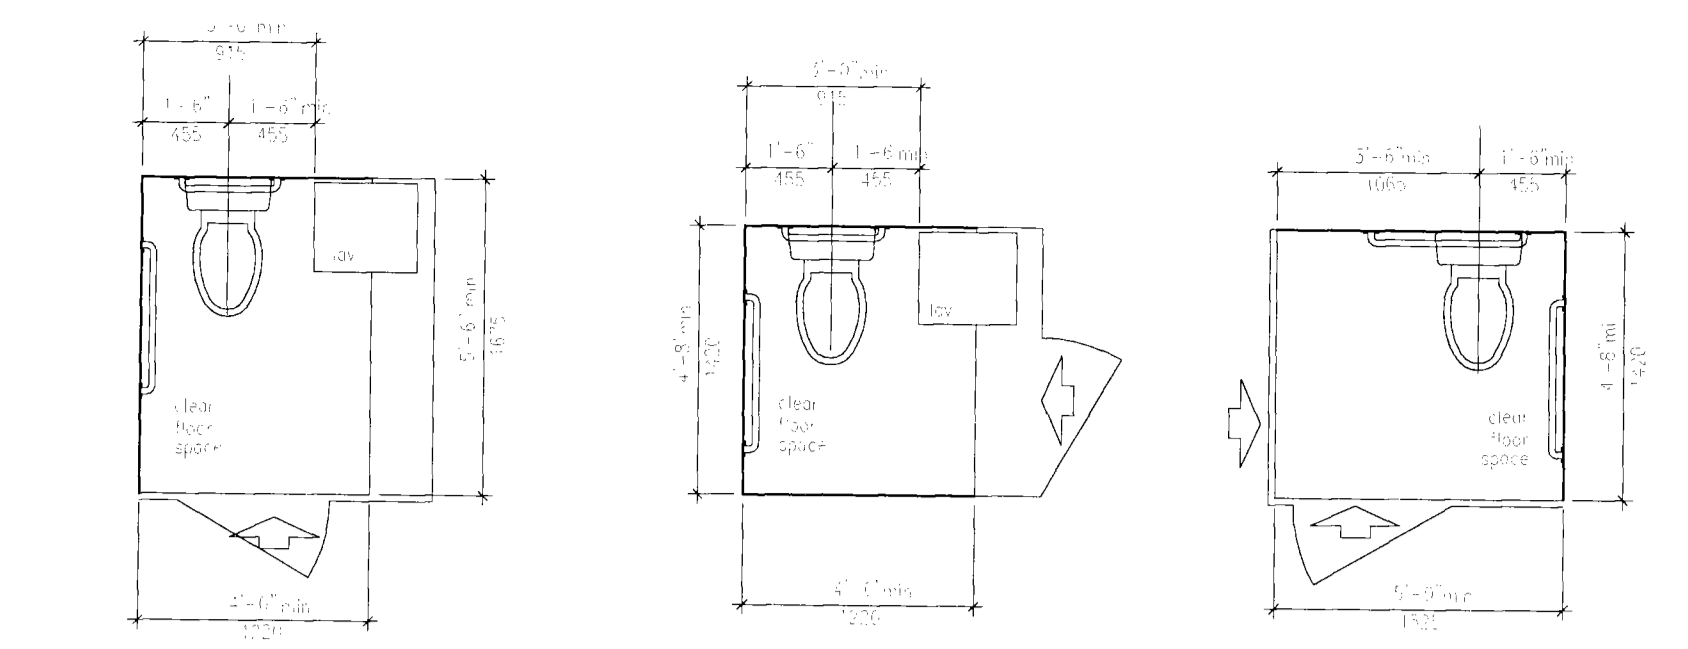


Fig. 28
Clear floor space at Water Closets

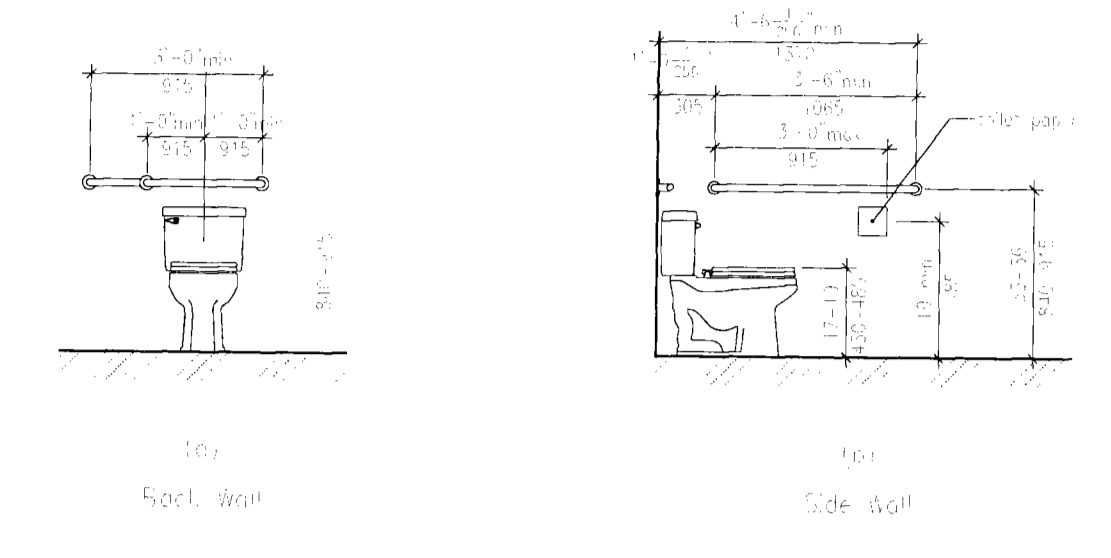


Fig. 29
Side wall

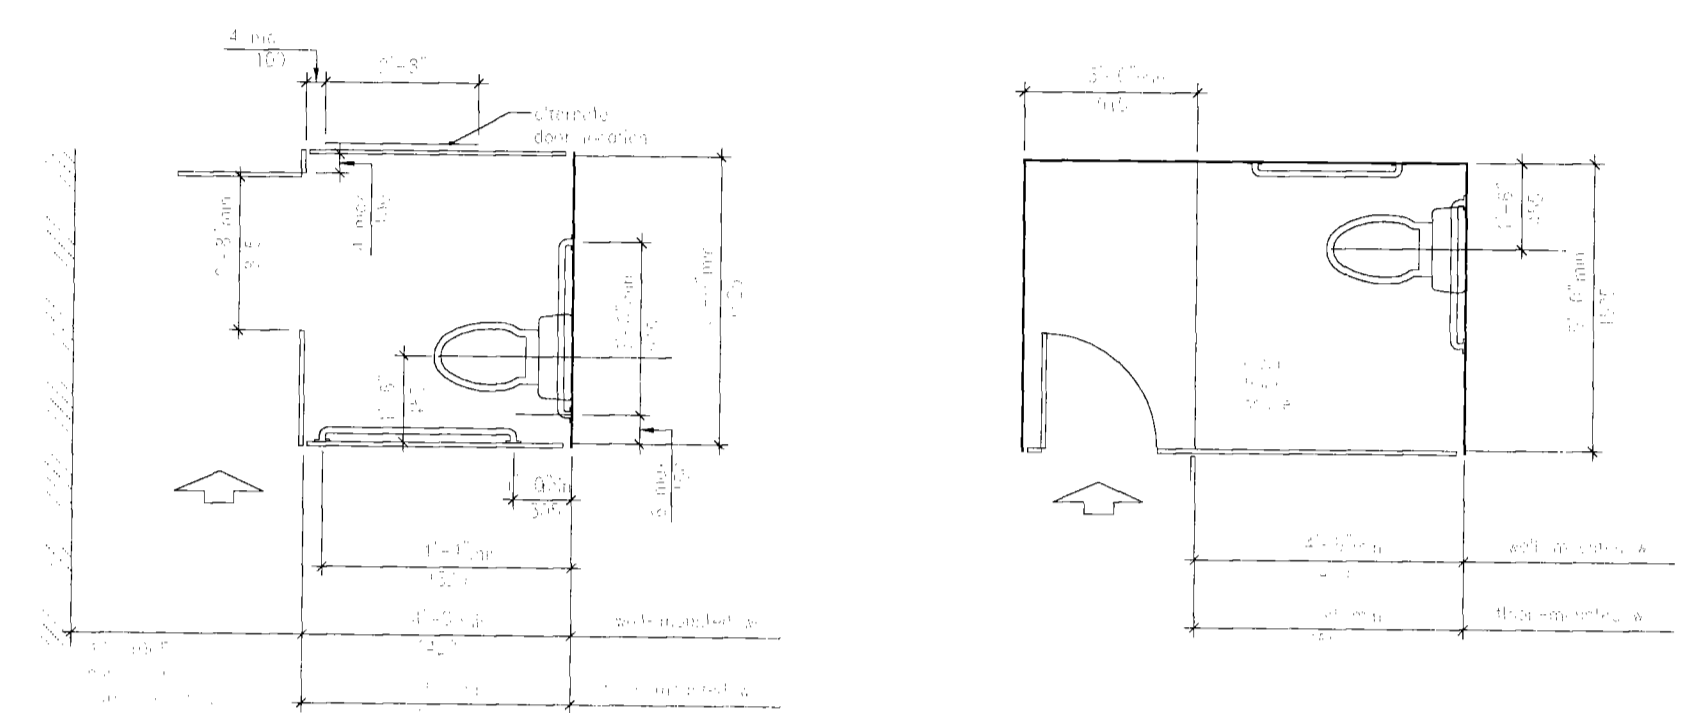


Fig. 31
Grab bars on Water Closets

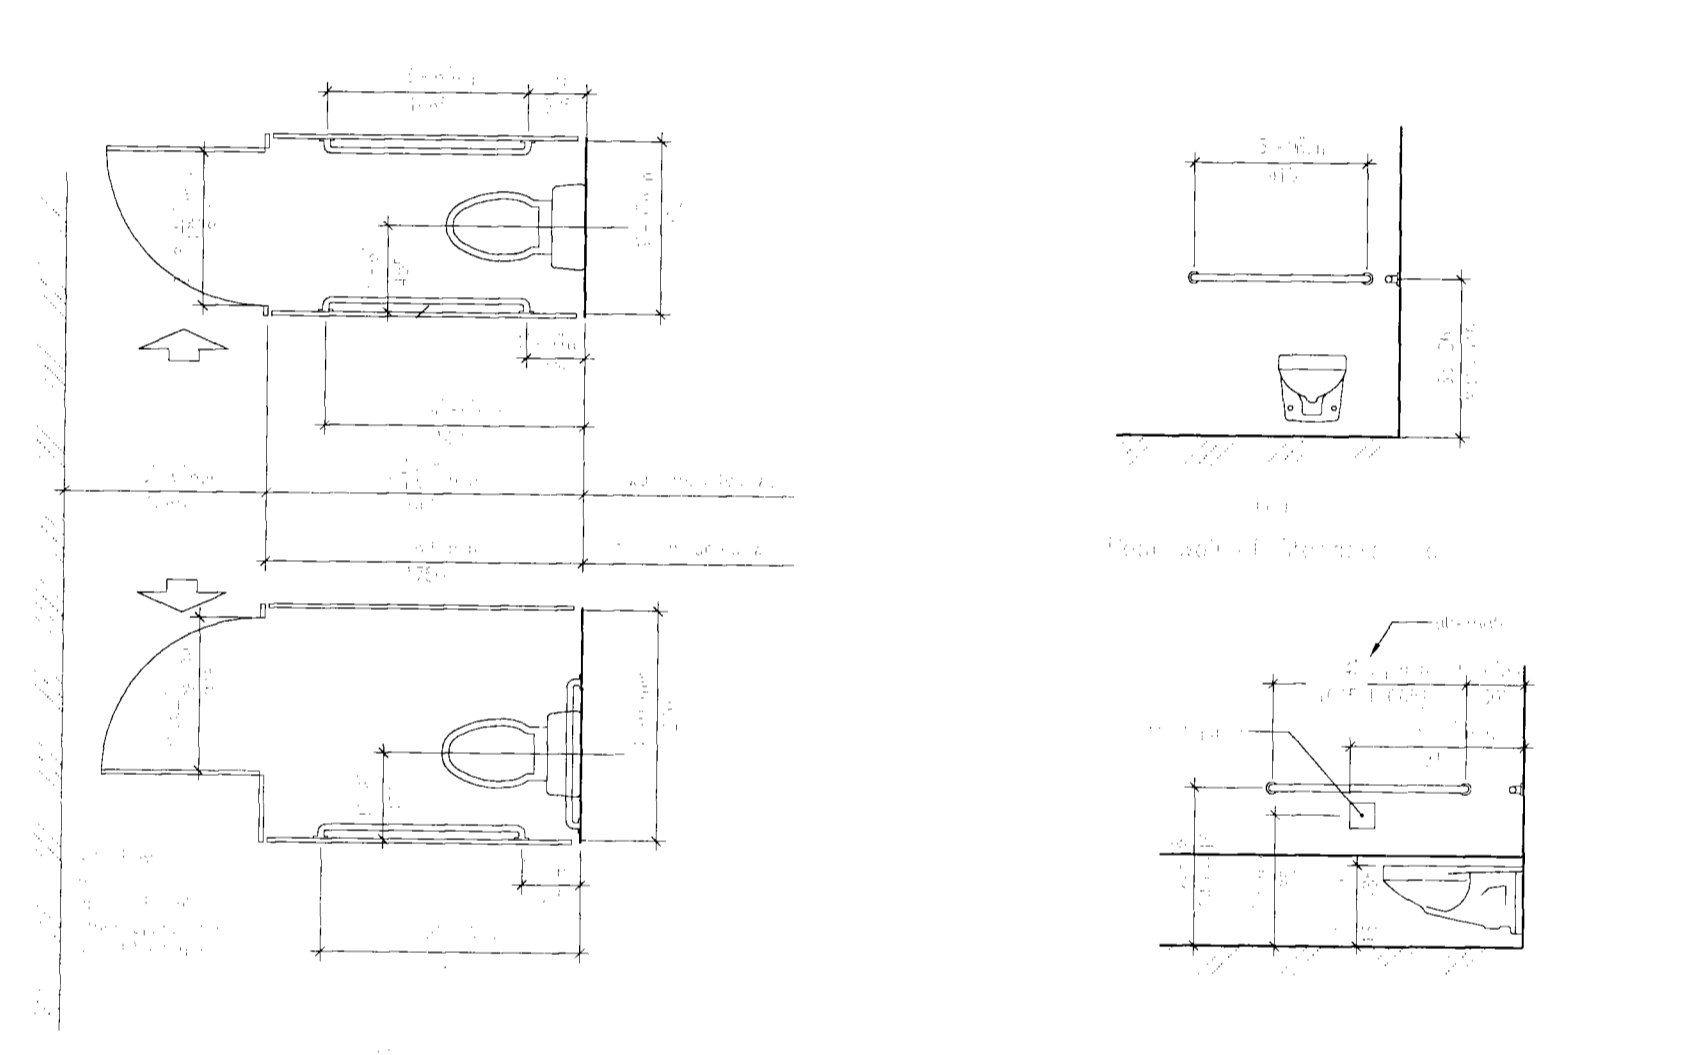


Fig. 32
Forward Approach

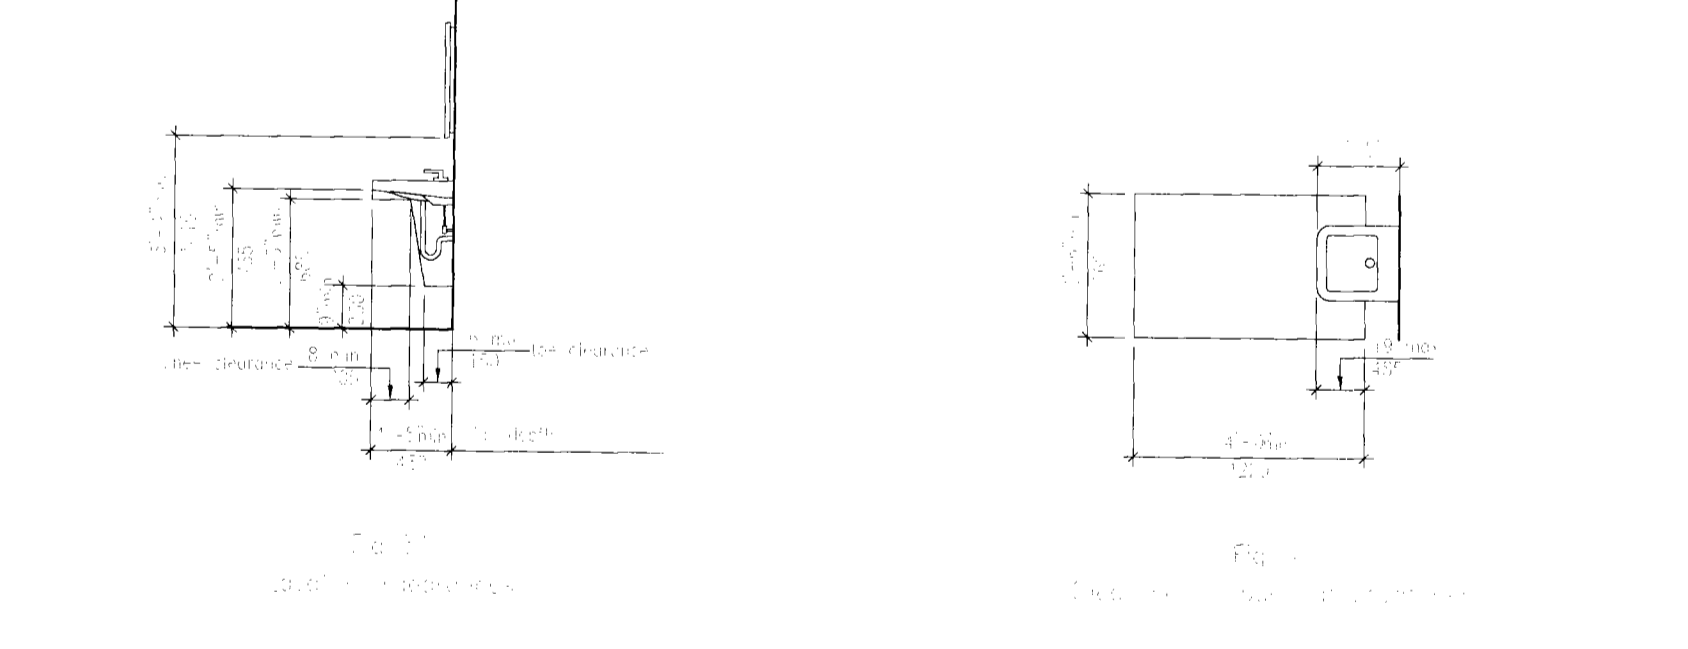


Fig. 33
Parallel Approach

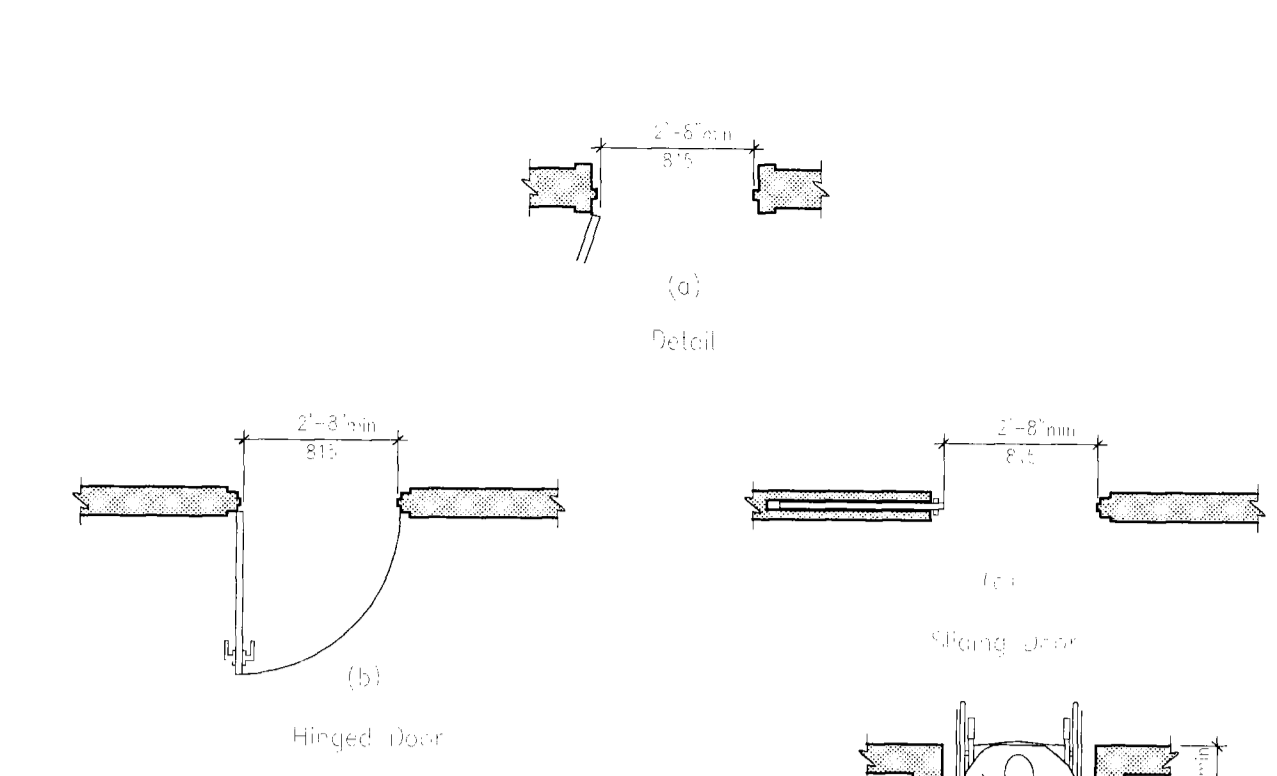


Fig. 34
Hinged door

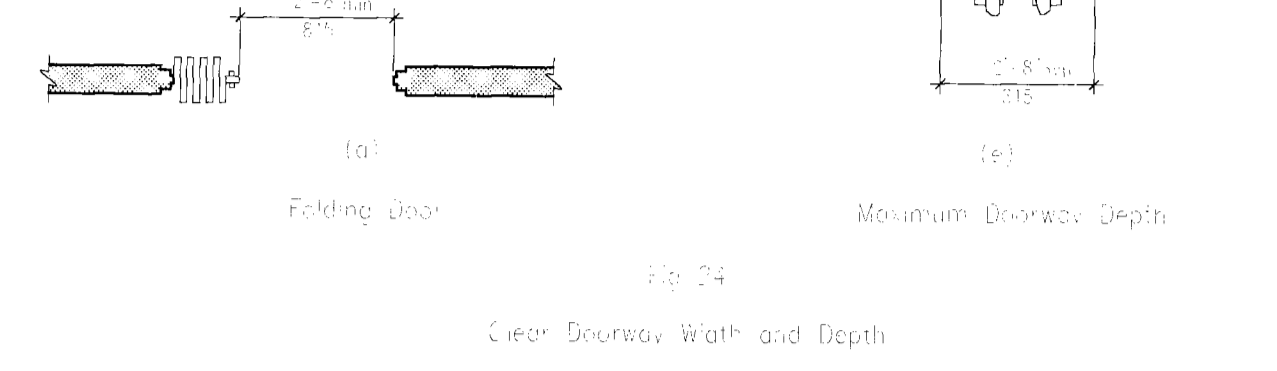


Fig. 35
Folding door

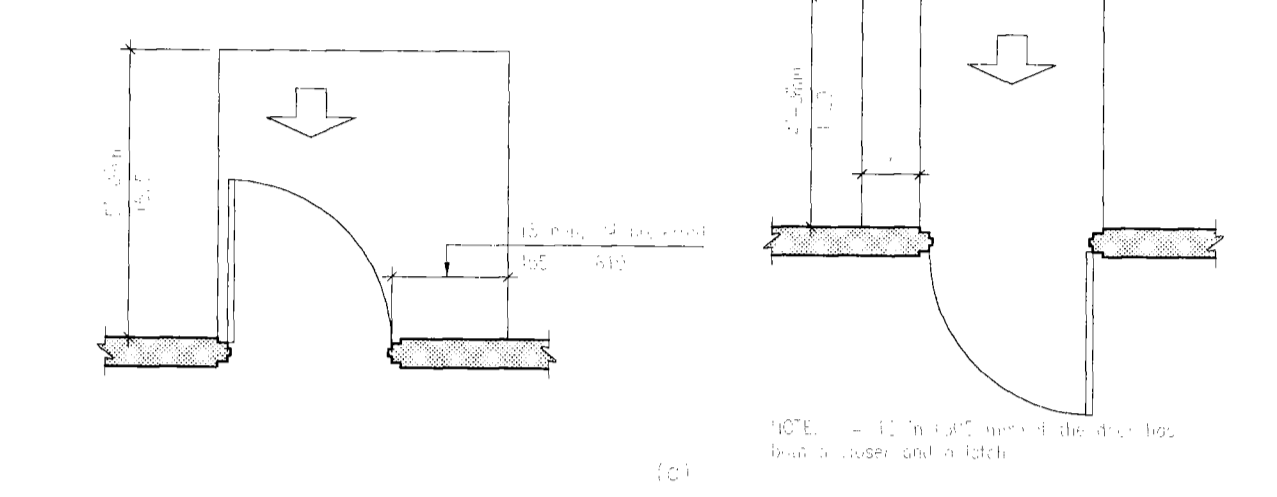


Fig. 36
Minimum Doorway Depth

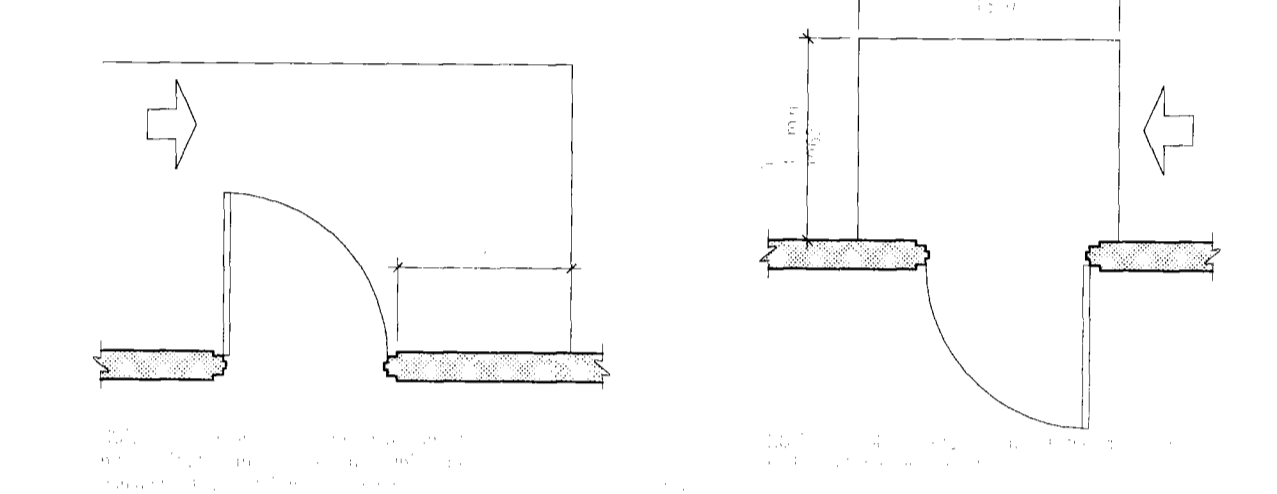


Fig. 37
Flush Appliances - Temporary chairs

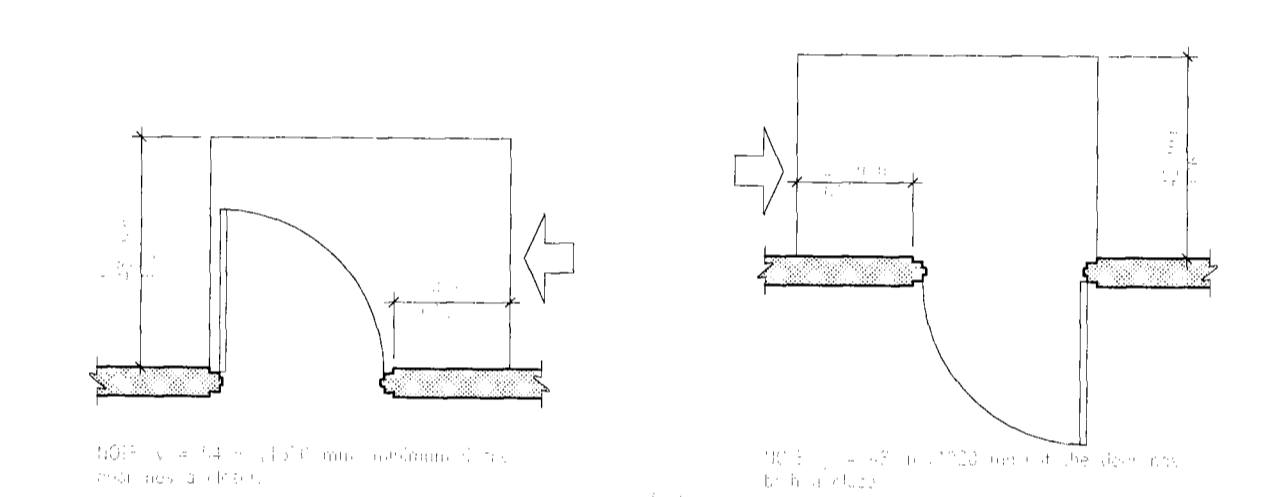


Fig. 38
Flush Appliances - Permanent chairs

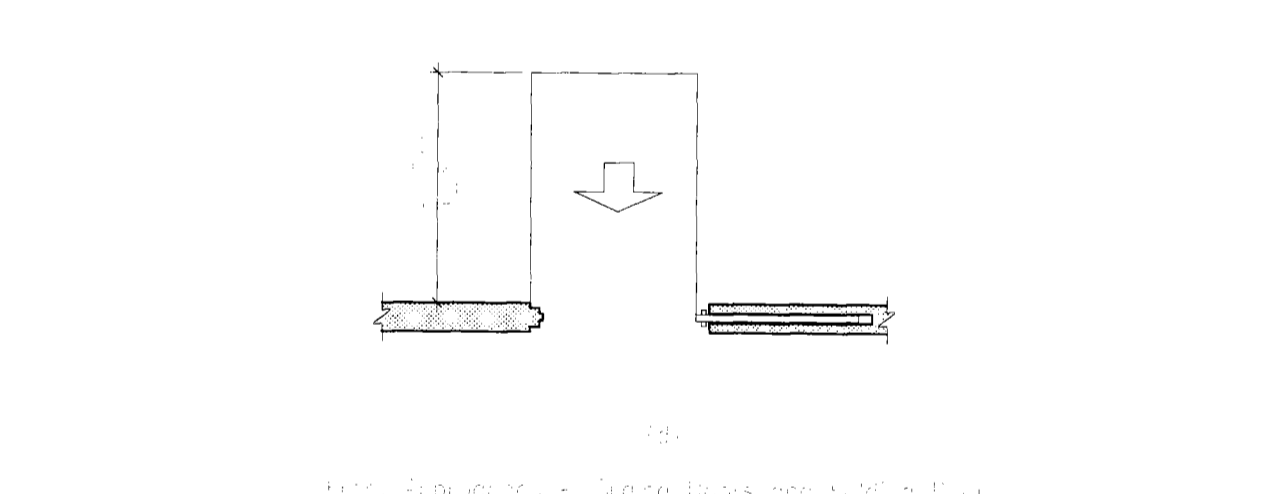


Fig. 39
Flush Appliances - Wheelchair

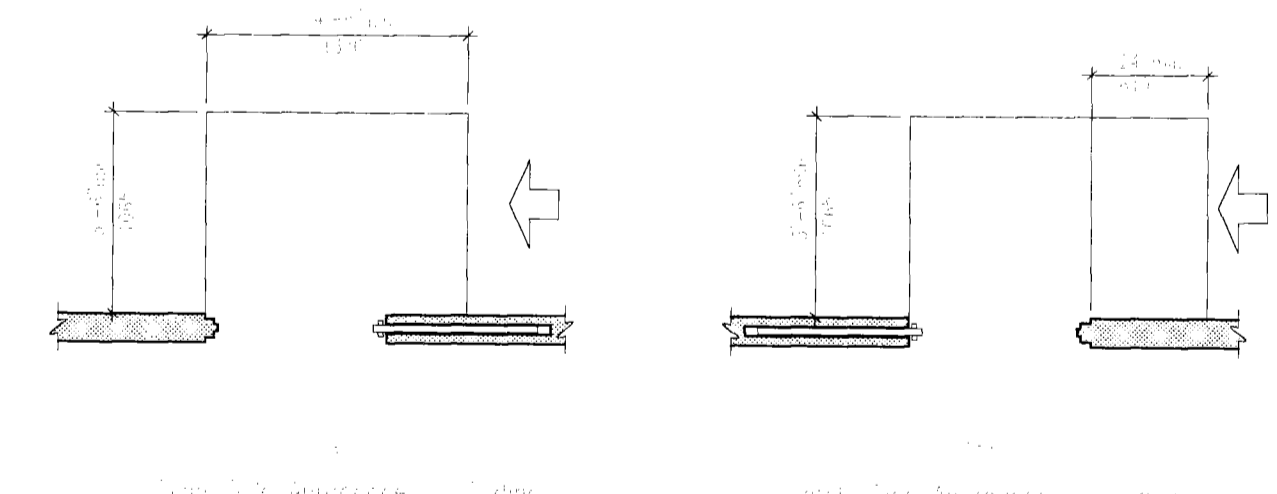


Fig. 40
Minimum Clearances at Entrances

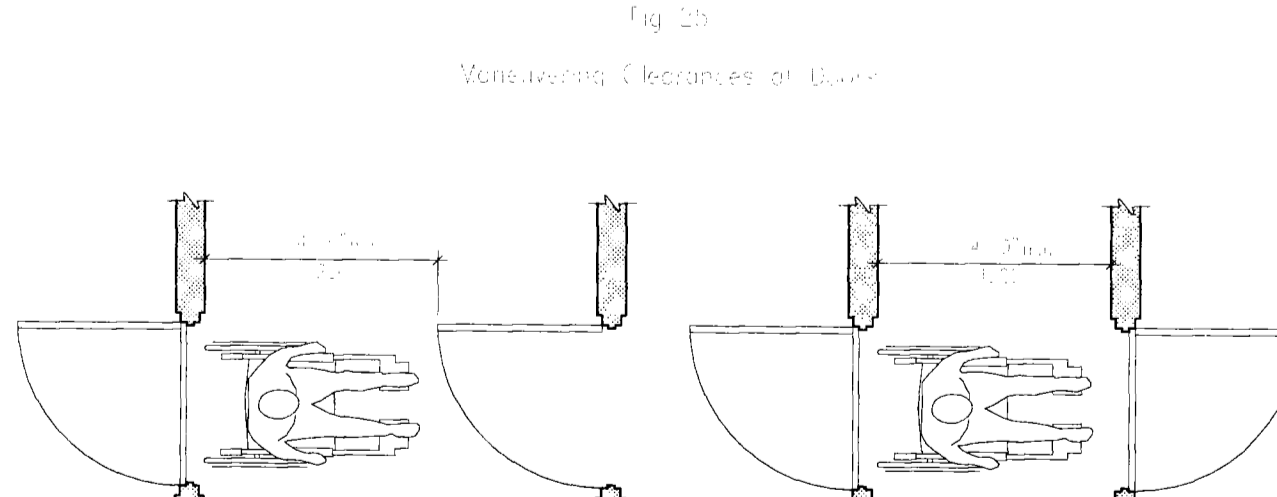


Fig. 41
Minimum Clearances at Entrances

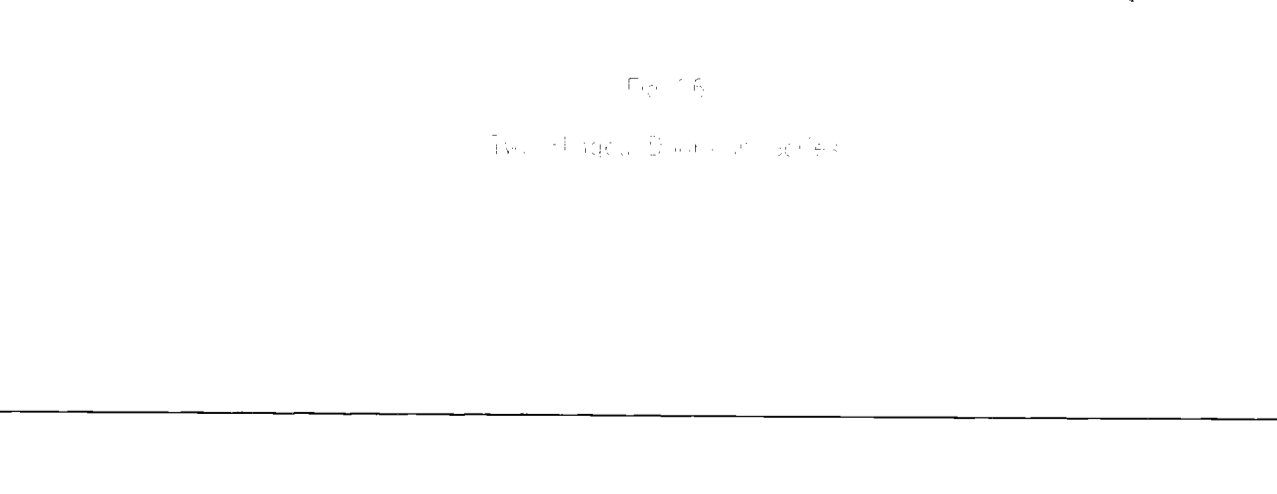


Fig. 42
Minimum Clearances at Entrances

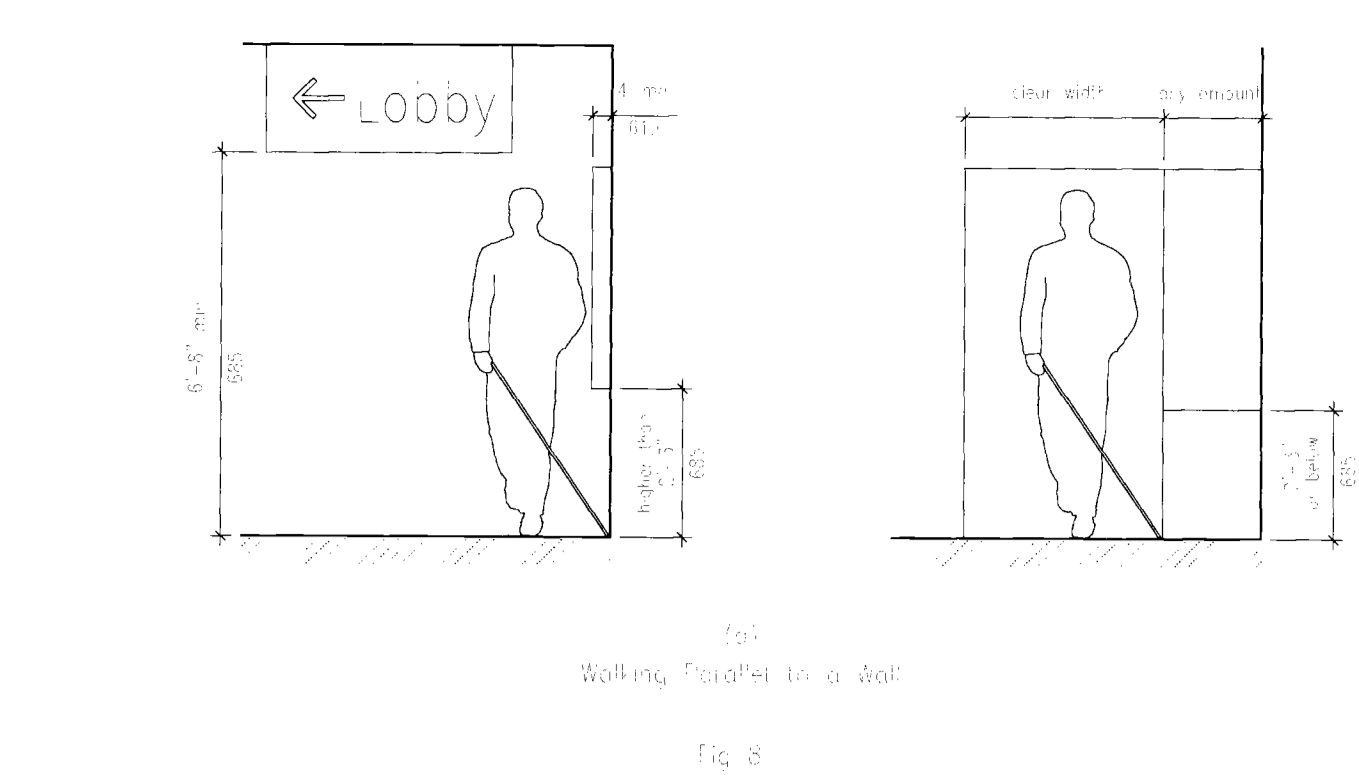


Fig. 43
Walking Transfer to a Seat

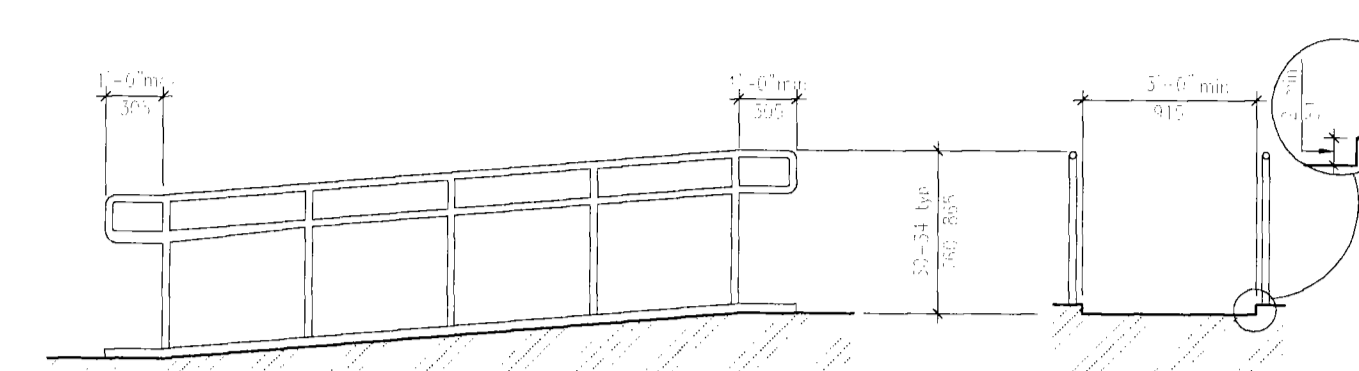


Fig. 44
Entering Objects

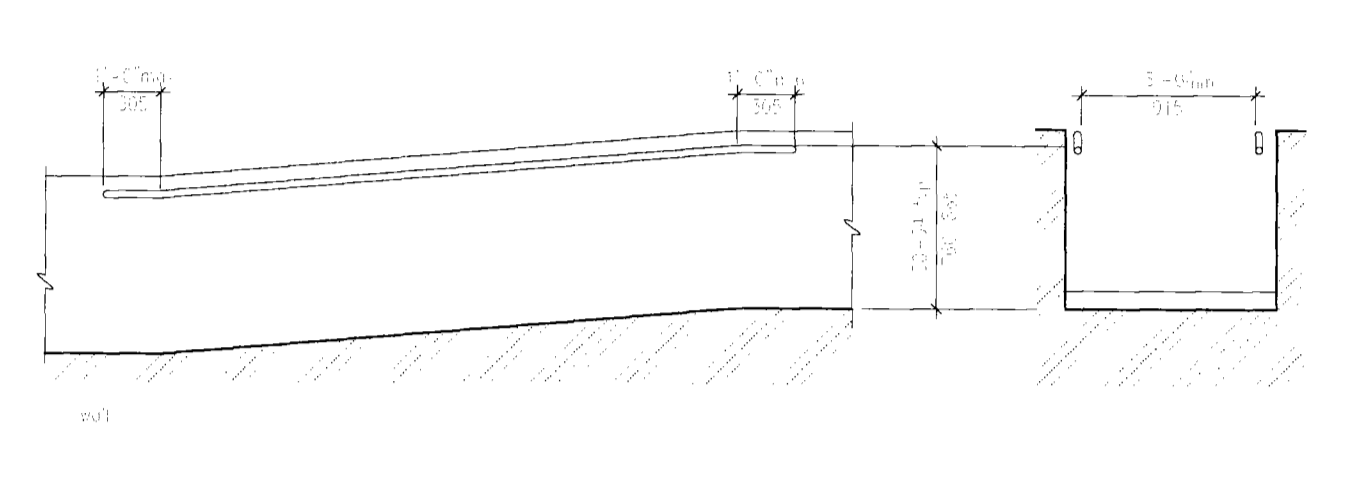


Fig. 45
Wheelchair Turning Space

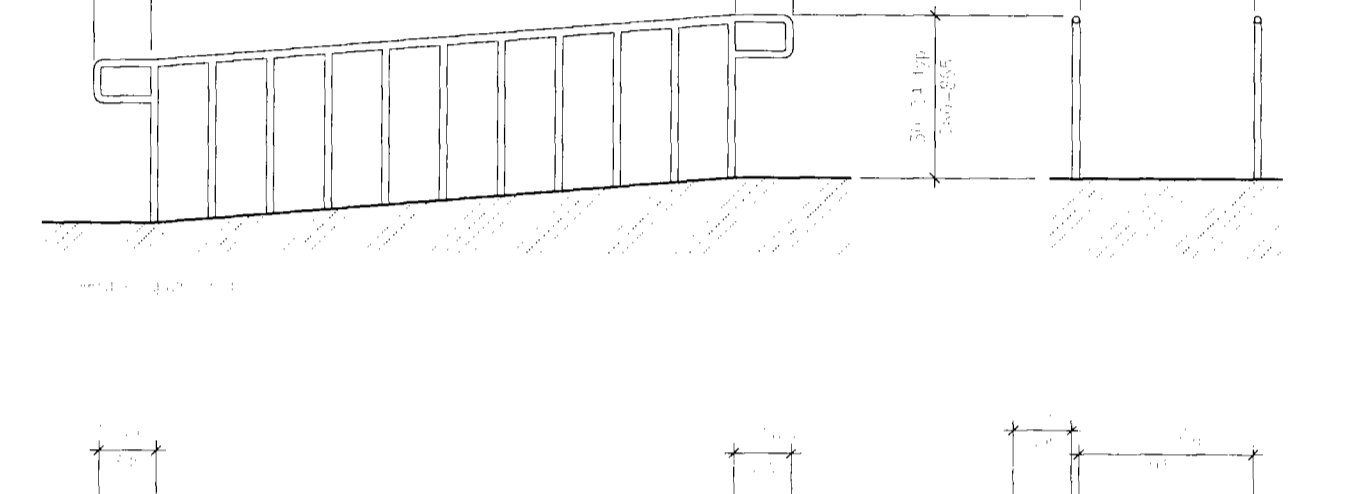


Fig. 46
Forward Approach

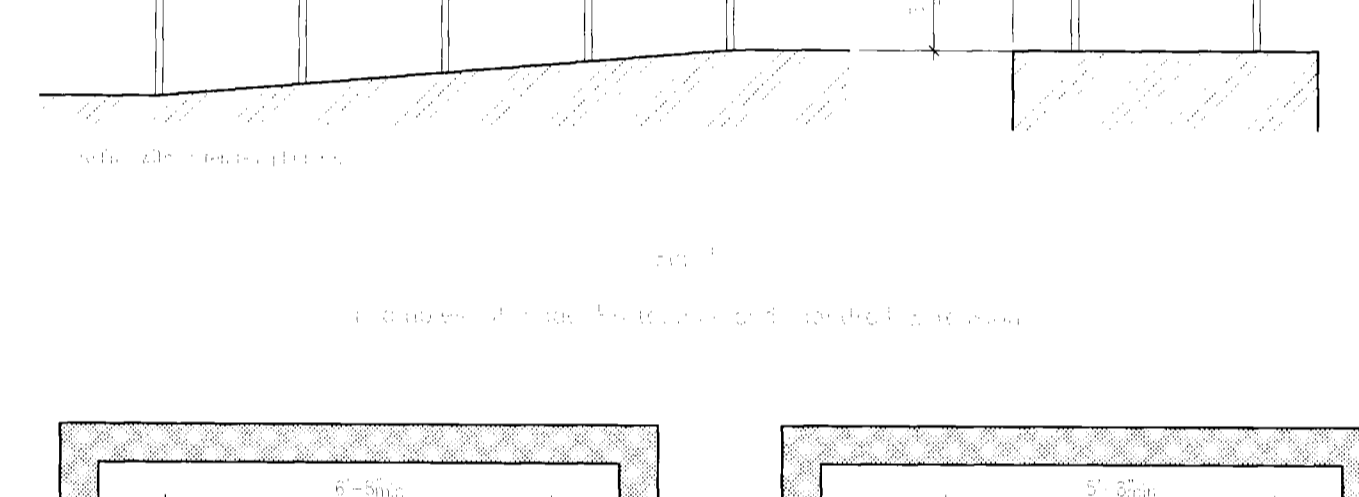


Fig. 47
Parallel Approach

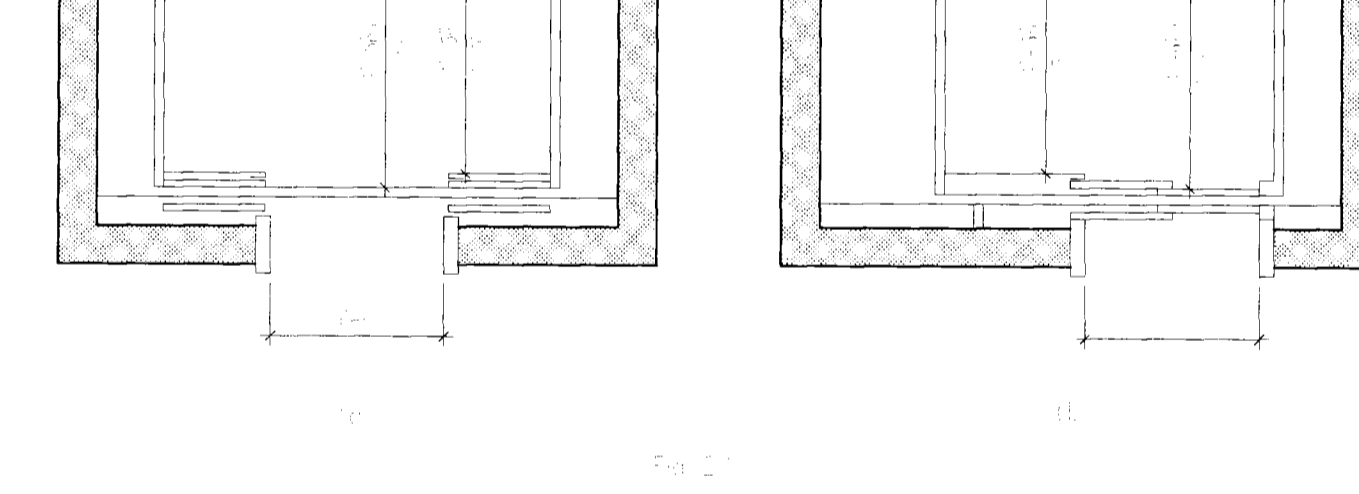


Fig. 48
Forward Approach

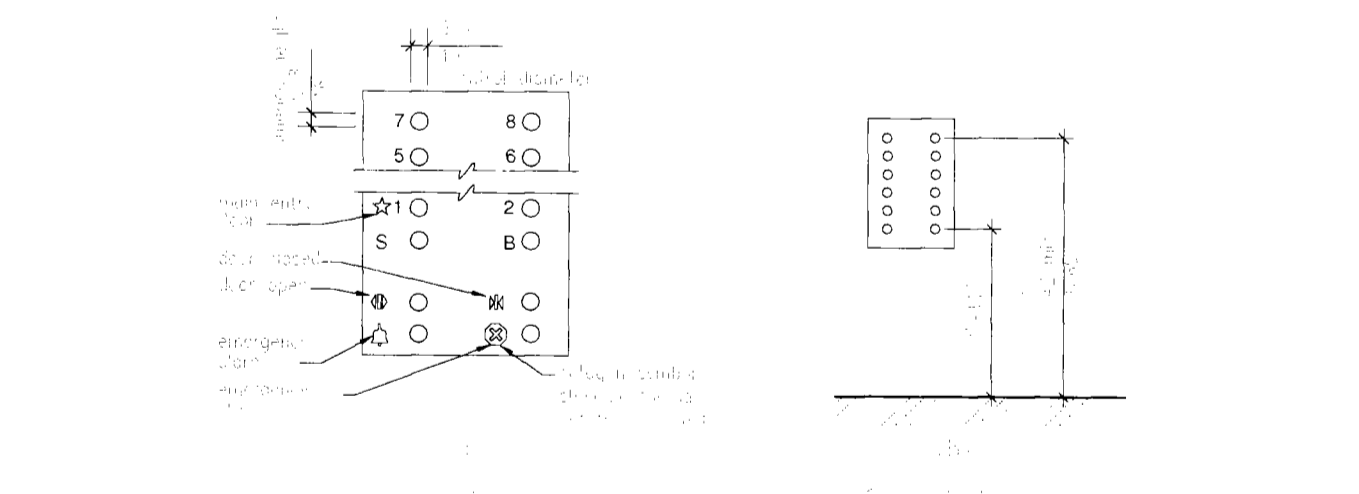


Fig. 49
Forward Approach

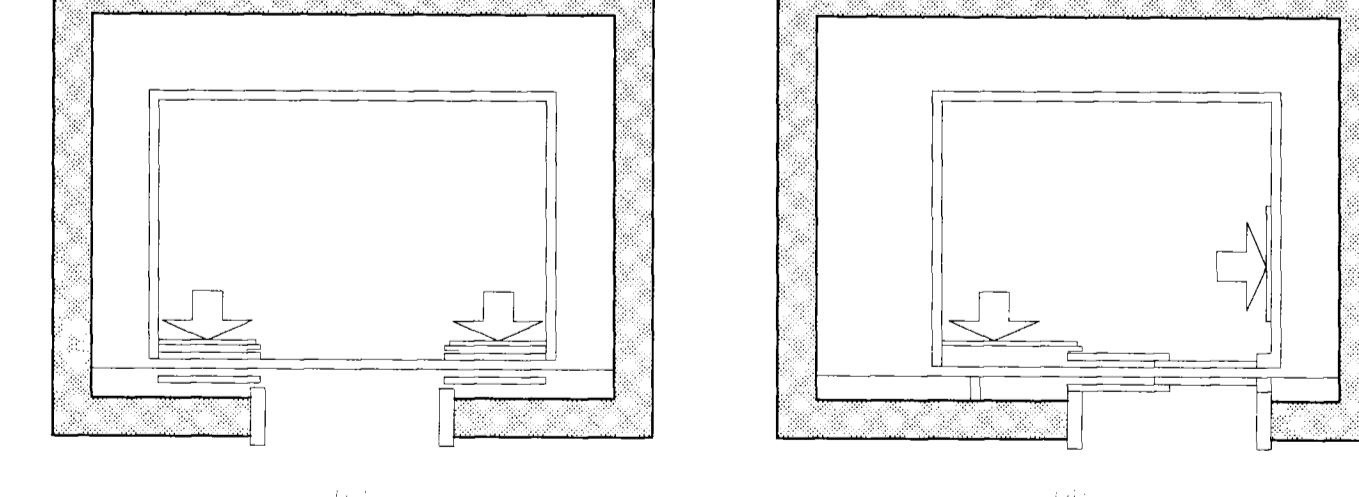


Fig. 50
Forward Approach

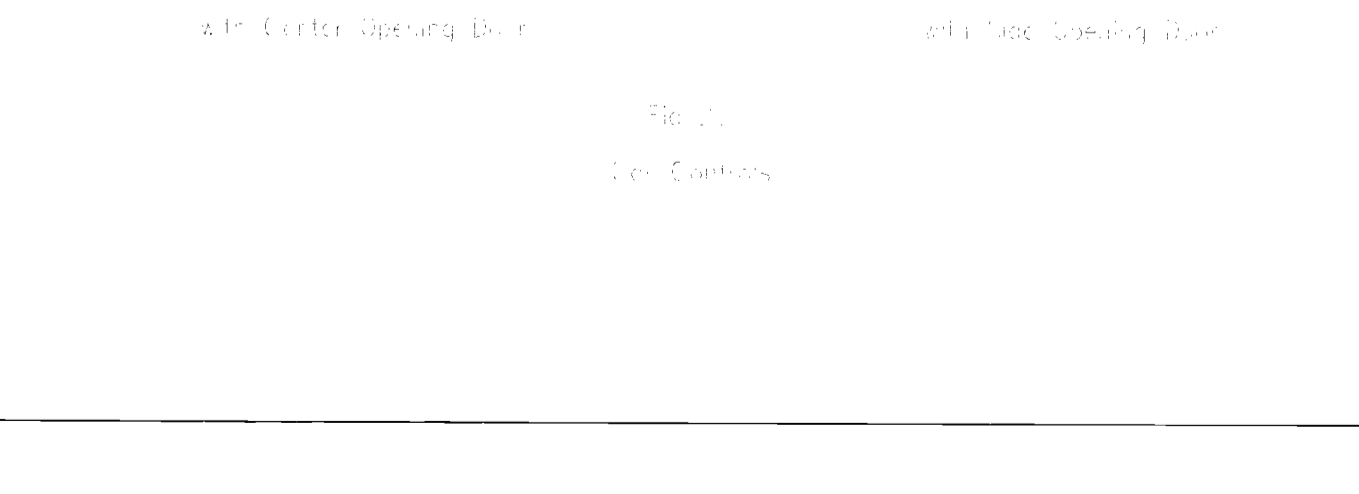


Fig. 51
Forward Approach

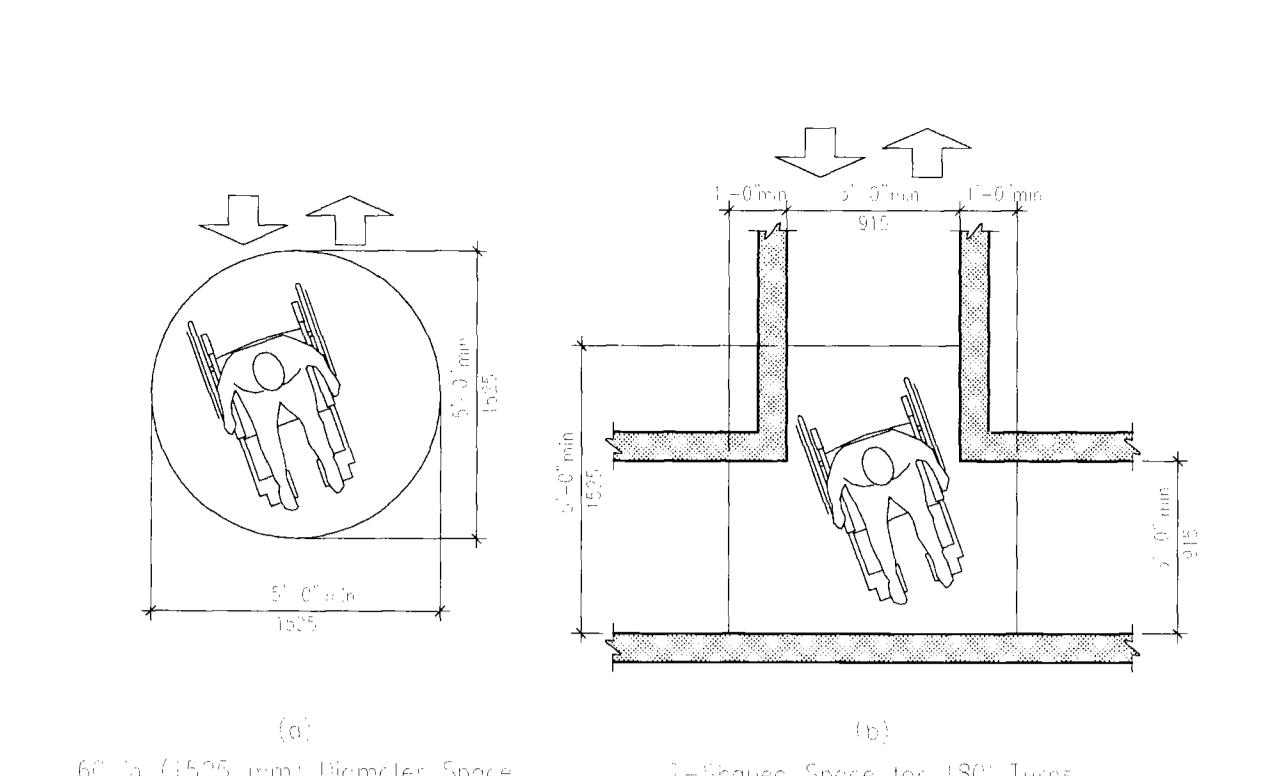


Fig. 52
Wheelchair Turning Space

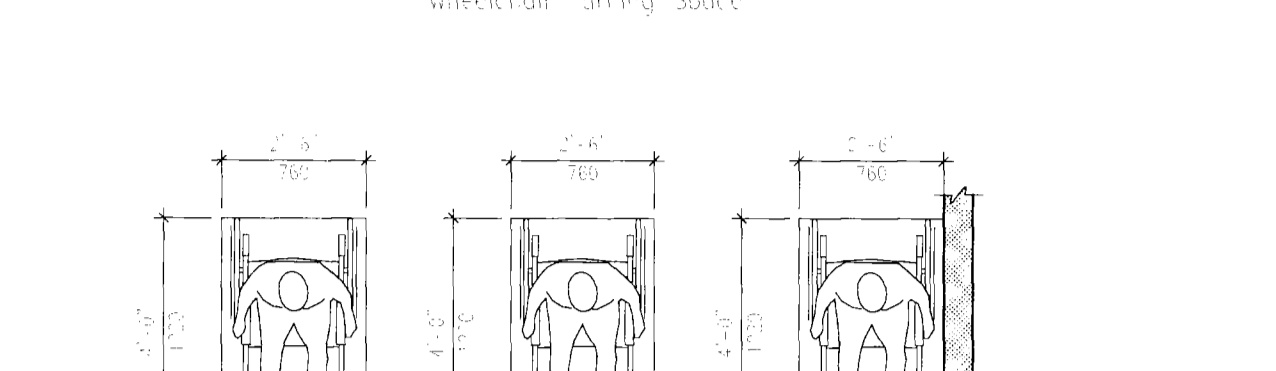


Fig. 53
Forward Approach

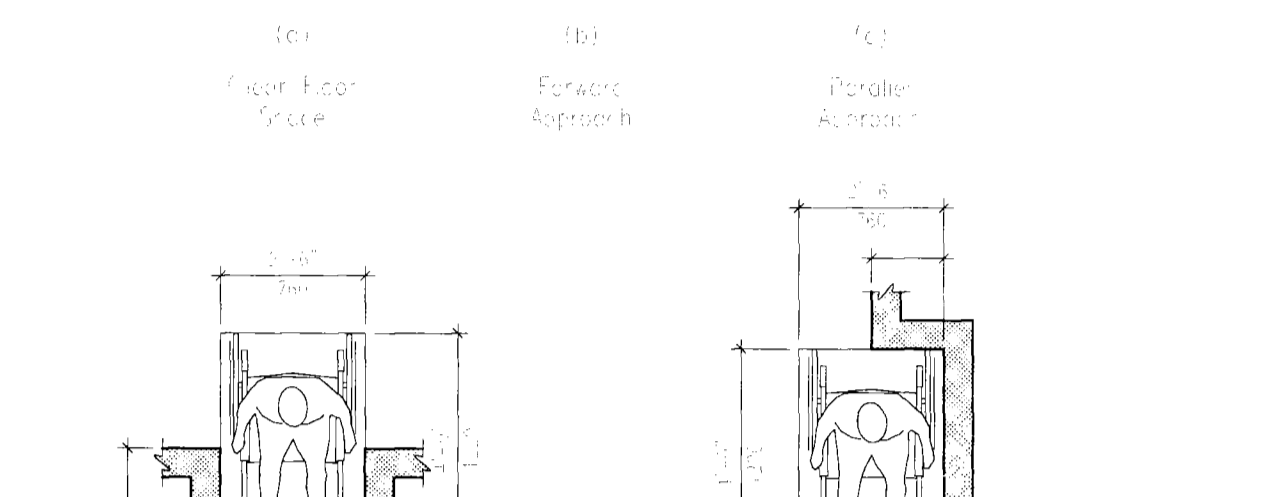


Fig. 54
Forward Approach

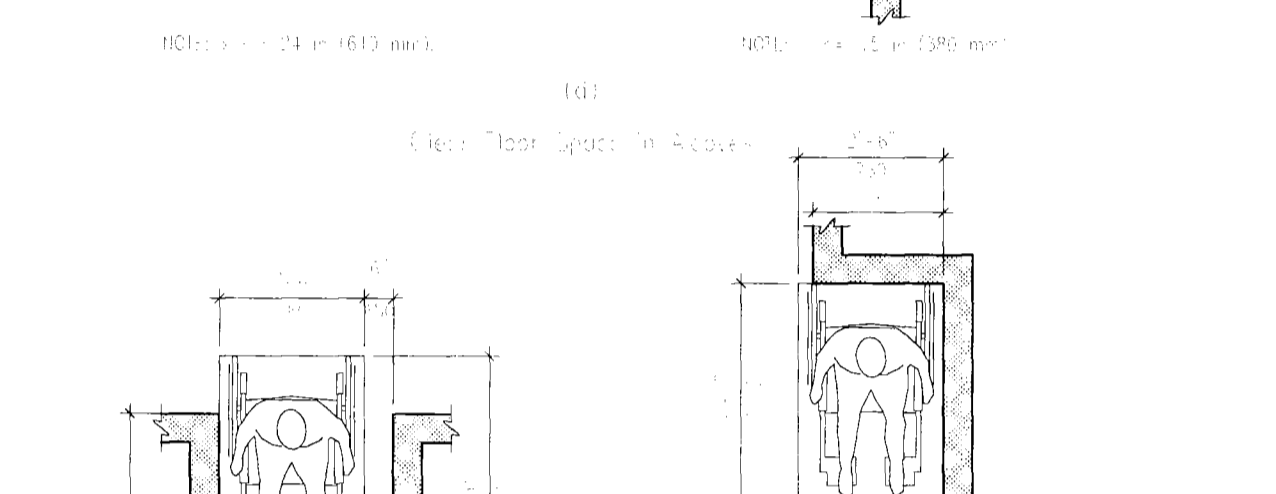


Fig. 55
Forward Approach

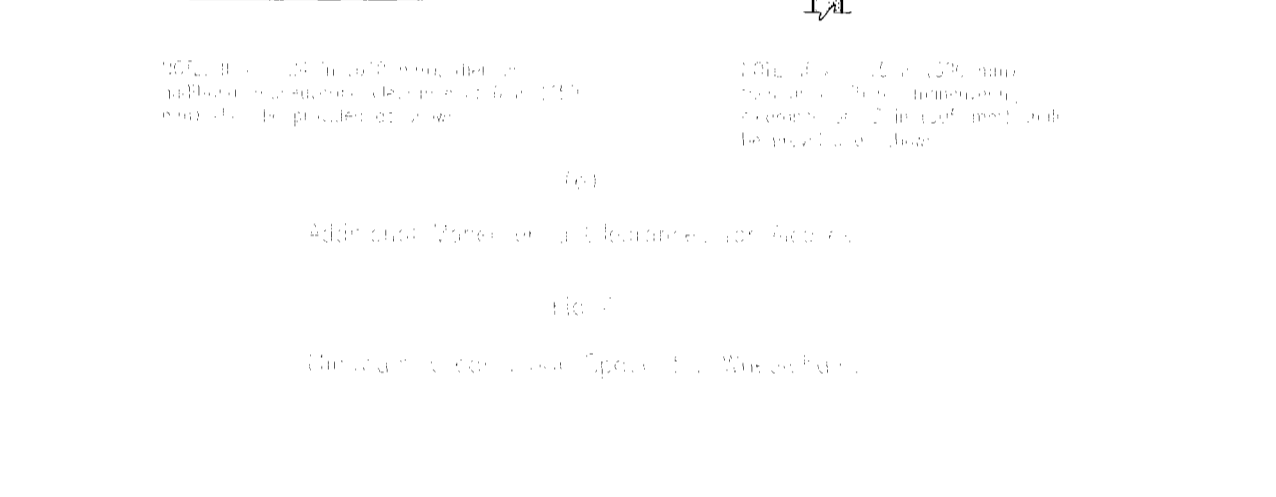


Fig. 56
Forward Approach

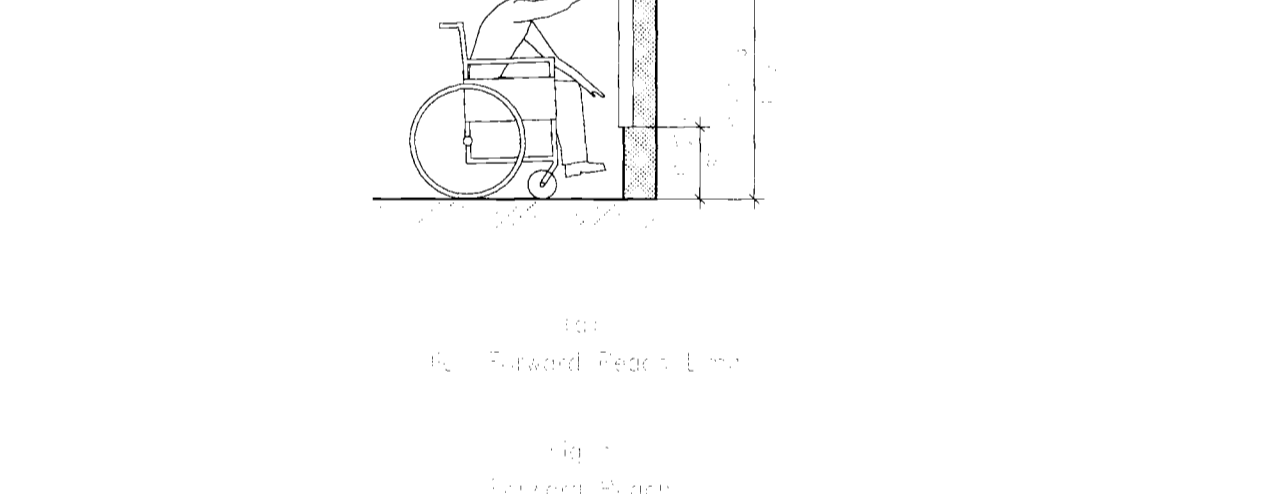


Fig. 57
Forward Approach

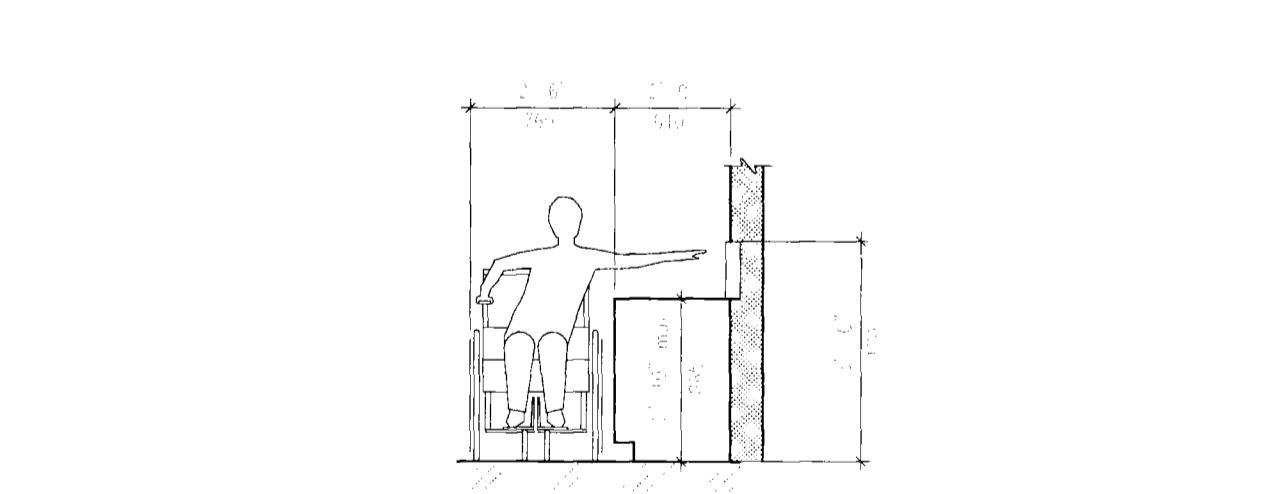


Fig. 58
Forward Approach

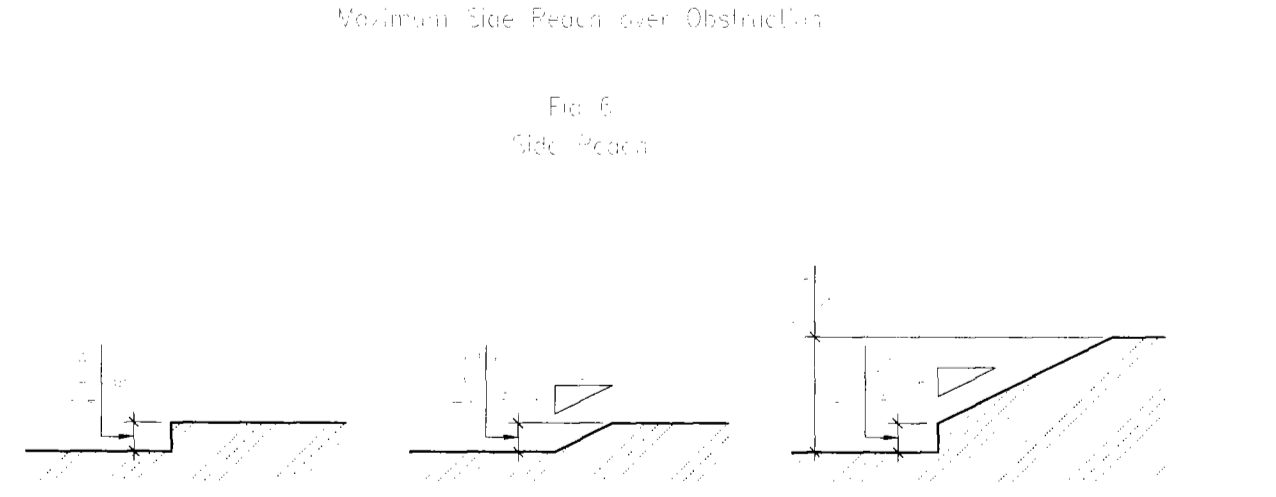


Fig. 59
Forward Approach

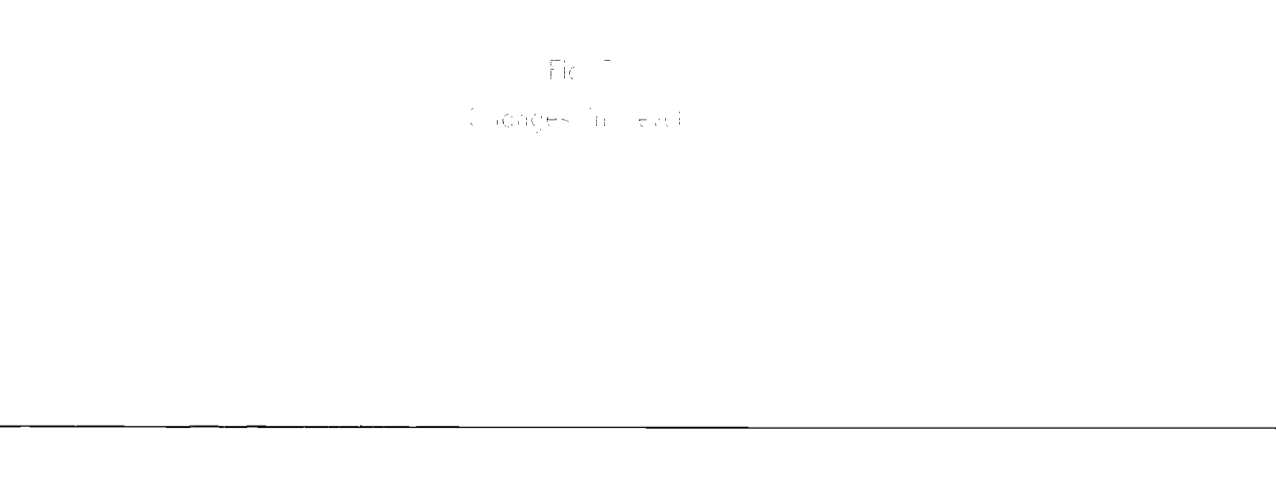


Fig. 60
Forward Approach

SEAL:

REVISIONS:

NUMBER	DESCRIPTION	DATE



NEW YORK CITY DEPARTMENT OF DESIGN + CONSTRUCTION
BUREAU OF ARCHITECTURE & ENGINEERING

CAPITAL PROJECT NUMBER:
CITYHALL2
PROJECT NAME:
Renovation of City Hall
Bid Package 2

FOR THE:

DRAWING TITLE:
ADA Accessibility Diagrams & Notes

DRAWN BY: JS SCALE: As indicated
CHECKED BY: NA DATE: 10.08.10

DRAWING NUMBER:
G-003.00

SHEET NUMBER:
3 OF 42


DOB PERMIT APPLICATION

FIRE RATING LEGEND

- - - - 1 HR FIRE RATING
- 2 HR FIRE RATING

Beyer Blinder Belle
 ARCHITECTS & PLANNERS LLP
 41 East 11th Street
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 Tel: 212.777.7600
 Fax: 212.475.7424

SEAL:

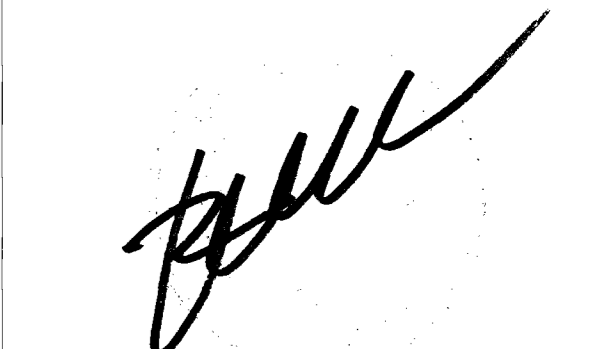

REVISIONS:

NUMBER	DESCRIPTION	DATE



DIVISION OF STRUCTURES
 BUREAU OF ARCHITECTURE & ENGINEERING

CAPITAL PROJECT NUMBER:
CITYHALL2
 PROJECT NAME:
 Renovation of City Hall
 Bid Package 2

FOR THE:

DRAWING TITLE:
Fire Rated Partition Plans


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 CHECKED BY: NA DATE: 10.08.10
 DRAWING NUMBER:

G-004.00


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 4 OF 42

RICARD GABEL
 10/2/2010


ACCEPTABLE FIRE RATING
 WATER PENETRATION TESTS

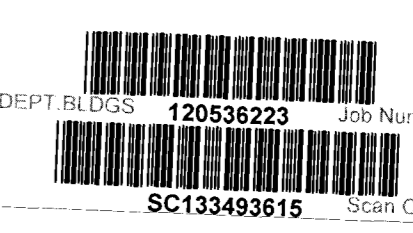


DOB PERMIT APPLICATION

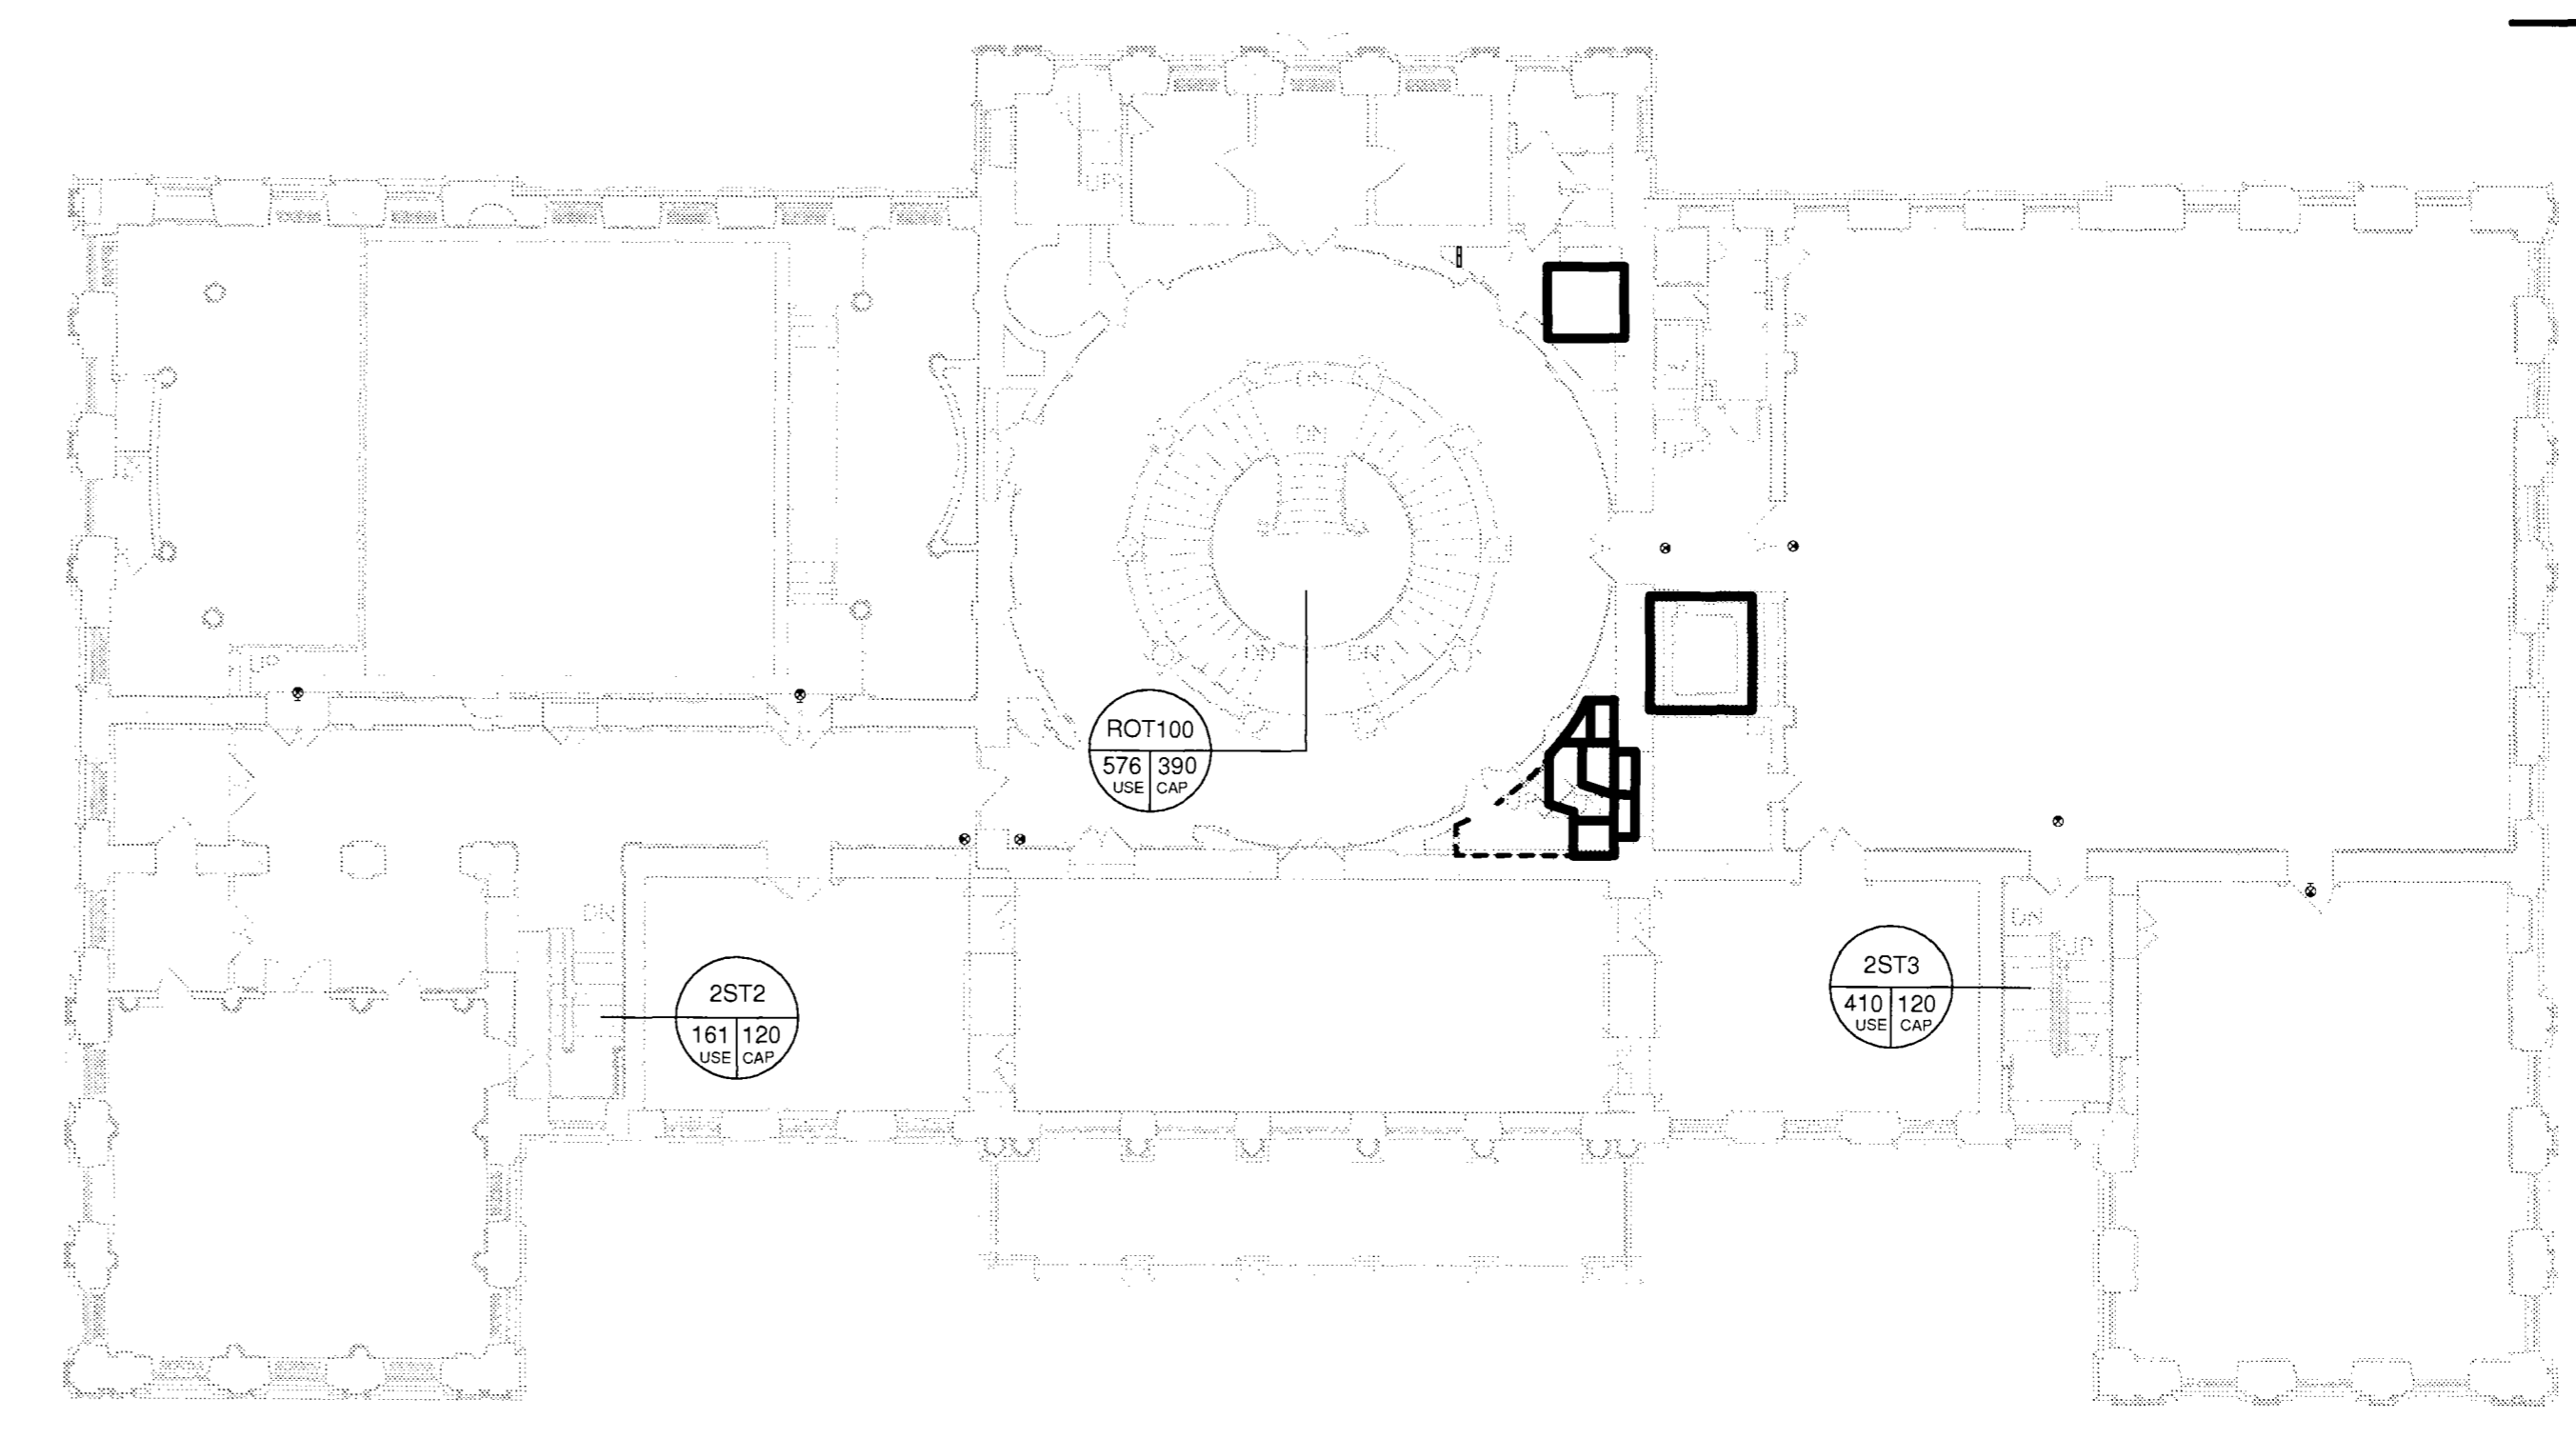


4 Second Floor
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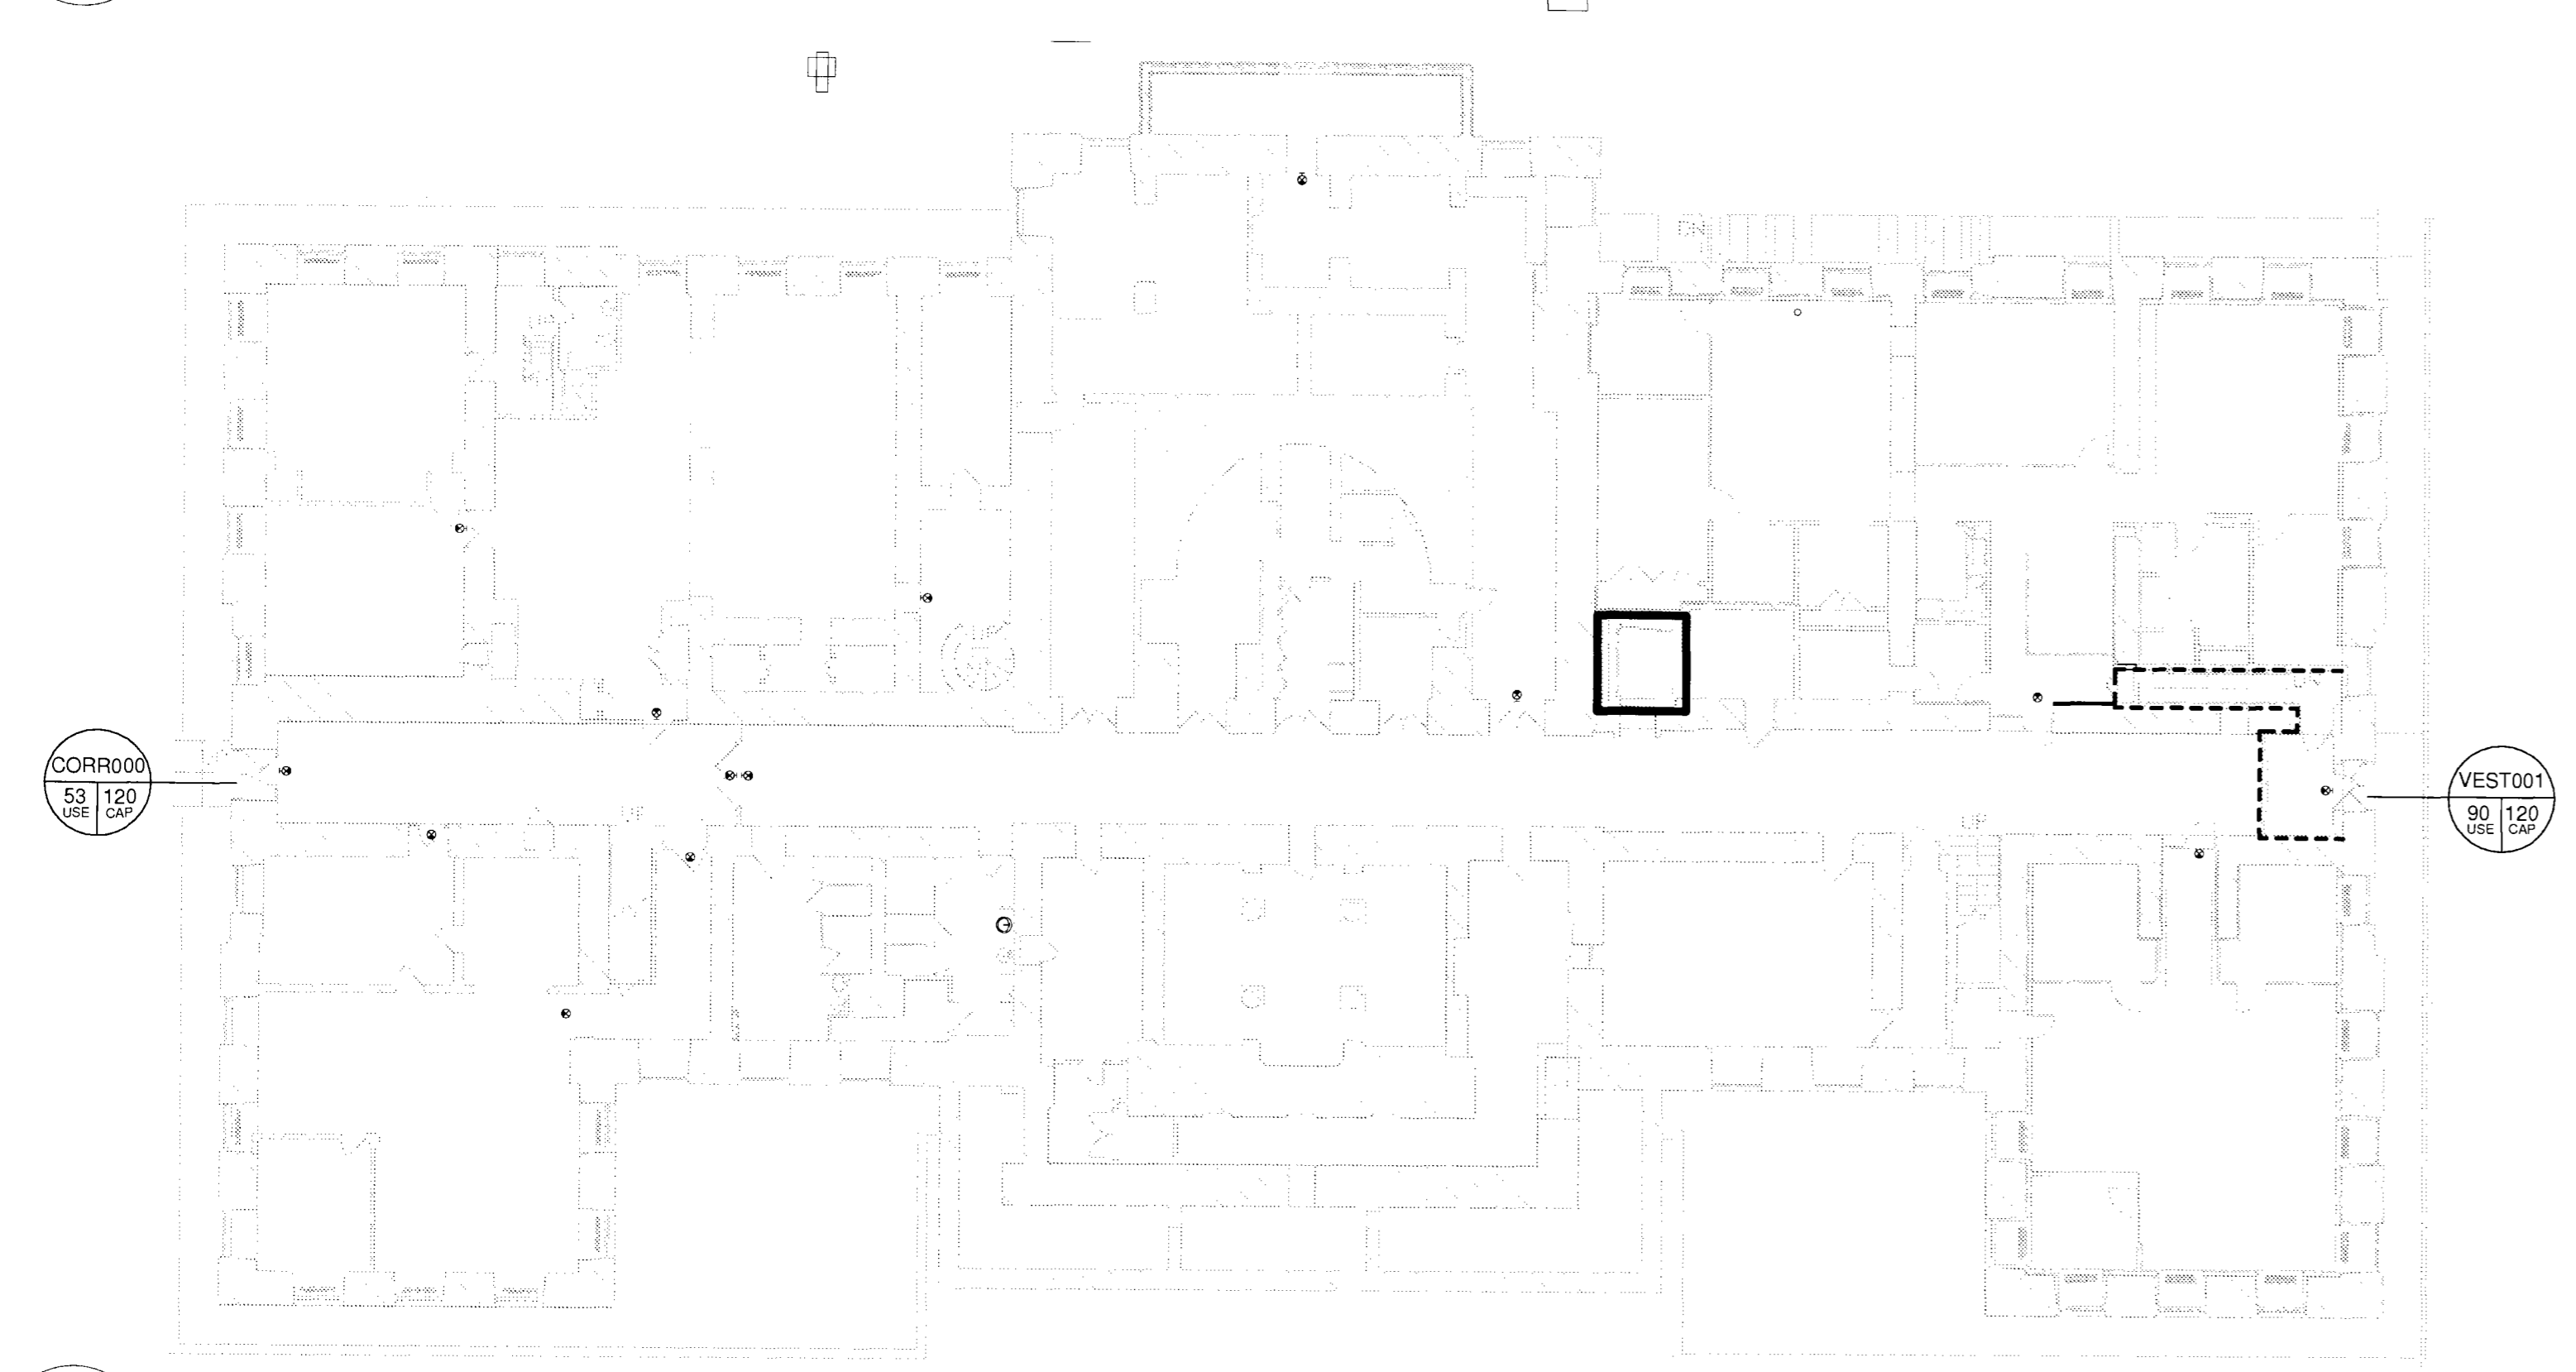
5 Balcony Council Chamber
 G-004.00 1/16" = 1'-0"

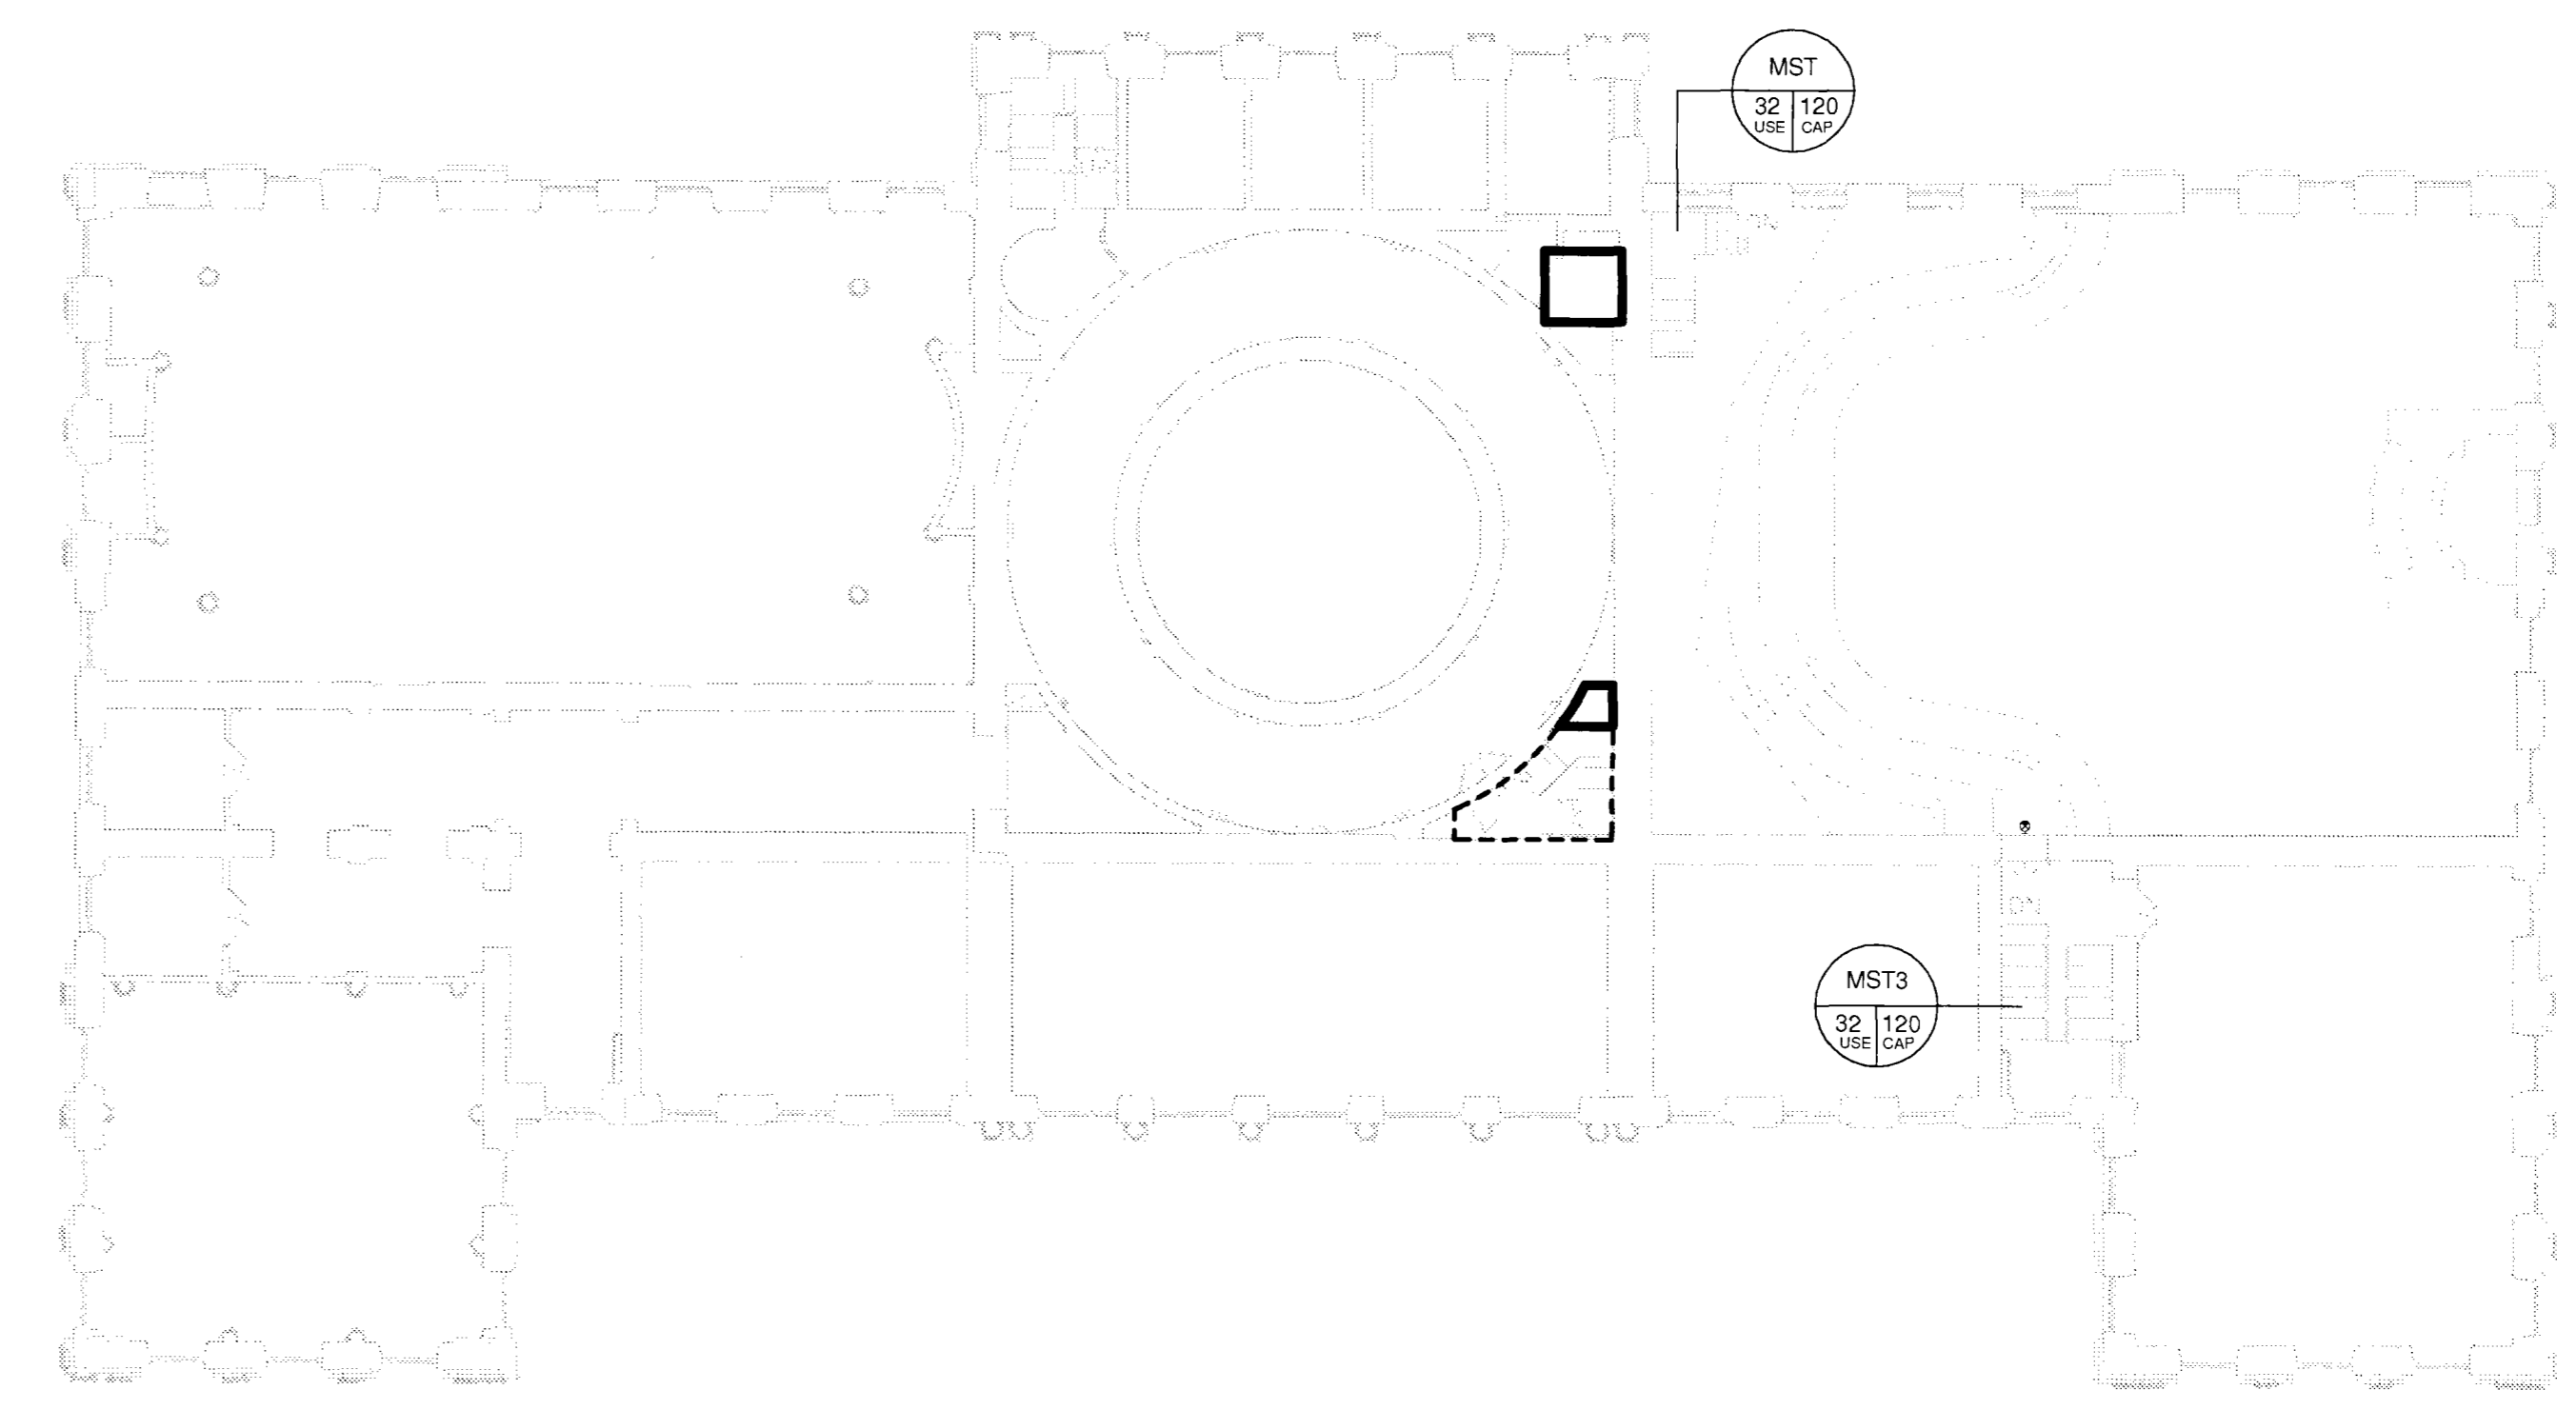


6 Third Floor
 G-004.00 1/16" = 1'-0"

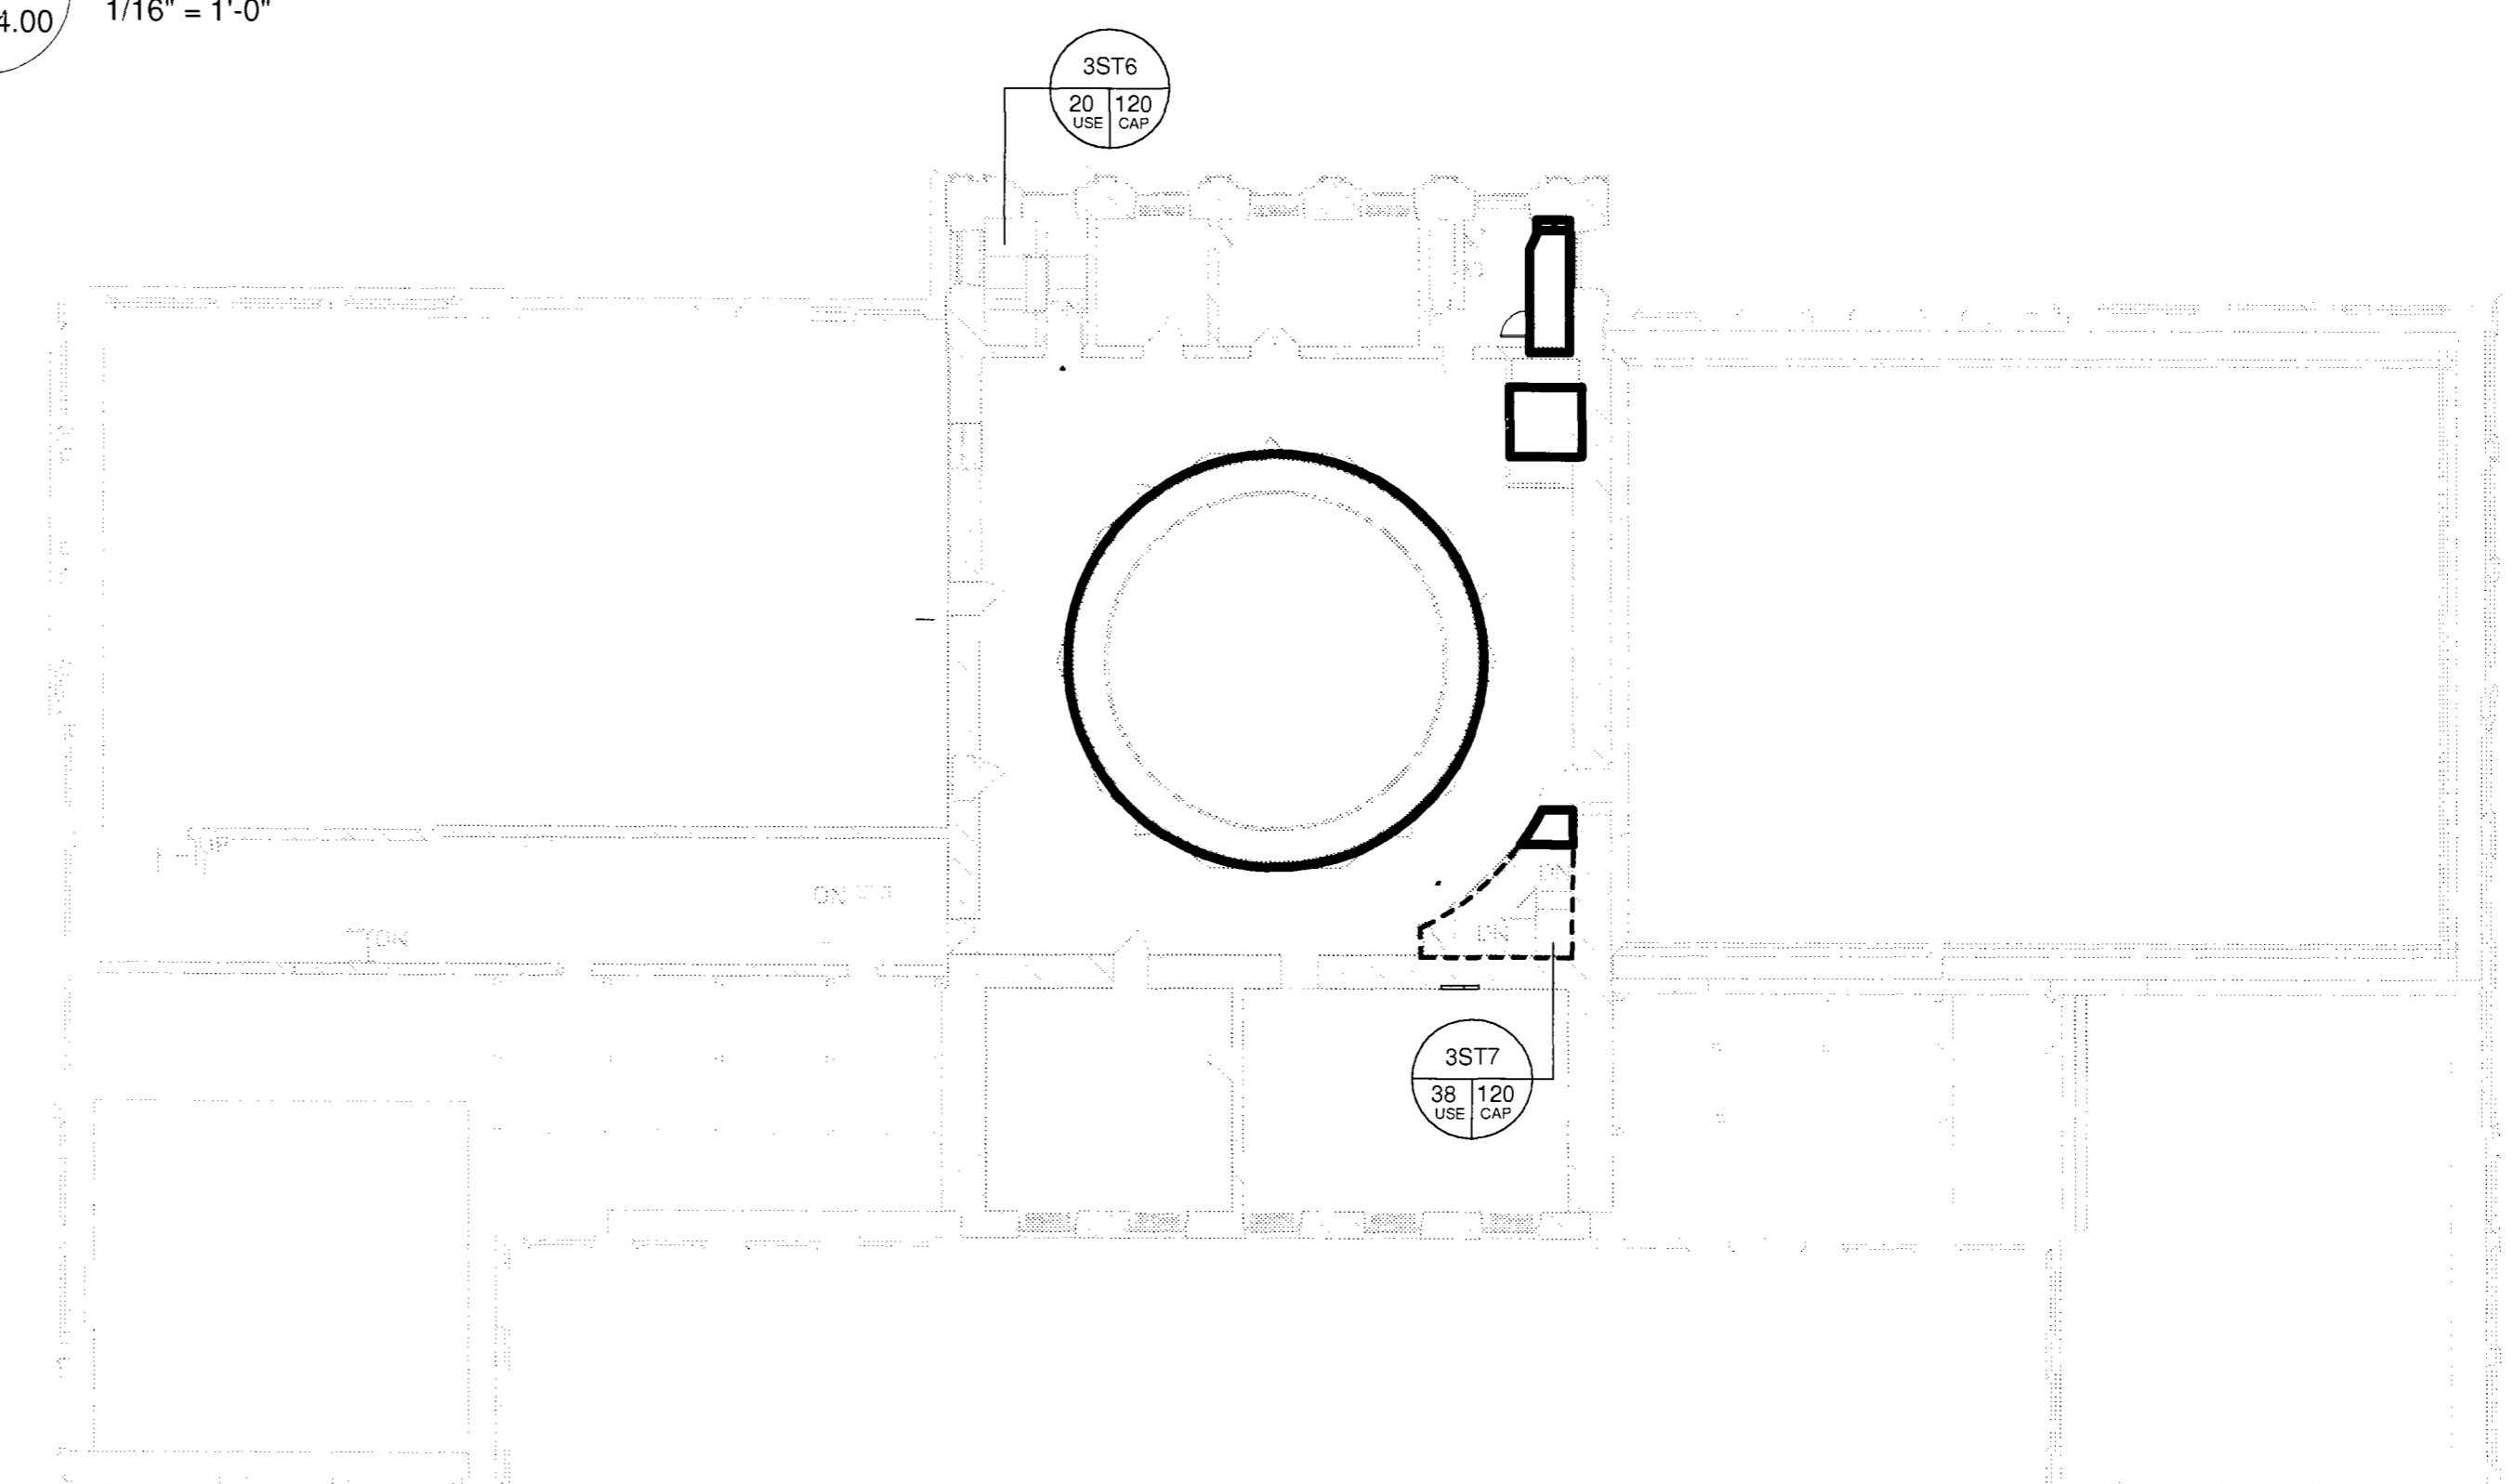

1 Cellar
 G-004.00 1/16" = 1'-0"

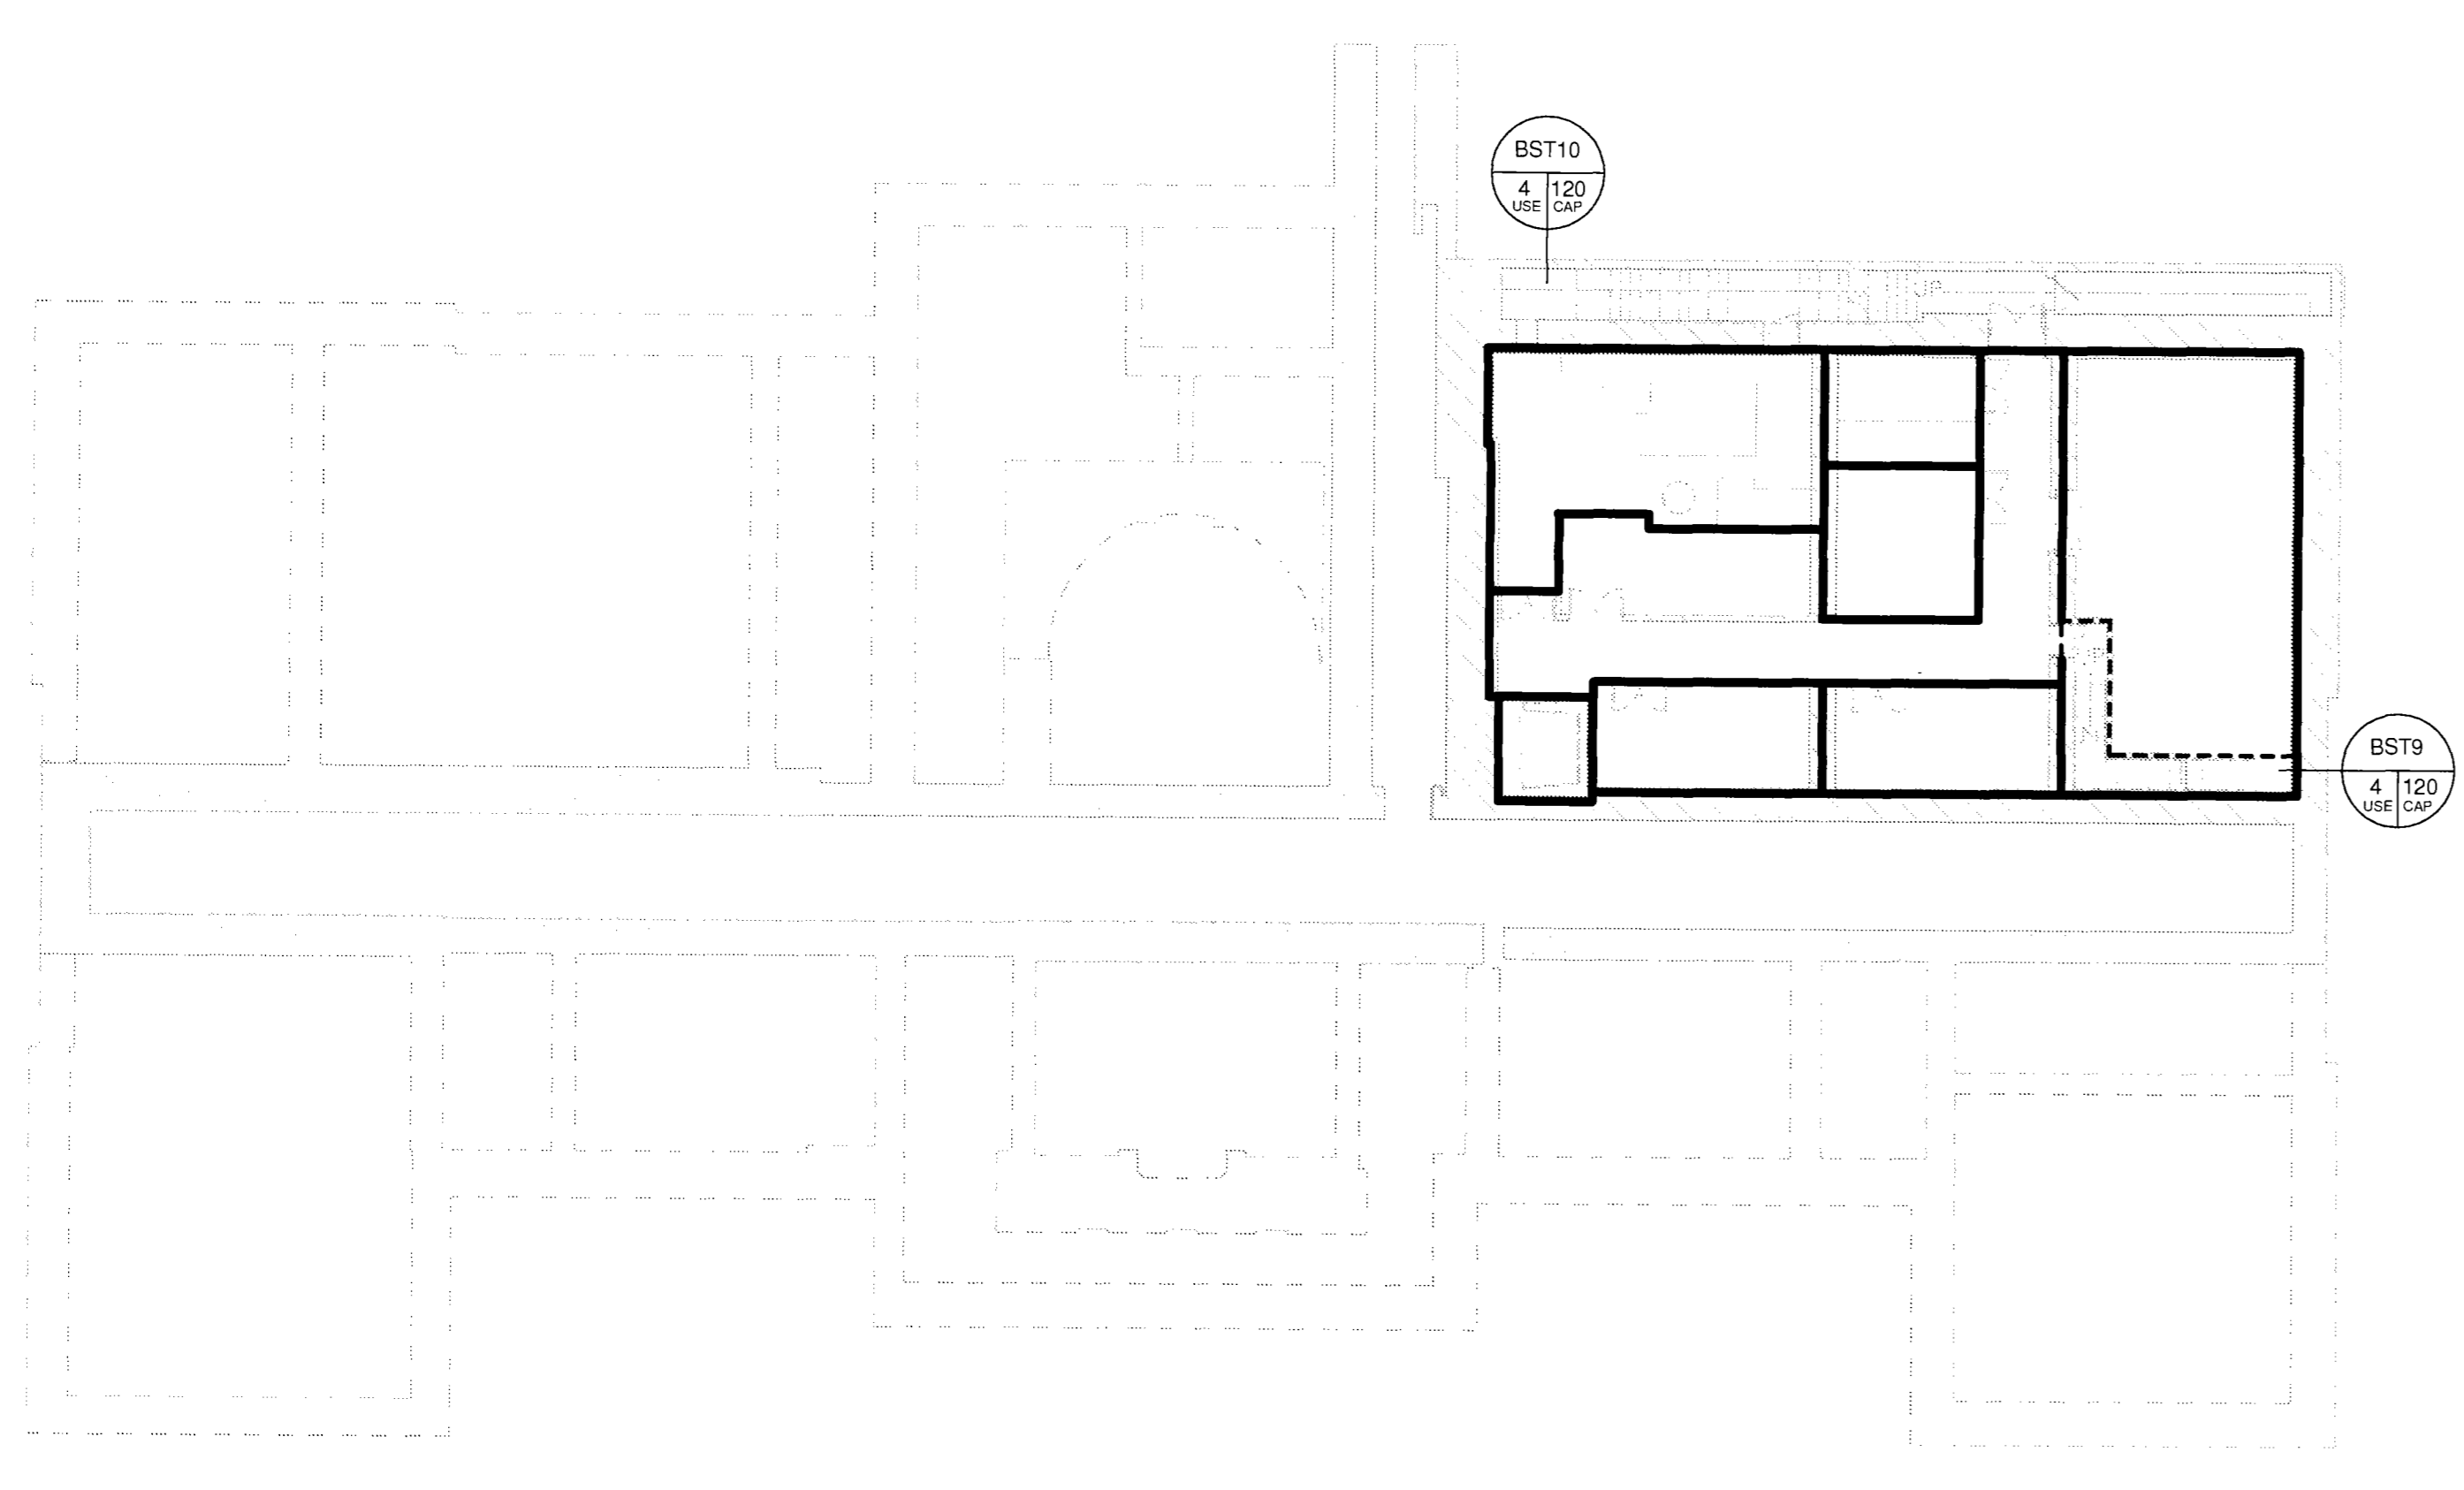

2 Basement Floor
 G-004.00 1/16" = 1'-0"

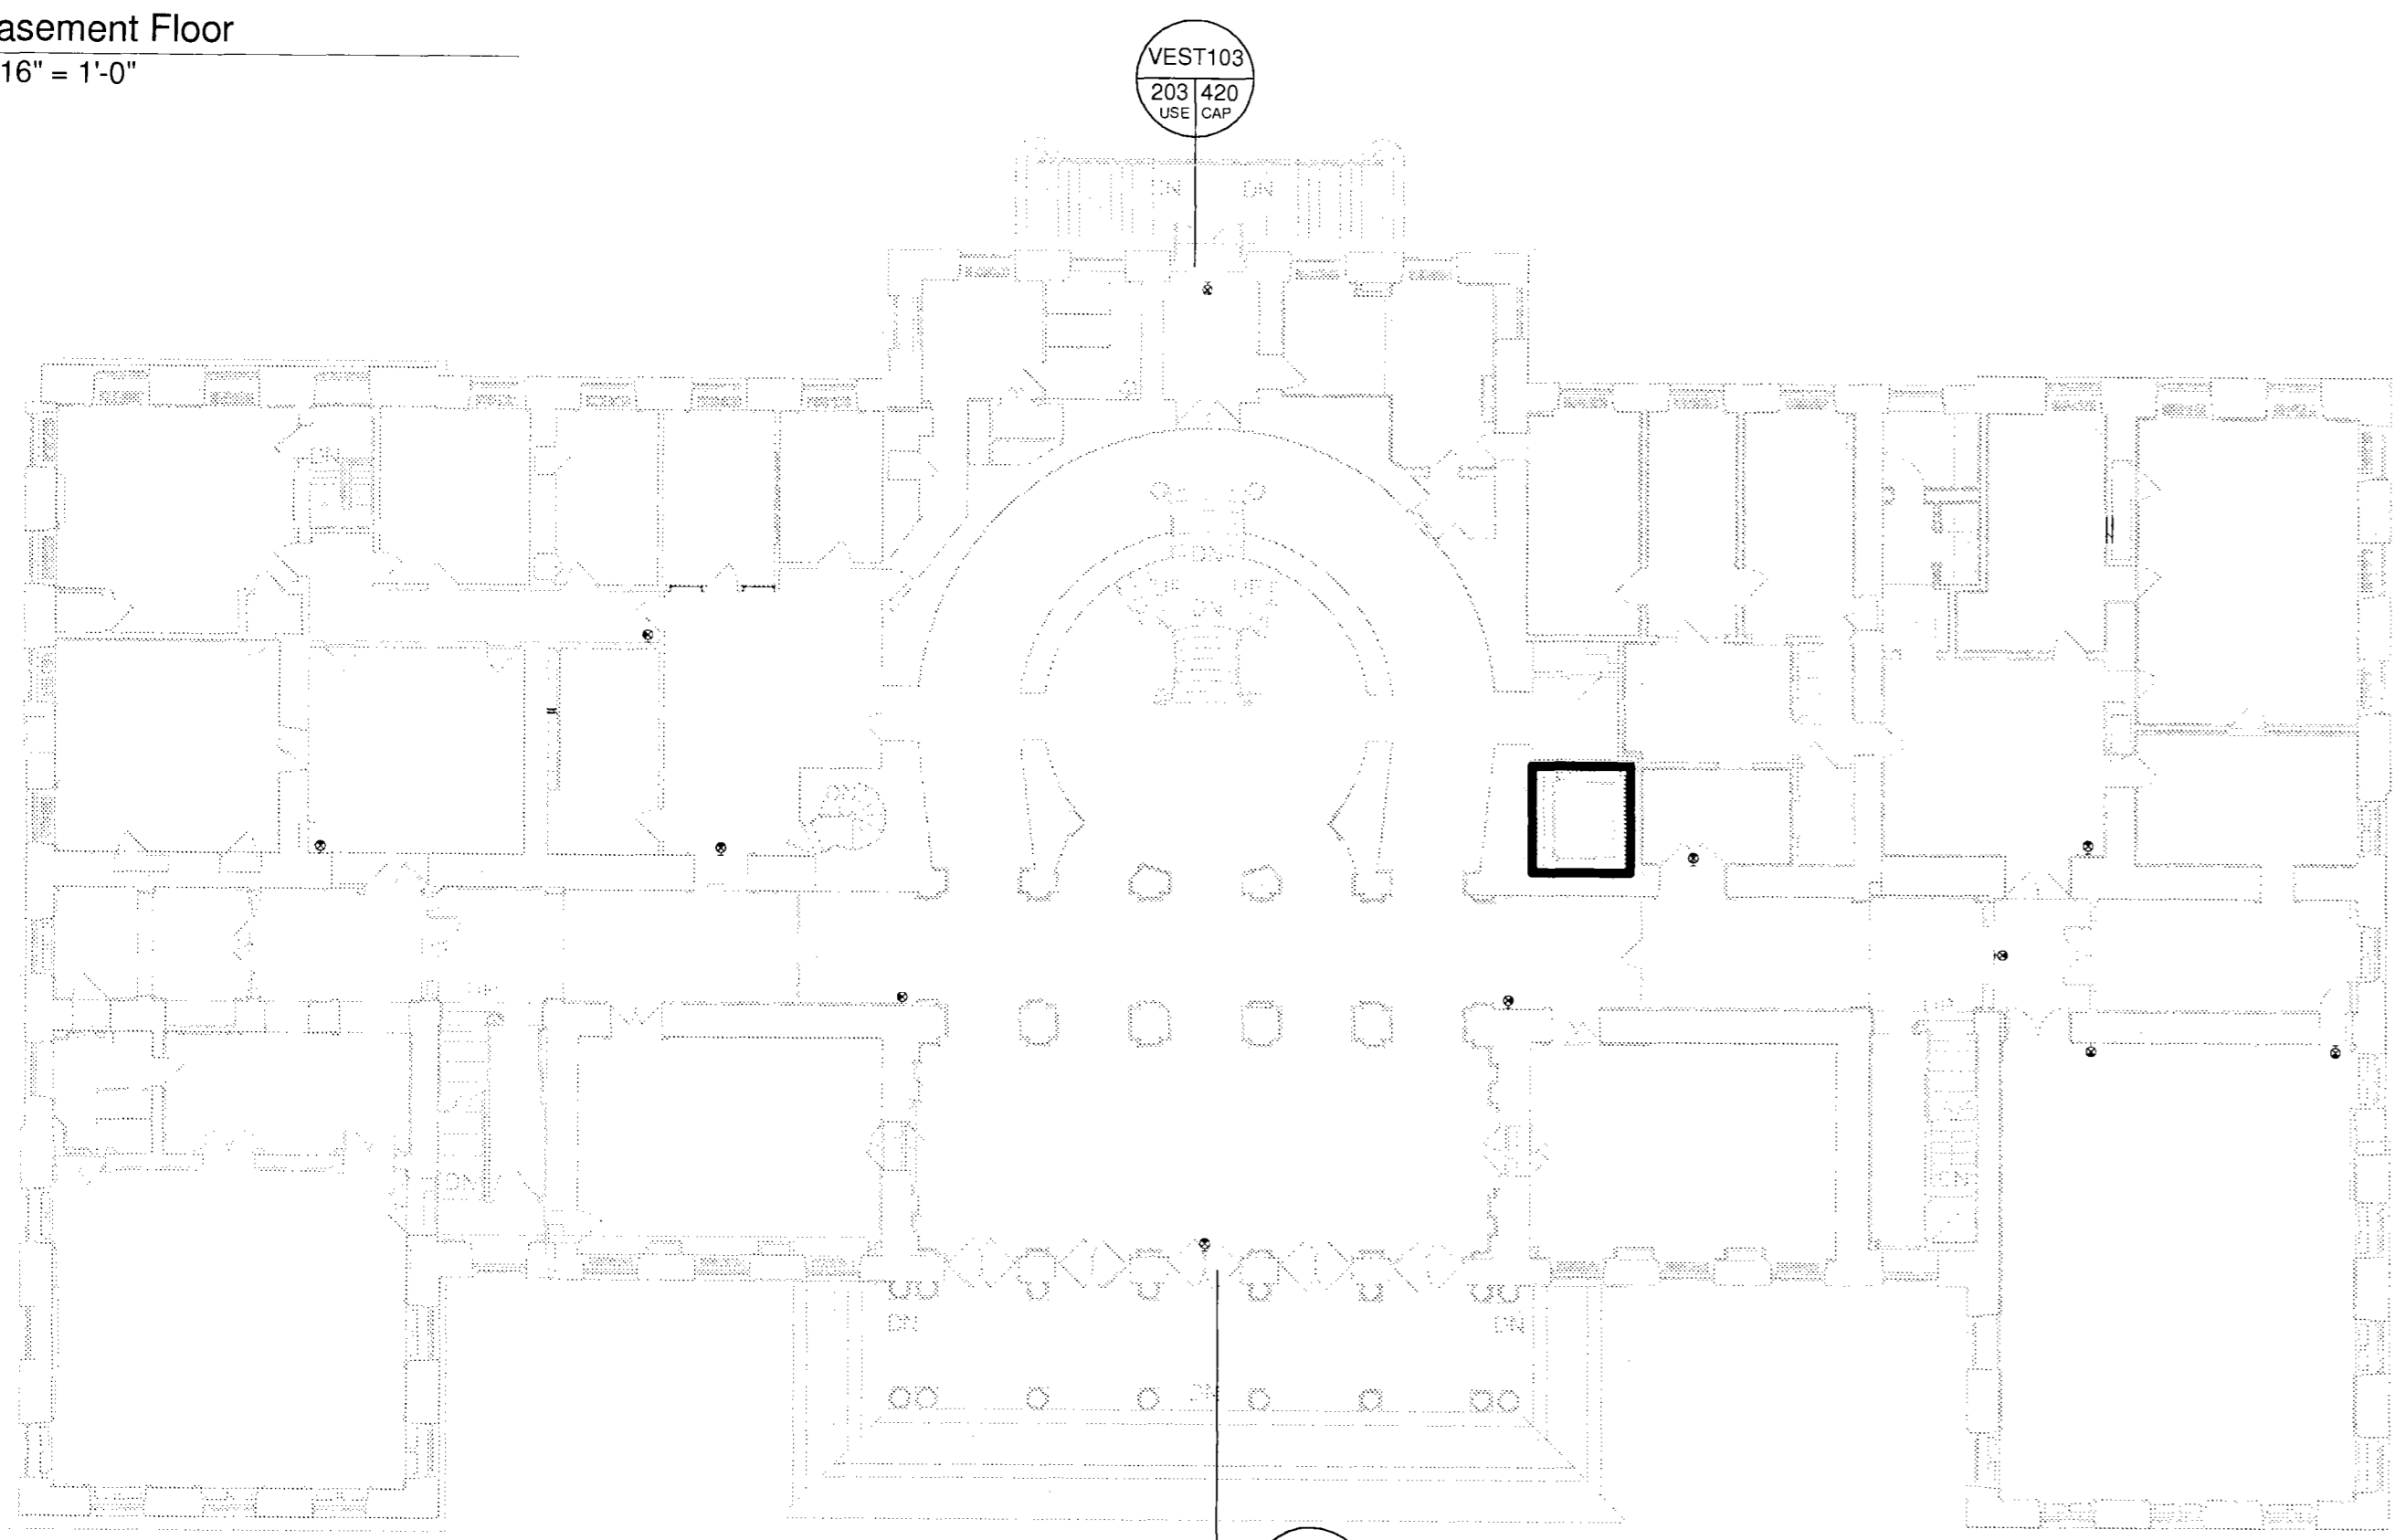


3 First Floor
 G-004.00 1/16" = 1'-0"

KEYNOTE LEGEND	
DW19	CORE DRILL HOLES IN WALLS FOR NEW PIPING AND CONDUITS. SEE STRUCTURAL DRAWINGS FOR SIZE. COORDINATE FINAL SIZE AND LOCATION WITH HVAC, PLUMBING AND ELECTRICAL CONTRACTORS. FIRESTOP PENETRATION.
DW28	REMOVE EXISTING MASONRY TO CREATE WALL OPENING. SEE STRUCTURAL DRAWINGS FOR SIZE AND LINTELS. COORDINATE WITH HVAC CONTRACTOR FOR LOCATION AND CONFIRM SIZE.
DW46	REMOVE EXISTING SLIDING ALUMINUM AND GLASS DOOR SYSTEM
DW50	REMOVE EXISTING MASONRY WALLS. PROVIDE SHORING AS NECESSARY TO SUPPORT EXISTING BRICK BARREL VAULTS
DW51	REMOVE EXISTING PLASTER/GYPSUM BOARD PARTITIONS ON STUD.
DW53	REMOVE PORTION OF MASONRY WALL BELOW WINDOW SILL TO ACCOMMODATE RECESSED FAN COIL UNIT.
DW55	FOR RADIATOR REMOVAL AROUND SPACE PERIMETER SEE MECHANICAL DRAWINGS (TYP)
DW56	REMOVE PLASTER AND LATH AT MASONRY WALLS. ALL PERIMETER WALLS AND ALL WINDOW POCKETS IN ROOM 007,009,010,011
DW61	REMOVE TEMPORARY PARTITION AND DOOR
DW70	REMOVE EXISTING MASONRY WALL FOR DOOR OPENING. REFER TO STRUCTURAL DRAWINGS.
DW73	CAREFULLY REMOVE EXISTING WINDOW, PROTECT AND STORE FOR REINSTALLATION.
DW75	CAREFULLY REMOVE AND SALVAGE EXISTING GATE
DW78	DEMOLITION OF WALL TO INCLUDE FOOTING BELOW
DW80	REMOVE TEMPORARY CONSTRUCTION PARTITIONS AT COMPLETION OF CONSTRUCTION.


KEYNOTE LEGEND	
DF61	DEMOLISH EXISTING WOOD FRAMED FLOOR
DF63	REMOVE EXISTING FLOOR SLAB AND STRUCTURE BELOW
DF68	DEMOLISH EXISTING SLAB BELOW STAIRS
DF70	EXCAVATE FOR PIPING TRENCH. REFER TO STRUCTURAL DRAWINGS FOR TRENCH DETAILS AND MEP DRAWINGS FOR PIPING AND CONDUIT.
DF71	EXISTING OPENING TO TUNNEL TO BE ENLARGED. SEE STRUCTURAL DRAWING FOR LINTEL.
DF72	REMOVE FLOORING AND EXCAVATE FOR TRENCH BELOW FLOOR. REFER TO STRUCTURAL AND MEP DRAWINGS.
DF73	FAN COIL UNIT PIPING WHICH RUNS AT CEILING OF LEVEL BELOW TO PENETRATE THROUGH FLOOR AT THIS AREA. SEE STRUCTURAL DRAWINGS FOR OPENINGS. COORDINATE FINAL SIZE AND LOCATION WITH HVAC CONTRACTOR. FIRESTOP PENETRATION.
DW06	ELECTRICAL CONTRACTOR TO REMOVE EXISTING ELECTRICAL SWITCHGEAR. SEE ELECTRICAL DRAWINGS
DW13	REMOVE PORTION OF EXISTING PARTITION WALL TO CREATE OPENING FOR MECHANICAL DUCTS. COORDINATE WITH MECHANICAL CONTRACTOR.

KEYNOTE LEGEND	
AF48	EXISTING STAIR. PROTECT DURING CONSTRUCTION
AF49	EXISTING OPENING IN FLOOR SLAB
AF112	EXISTING CONCRETE RAMP AND LANDING
AF126	EXISTING OPENING IN FLOOR
AW03	EXISTING CHILLER TO REMAIN. SEE MECHANICAL DRAWINGS.
AW72	EXISTING STEEL PICKET RAILING AT AREAWAY TO REMAIN. PROTECT DURING CONSTRUCTION.
DF04	REMOVE EXISTING RAMP SLAB
DF18	REMOVE FLOOR FINISH AND SAWCUT FLOOR SLAB FOR PIPING AND CONDUIT TRENCH. REFER TO STRUCTURAL DRAWINGS FOR TRENCH DETAILS AND MEP DRAWINGS FOR PIPING AND CONDUITS.
DF21	DISMANTLE PORTION OF WALL BELOW FINISH FLOOR TO ALLOW FOR PIPES TO PASS THROUGH. COORDINATE PIPE SPACE REQUIRED WITH HVAC, PLUMBING AND ELECTRICAL CONTRACTORS. SEE STRUCTURAL DRAWINGS FOR LINTELS.
DF45	DISMANTLE GRANITE STEPS AND STOOP CLADDING IN THE AREA INDICATED. STORE CLADDING TO BE REUSED IN A CLEAN AND DRY LOCATION. DISMANTLE SUPPORTING CONCRETE SLAB AND RAILING ATTACHED TO THE STEPS AND WALL.
DF50	REMOVE EXISTING FLOOR SLAB AND SUBFLOORING AND EXCAVATE TO ACCOMMODATE RAISED FLOOR. SEE STRUCTURAL DRAWINGS.

NOTE: SEE DRAWING G-001.00 FOR SELECTIVE DEMOLITION NOTES.

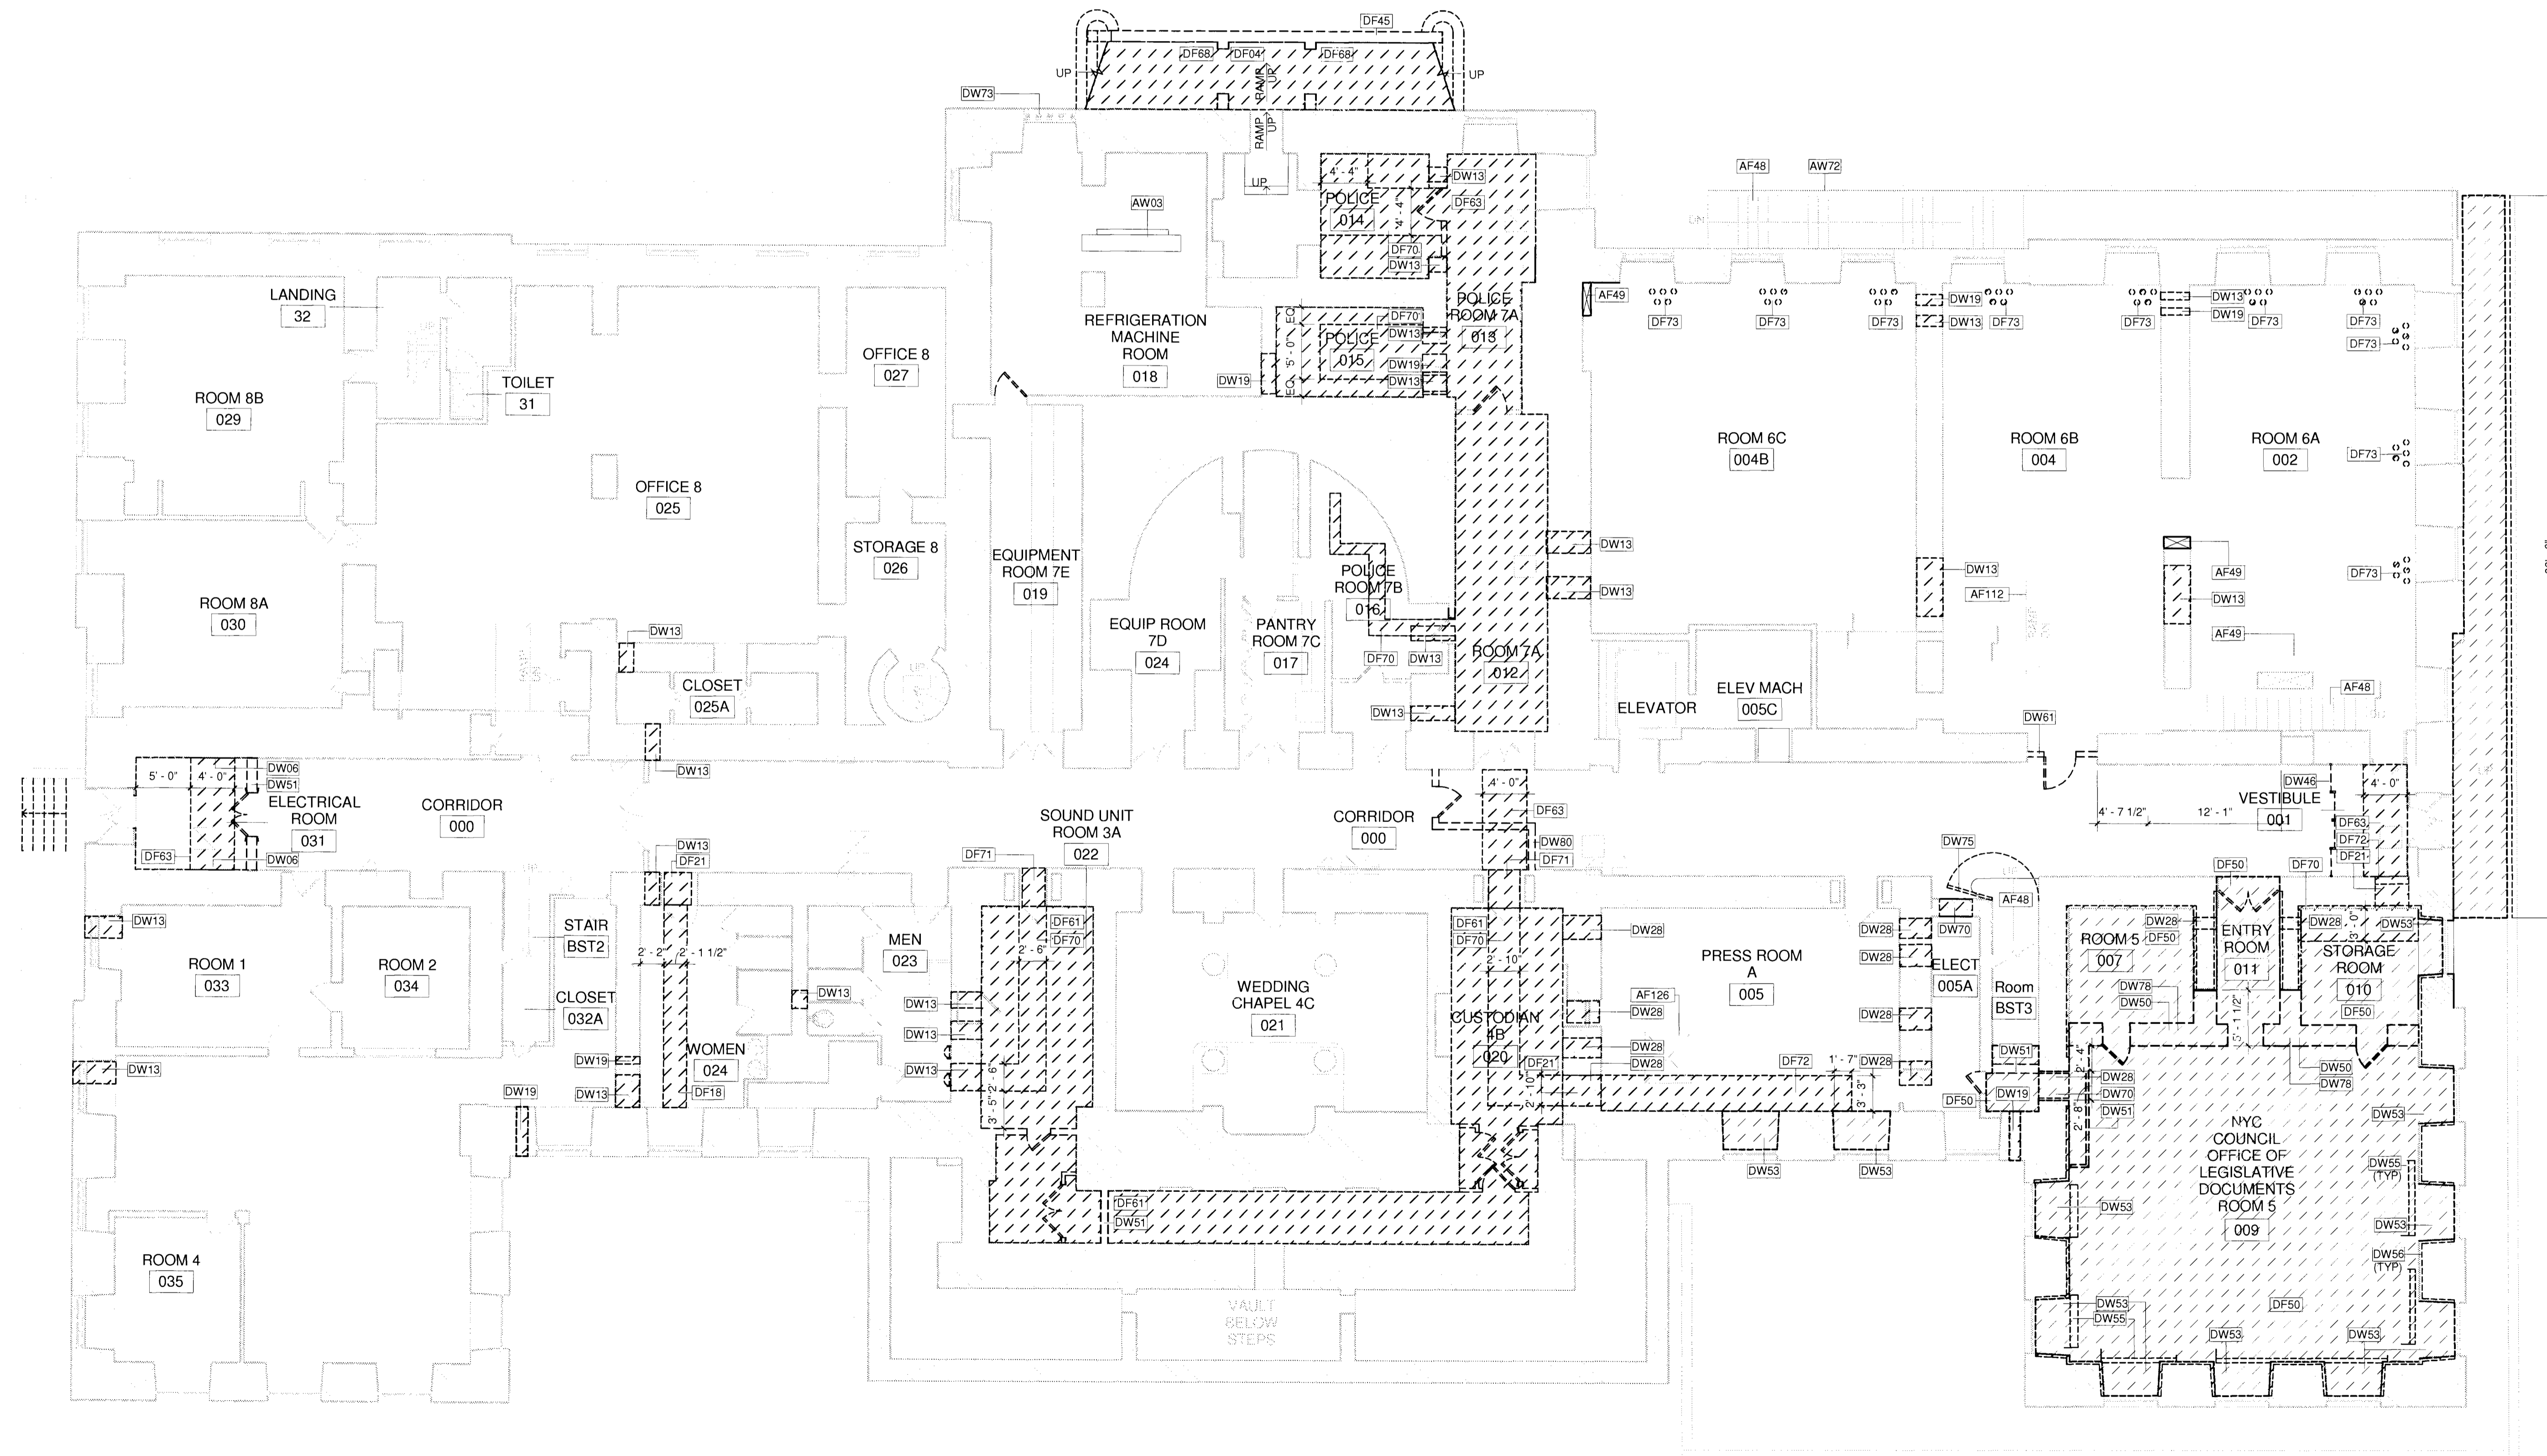

1
 DM-101.00
 Basement Demolition Plan
 1/8" = 1'-0"
 0' 2' 4' 8' 16'
 SCALE: 1/8" = 1'-0"

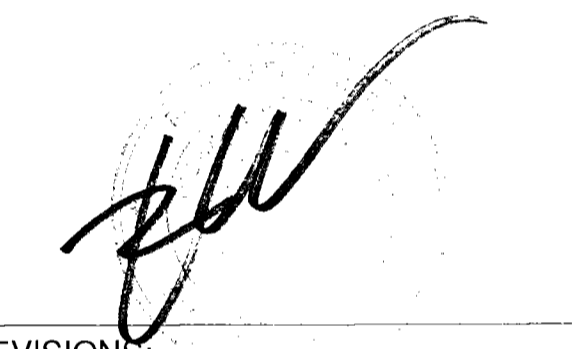SEAL:


REVISIONS:		
NUMBER	DESCRIPTION	DATE




NEW YORK CITY DEPARTMENT OF DESIGN + CONSTRUCTION
 DIVISION OF STRUCTURES
 BUREAU OF ARCHITECTURE & ENGINEERING
 CAPITAL PROJECT NUMBER: CITYHALL2
 PROJECT NAME: Renovation of City Hall Bid Package 2

FOR THE:
 DRAWING TITLE:
Basement Floor Demolition Plan

DRAWN BY: TB	SCALE: 1/8" = 1'-0"
CHECKED BY: NA	DATE: 10.08.10
DRAWING NUMBER:	



DM-101.00
 SHEET NUMBER:
 5 OF 42

REINHOLD CABELL
 SEE G-020R
 ACCEPTABLE FOR PERMIT
 ARCHITECT OF RECORD

 DEPT BLDGS: 120538223 Job Number
 SC133493812 Stamp Code
DOB PERMIT APPLICATION

KEYNOTE LEGEND	
DW33	DISMANTLE EXISTING WOOD DOOR(S) & SALVAGE FOR REUSE (SEE DOOR SCHEDULE)
DW41	DISMANTLE EXISTING WOOD DOOR (SEE DOOR SCHEDULE). DOCUMENT FOR FABRICATION OF NEW DOOR.
DW51	REMOVE EXISTING PLASTER/GYPSUM BOARD PARTITIONS ON STUD.
DW52	REMOVE PORTION OF EXISTING MASONRY WALL. PROVIDE SHORING FOR STRUCTURE ABOVE. SEE STRUCTURAL DRAWINGS
DW65	DISMANTLE EXISTING PAIR OF WOOD/GLASS DOORS. SALVAGE FOR REUSE. FRAME, SIDELIGHTS & TRANSOM TO REMAIN. SEE DOOR SCHEDULE.
DW67	REMOVE EXISTING MASONRY FOR INCREASED WIDTH OF NEW DOOR. SEE DOOR SCHEDULE FOR DOOR SIZE. SEE STRUCTURAL DRAWINGS FOR LINTELS.
DW79	EXISTING OPENING IN MASONRY WALL TO BE MADE DEEPER TO ACCOMMODATE NEW FAN COIL UNIT. TYPICAL OF FOUR. REFER TO MECHANICAL AND STRUCTURAL DRAWINGS.
DW80	REMOVE TEMPORARY CONSTRUCTION PARTITIONS AT COMPLETION OF CONSTRUCTION.

KEYNOTE LEGEND	
DF76	REMOVE EXISTING VCT FLOOR FINISH.
DW10	REMOVE PORTION OF EXISTING MASONRY BELOW FLOOR AT WINDOW TO CREATE SPACE FOR MECHANICAL PIPING. SEE STRUCTURAL AND MECHANICAL DRAWINGS
DW13	REMOVE PORTION OF EXISTING PARTITION WALL TO CREATE OPENING FOR MECHANICAL DUCTS. COORDINATE WITH MECHANICAL CONTRACTOR.
DW16	DISMANTLE MASONRY WALL FROM FLOOR TO CEILING FOR INSTALLATION OF STANDPIPE BY THE HVAC CONTRACTOR. COORDINATE SIZE AND LOCATION WITH CONTRACTOR.
DW17	REMOVE EXISTING RADIATOR ENCLOSURE AND METAL SURROUNDS.
DW18	REMOVE EXISTING SHELVING AND ALL CABINET WORK AT WINDOW ALCOVE.
DW28	REMOVE EXISTING MASONRY TO CREATE WALL OPENING. SEE STRUCTURAL DRAWINGS FOR SIZE AND LINTELS. COORDINATE WITH HVAC CONTRACTOR FOR LOCATION AND CONFIRM SIZE.

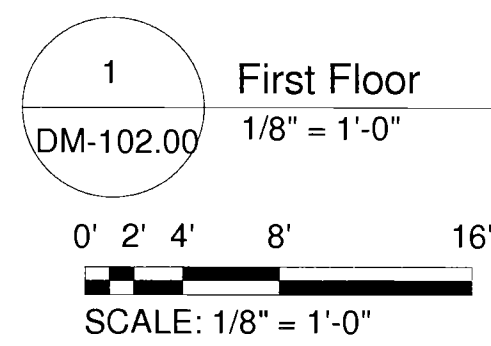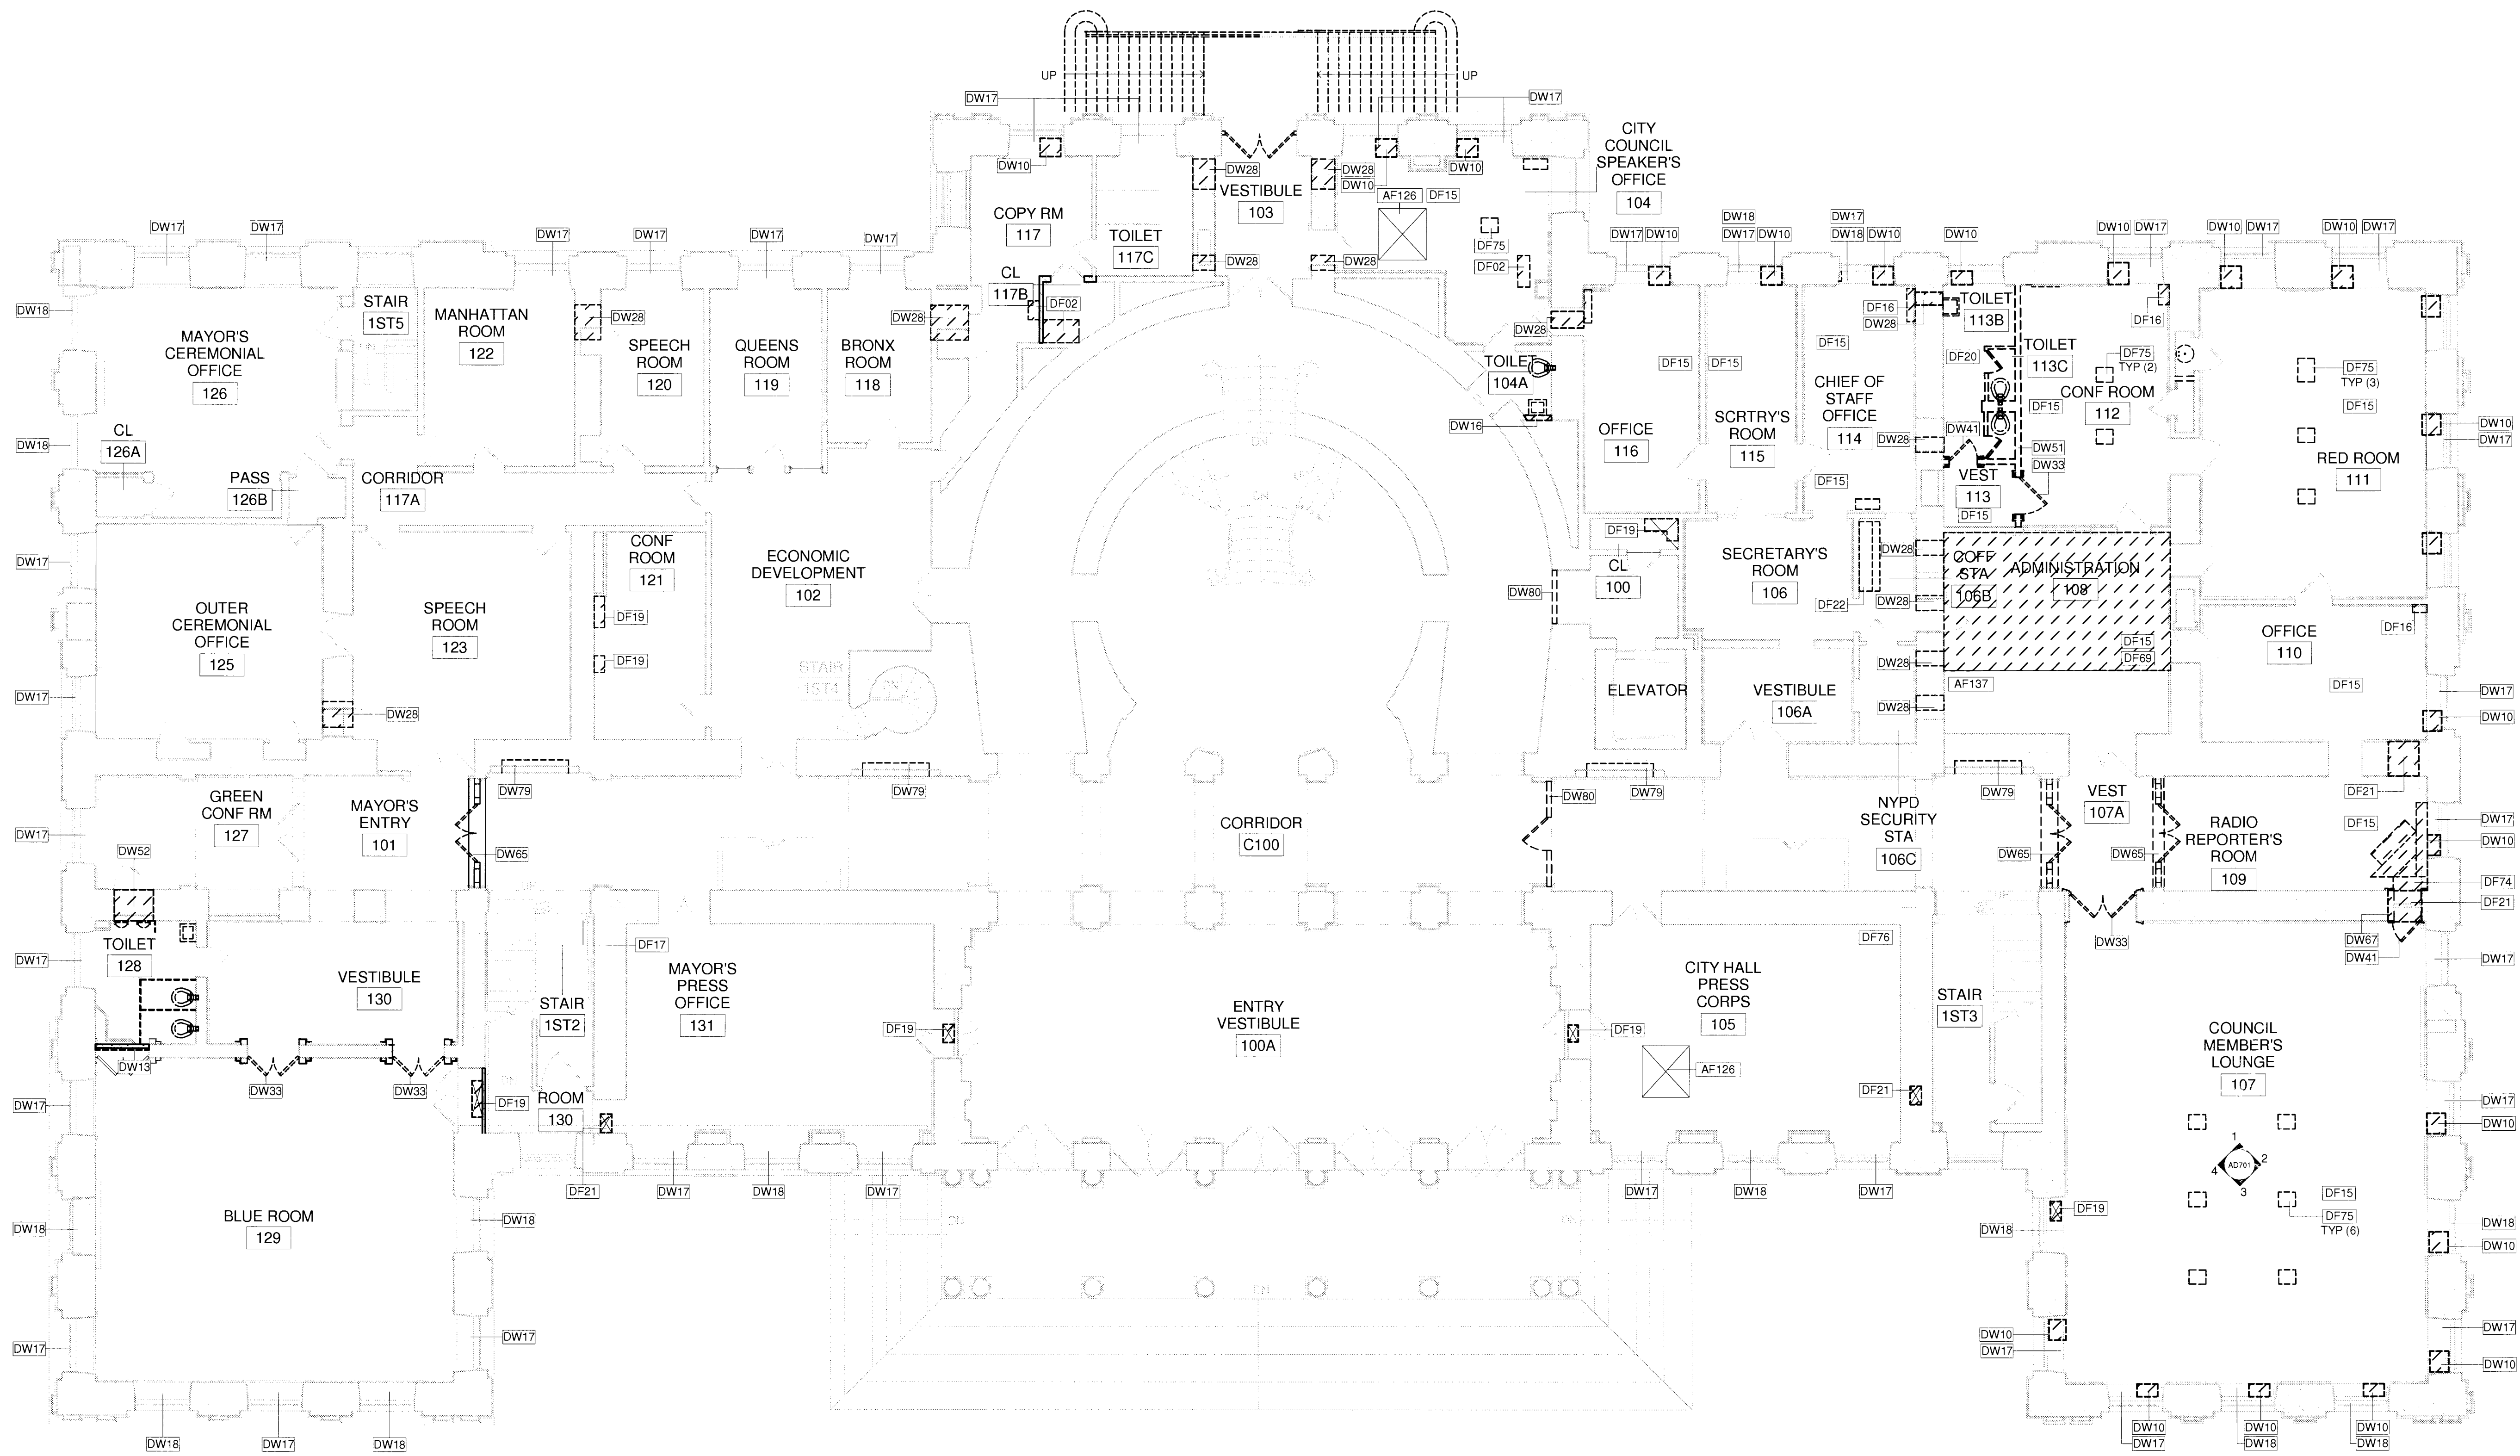KEYNOTE LEGEND	
AF126	EXISTING OPENING IN FLOOR
AF137	EXISTING EXPOSED SHEATHING
DF02	REMOVE FLOOR FRAMING AND FLOORING. SEE STRUCTURAL DRAWINGS
DF15	REMOVE EXISTING CARPET AND UNDERLAYMENT. CLEAN ADHESIVE RESIDUE FROM THE WOOD OR MARBLE FLOOR.
DF16	REMOVE WOOD FLOORING IN A CAREFUL MANNER THAT WILL ALLOW FOR ITS REINSTALLATION. COORDINATE PIPE SPACE REQUIRED WITH HVAC AND ELECTRICAL CONTRACTORS.
DF17	CORE DRILL HOLES IN FLOOR AND CEILING FOR NEW RISER. COORDINATE SIZE AND LOCATION WITH HVAC CONTRACTORS.
DF19	REMOVE FLOOR FINISH AND WOOD JOISTS. SEE STRUCTURAL DRAWINGS FOR REFRAMING THE OPENING
DF20	REMOVE EXISTING FLOORING AND UNDERLAYMENT.
DF21	DISMANTLE PORTION OF WALL BELOW FINISH FLOOR TO ALLOW FOR PIPES TO PASS THROUGH. COORDINATE PIPE SPACE REQUIRED WITH HVAC, PLUMBING AND ELECTRICAL CONTRACTORS. SEE STRUCTURAL DRAWINGS FOR LINTELS.
DF22	DISMANTLE COUNTER TOP, CABINET WORK AND SHELVING ABOVE.
DF69	REMOVE EXISTING HARDWOOD PLANKS. NUMBER THEM AND STORE IN A SAFE, DRY PLACE FOR REINSTALLATION.
DF74	CAREFULLY REMOVE MARBLE FLOORING AND PROTECT FOR REINSTALLATION AFTER COMPLETION OF MECHANICAL WORK. SEE STRUCTURAL DRAWING FOR DETAILS OF TRENCH BELOW FLOOR. COORDINATE FINAL LOCATION WITH MECHANICAL CONTRACTOR.
DF75	REMOVE PORTION OF EXISTING FLOOR & SUBFLOOR FOR NEW FLOOR BOX



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NEW YORK CITY DEPARTMENT OF DESIGN + CONSTRUCTION
 DIVISION OF STRUCTURES
 BUREAU OF ARCHITECTURE & ENGINEERING

CAPITAL PROJECT NUMBER:
 CITYHALL2
 PROJECT NAME:
 Renovation of City Hall
 Bid Package 2


FOR THE:

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 Demolition Plan**

DRAWN BY: TB SCALE: 1/8" = 1'-0"
 CHECKED BY: NA DATE: 10.08.10

DRAWING NUMBER:
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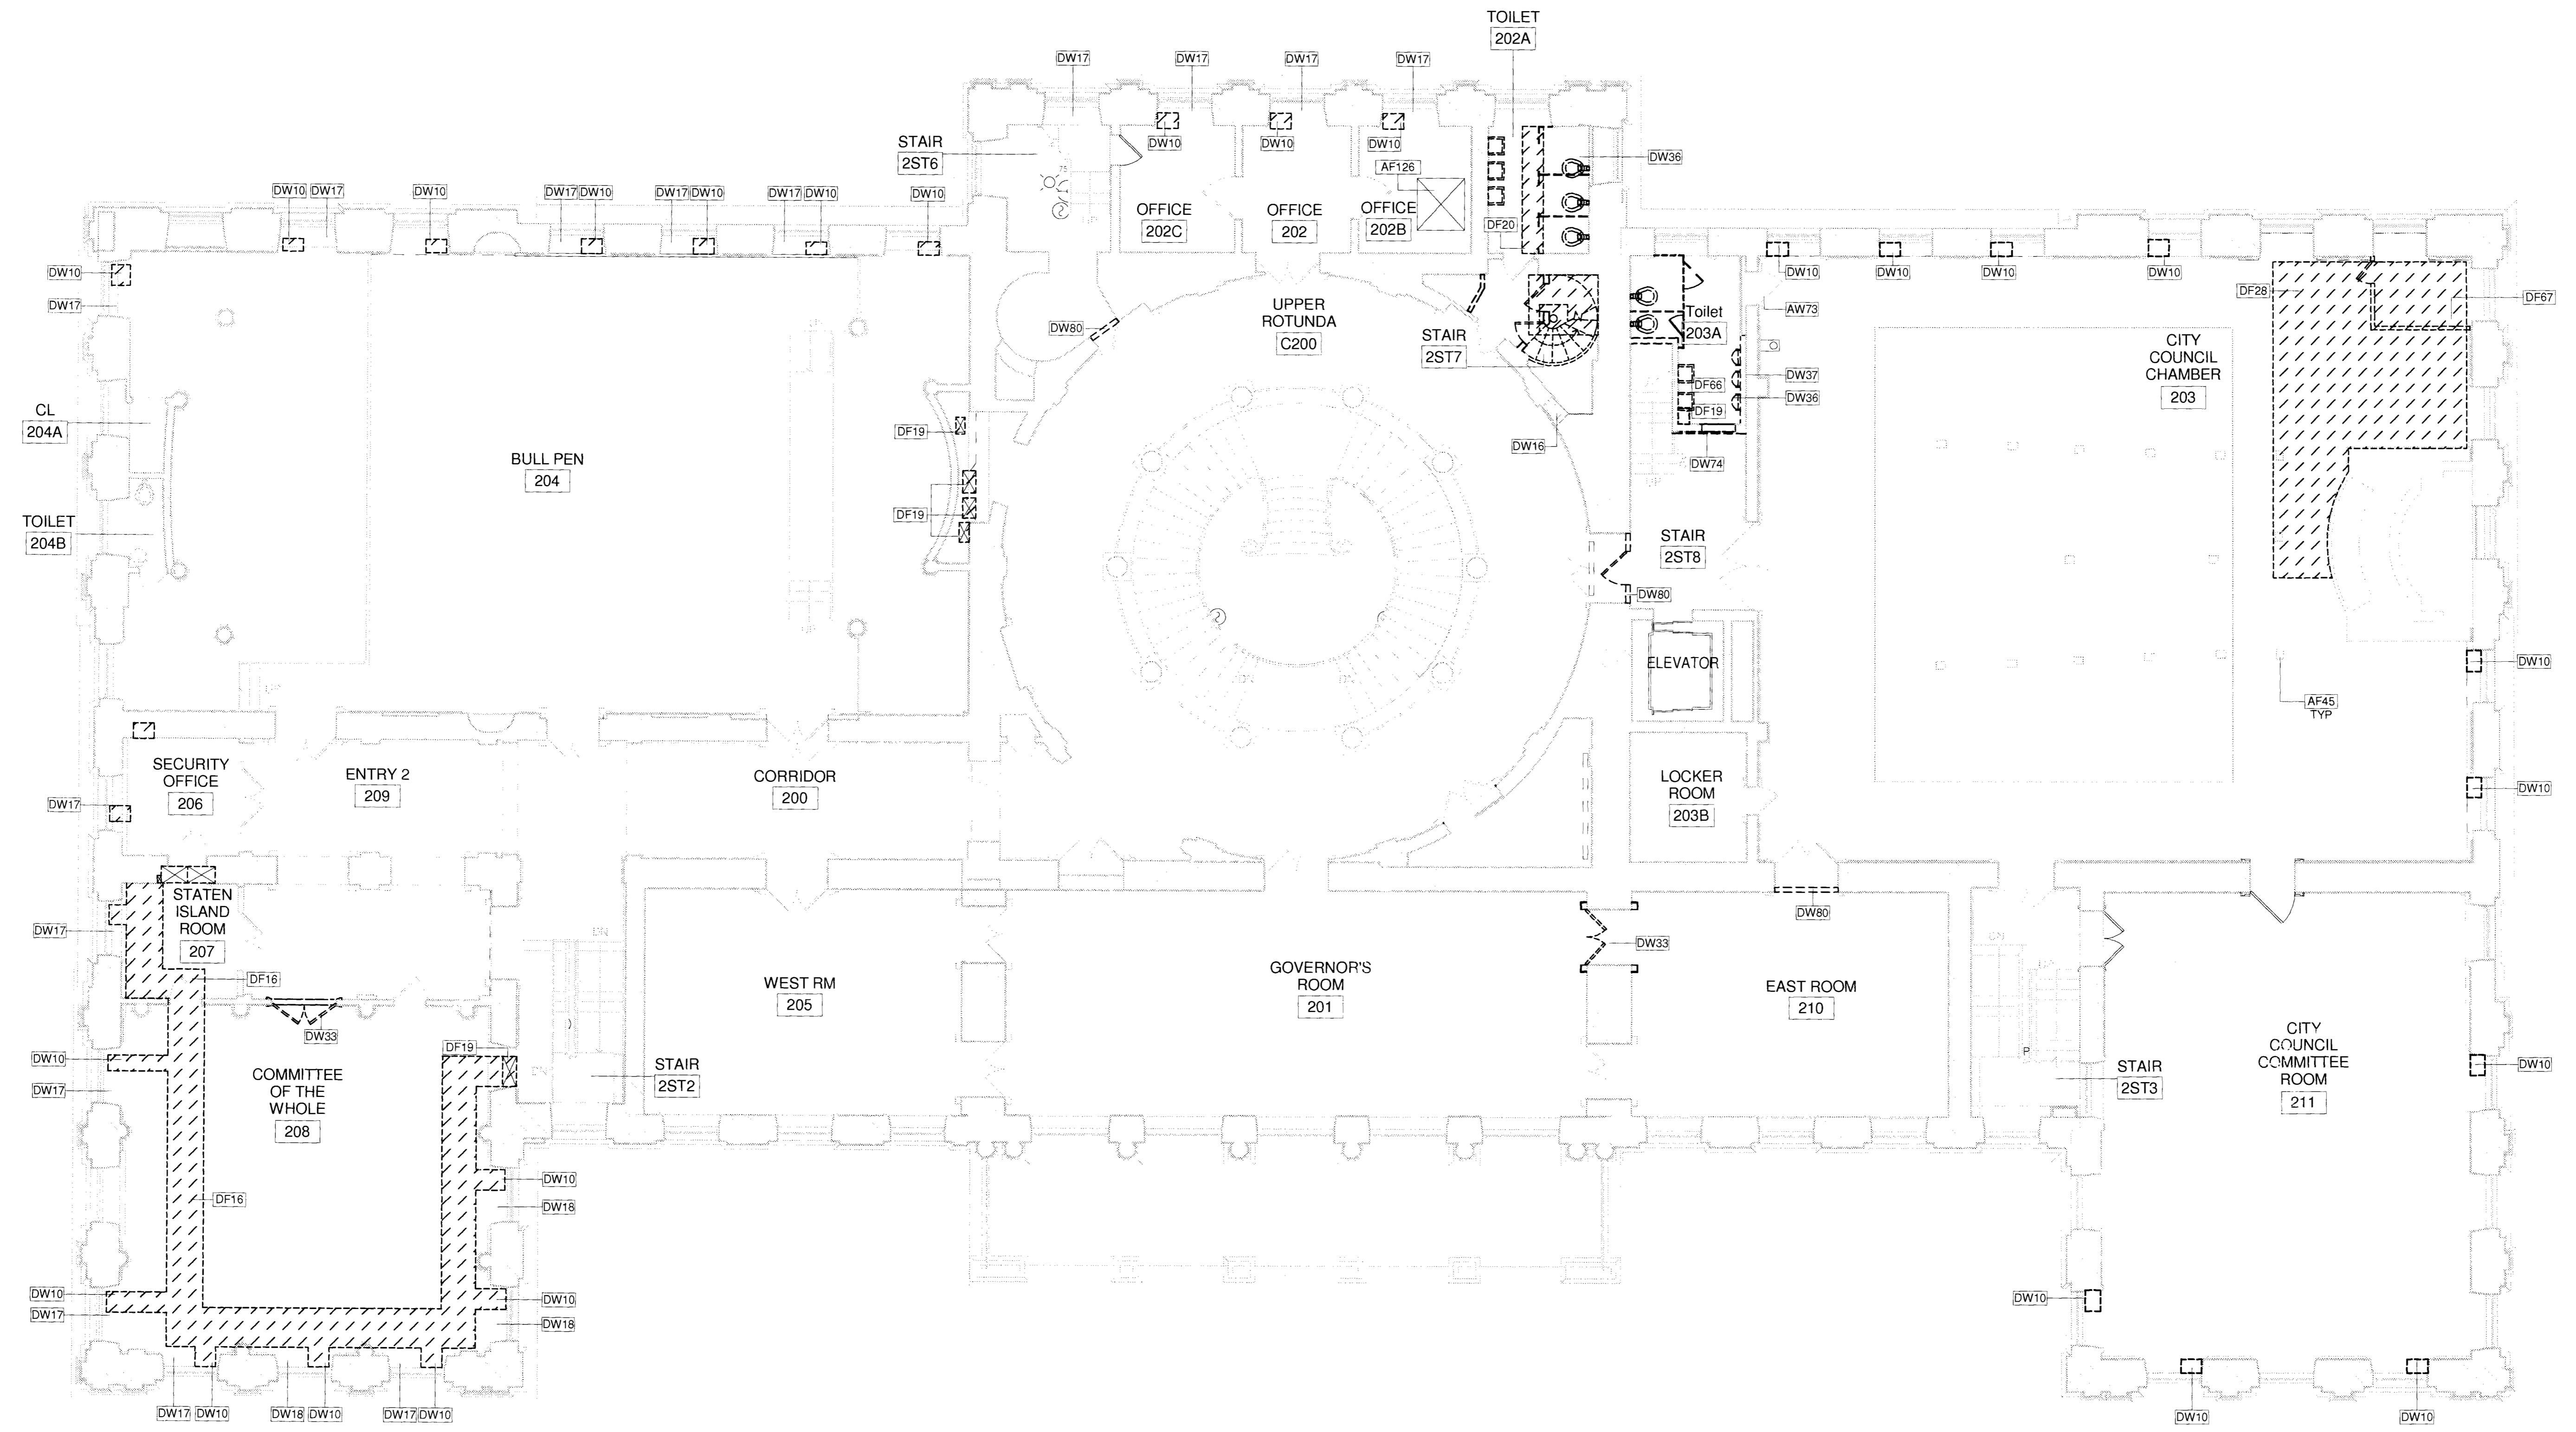
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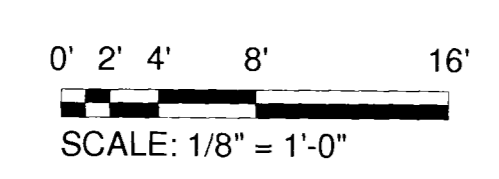
2 Balcony Floor
 DM-103.00 1/8" = 1'-0"

KEYNOTE LEGEND	
DW36	REMOVE EXISTING WALL ACCESSORIES. PLUMBING FIXTURE REMOVAL BY PLUMBING CONTRACTOR. SEE PLUMBING DRAWINGS
DW37	REMOVE EXISTING CHASE WALL
DW41	DISMANTLE EXISTING WOOD DOOR (SEE DOOR SCHEDULE). DOCUMENT FOR FABRICATION OF NEW DOOR.
DW74	CAREFULLY DISASSEMBLE & SALVAGE EXISTING WOOD PANELING FOR REUSE. PROVIDE NEW OPENING FOR DOOR
DW80	REMOVE TEMPORARY CONSTRUCTION PARTITIONS AT COMPLETION OF CONSTRUCTION.

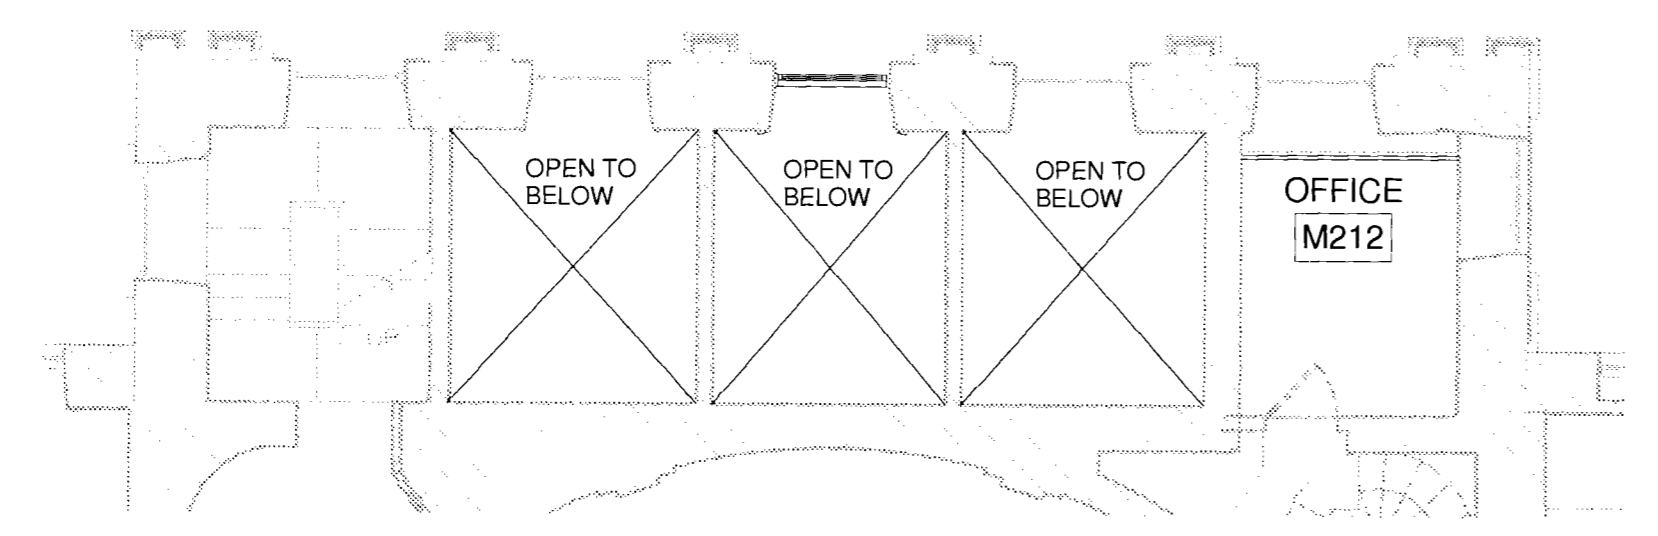KEYNOTE LEGEND	
AF45	EXISTING FLOOR ELECTRIC OUTLET TO REMAIN
AF126	EXISTING OPENING IN FLOOR
AW73	EXISTING WOOD DOOR TO REMAIN. SEE DOOR SCHEDULE
DF16	REMOVE WOOD FLOORING IN A CAREFUL MANNER THAT WILL ALLOW FOR ITS REINSTALLATION. COORDINATE PIPE SPACE REQUIRED WITH HVAC AND ELECTRICAL CONTRACTORS.
DF19	REMOVE FLOOR FINISH AND WOOD JOISTS. SEE STRUCTURAL DRAWINGS FOR REFRAMING THE OPENING
DF20	REMOVE EXISTING FLOORING AND UNDERLAYMENT.
DF28	REMOVE EXISTING WOOD PLANK FLOORING TO EXPOSED FLOOR JOISTS. NOTCH OUT TOP OF WOOD JOISTS TO ALLOW BRANCH PIPING TO RUN PERPENDICULAR TO THE DIRECTION OF JOISTS. SEE STRUCTURAL AND MECHANICAL DRAWINGS.
DF66	REMOVE EXISTING FLOOR TILE AND SETTING BED
DF67	DISMANTLE EXISTING WOOD AUDIO BOOTH WALLS AND PLATFORM
DW10	REMOVE PORTION OF EXISTING MASONRY BELOW FLOOR AT WINDOW TO CREATE SPACE FOR MECHANICAL PIPING. SEE STRUCTURAL AND MECHANICAL DRAWINGS
DW16	DISMANTLE MASONRY WALL FROM FLOOR TO CEILING FOR INSTALLATION OF STANDPIPE BY THE HVAC CONTRACTOR. COORDINATE SIZE AND LOCATION WITH CONTRACTOR.
DW17	REMOVE EXISTING RADIATOR ENCLOSURE AND METAL SURROUNDS.
DW18	REMOVE EXISTING SHELVING AND ALL CABINET WORK AT WINDOW ALCOVE
DW33	DISMANTLE EXISTING WOOD DOOR(S) & SALVAGE FOR REUSE (SEE DOOR SCHEDULE)



1 Second Floor
 DM-103.00 1/8" = 1'-0"



SEAL

REVISIONS:

NUMBER	DESCRIPTION	DATE



DIVISION OF STRUCTURES
 BUREAU OF ARCHITECTURE & ENGINEERING
 CAPITAL PROJECT NUMBER:
 CITYHALL2
 PROJECT NAME:
 Renovation of City Hall
 Bid Package 2

FOR THE:
 DRAWING TITLE:
**Second Floor
 Demolition Plan**

REVISIONS
 10/8/10
 10/8/10

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 CHECKED BY: NA DATE: 10.08.10

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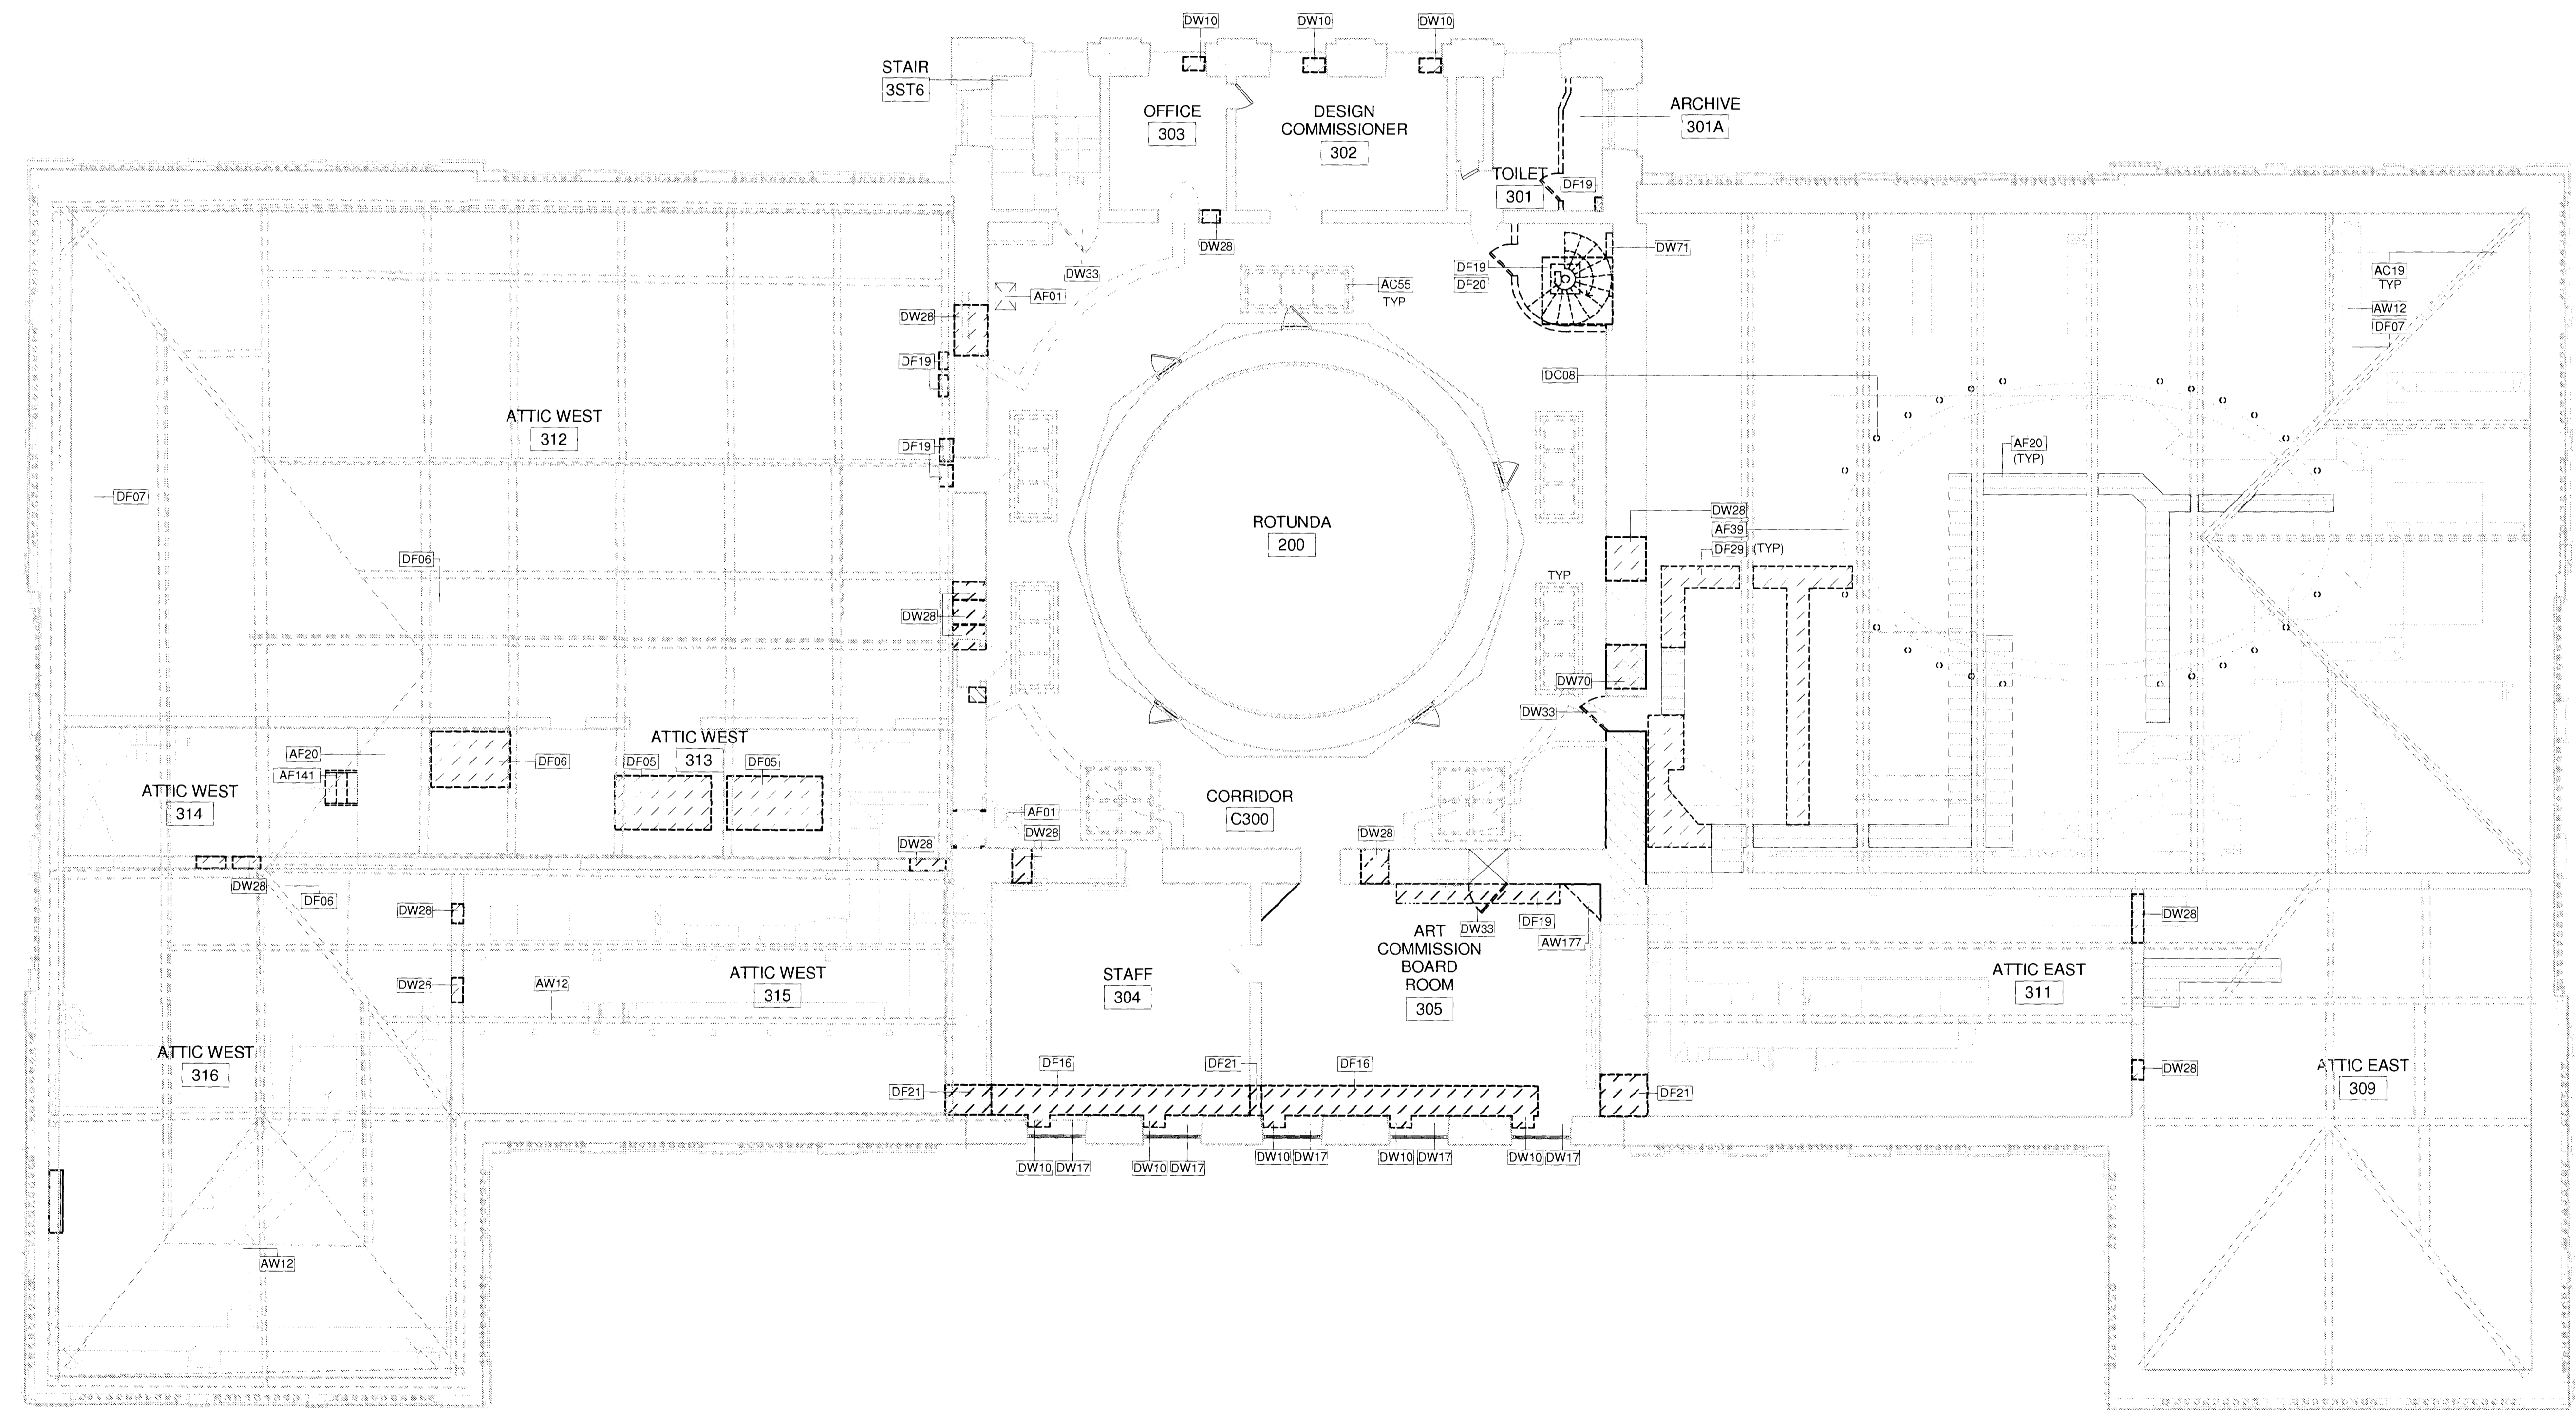


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SHEET NUMBER:
 7 OF 42

KEYNOTE LEGEND	
DF20	REMOVE EXISTING FLOORING AND UNDERLAYMENT.
DF21	DISMANTLE PORTION OF WALL BELOW FINISH FLOOR TO ALLOW FOR PIPES TO PASS THROUGH. COORDINATE PIPE SPACE REQUIRED WITH HVAC, PLUMBING AND ELECTRICAL CONTRACTORS. SEE STRUCTURAL DRAWINGS FOR LINTELS.
DF29	DISMANTLE EXISTING CATWALK & GRATING FOR FUTURE REUSE
DW10	REMOVE PORTION OF EXISTING MASONRY BELOW FLOOR AT WINDOW TO CREATE SPACE FOR MECHANICAL PIPING. SEE STRUCTURAL AND MECHANICAL DRAWINGS
DW17	REMOVE EXISTING RADIATOR ENCLOSURE AND METAL SURROUNDS.
DW28	REMOVE EXISTING MASONRY TO CREATE WALL OPENING. SEE STRUCTURAL DRAWINGS FOR SIZE AND LINTELS. COORDINATE WITH HVAC CONTRACTOR FOR LOCATION AND CONFIRM SIZE.
DW33	DISMANTLE EXISTING WOOD DOOR(S) & SALVAGE FOR REUSE (SEE DOOR SCHEDULE)
DW70	REMOVE EXISTING MASONRY WALL FOR DOOR OPENING. REFER TO STRUCTURAL DRAWINGS.
DW71	DISMANTLE EXISTING MASONRY WALL TO CREATE SPACE FOR ELEVATOR SHAFT. SEE STRUCTURAL DRAWINGS

KEYNOTE LEGEND	
AC19	LINES OF ROOF TRUSS ABOVE
AC55	SKYLIGHT (ABOVE) TO REMAIN
AF01	EXISTING FLOOR HATCH TO REMAIN (TYP)
AF20	EXISTING METAL GRATING
AF39	PROTECT EXISTING MURAL FRAME
AF141	EXISTING WOOD STAIR TO BE RELOCATED AFTER INSTALLATION OF NEW MECHANICAL EQUIPMENT.
AW12	EXISTING DUCTWORK TO REMAIN - REFER TO MECHANICAL DRAWINGS
AW177	EXISTING FREESTANDING ANTIQUE CABINET: CAREFULLY RELOCATE TO OPPOSITE CORNER & PROTECT DURING CONSTRUCTION
DC08	ELECTRICAL CONTRACTOR TO REMOVE EXISTING DOWNLIGHT FIXTURES
DF05	MECHANICAL CONTRACTOR TO REMOVE EXISTING COOLING TOWER. SEE MECHANICAL DRAWINGS
DF06	MECHANICAL CONTRACTOR TO REMOVE EXISTING AIR HANDLING UNIT AND RELATED DUCTWORK. SEE MECHANICAL DRAWINGS
DF07	MECHANICAL CONTRACTOR TO REMOVE EXISTING DUCT WORK. SEE MECHANICAL DRAWINGS
DF16	REMOVE WOOD FLOORING IN A CAREFUL MANNER THAT WILL ALLOW FOR ITS REINSTALLATION. COORDINATE PIPE SPACE REQUIRED WITH HVAC AND ELECTRICAL CONTRACTORS.
DF19	REMOVE FLOOR FINISH AND WOOD JOISTS. SEE STRUCTURAL DRAWINGS FOR REFRAMING THE OPENING



1 Third Floor
DM-104.00
1/8" = 1'-0"
0' 2' 4' 8' 16'
SCALE: 1/8" = 1'-0"

SEAL

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REVISIONS:

NUMBER	DESCRIPTION	DATE



NEW YORK CITY DEPARTMENT OF DESIGN + CONSTRUCTION
DIVISION OF STRUCTURES
BUREAU OF ARCHITECTURE & ENGINEERING

CAPITAL PROJECT NUMBER:
CITYHALL2
PROJECT NAME:
Renovation of City Hall
Bid Package 2

FOR THE:

DRAWING TITLE:
**Third Floor
Demolition Plan**

REINHOLD GABEL


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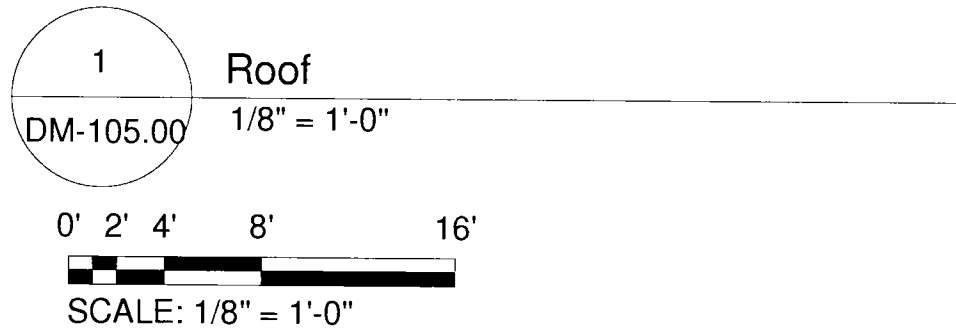
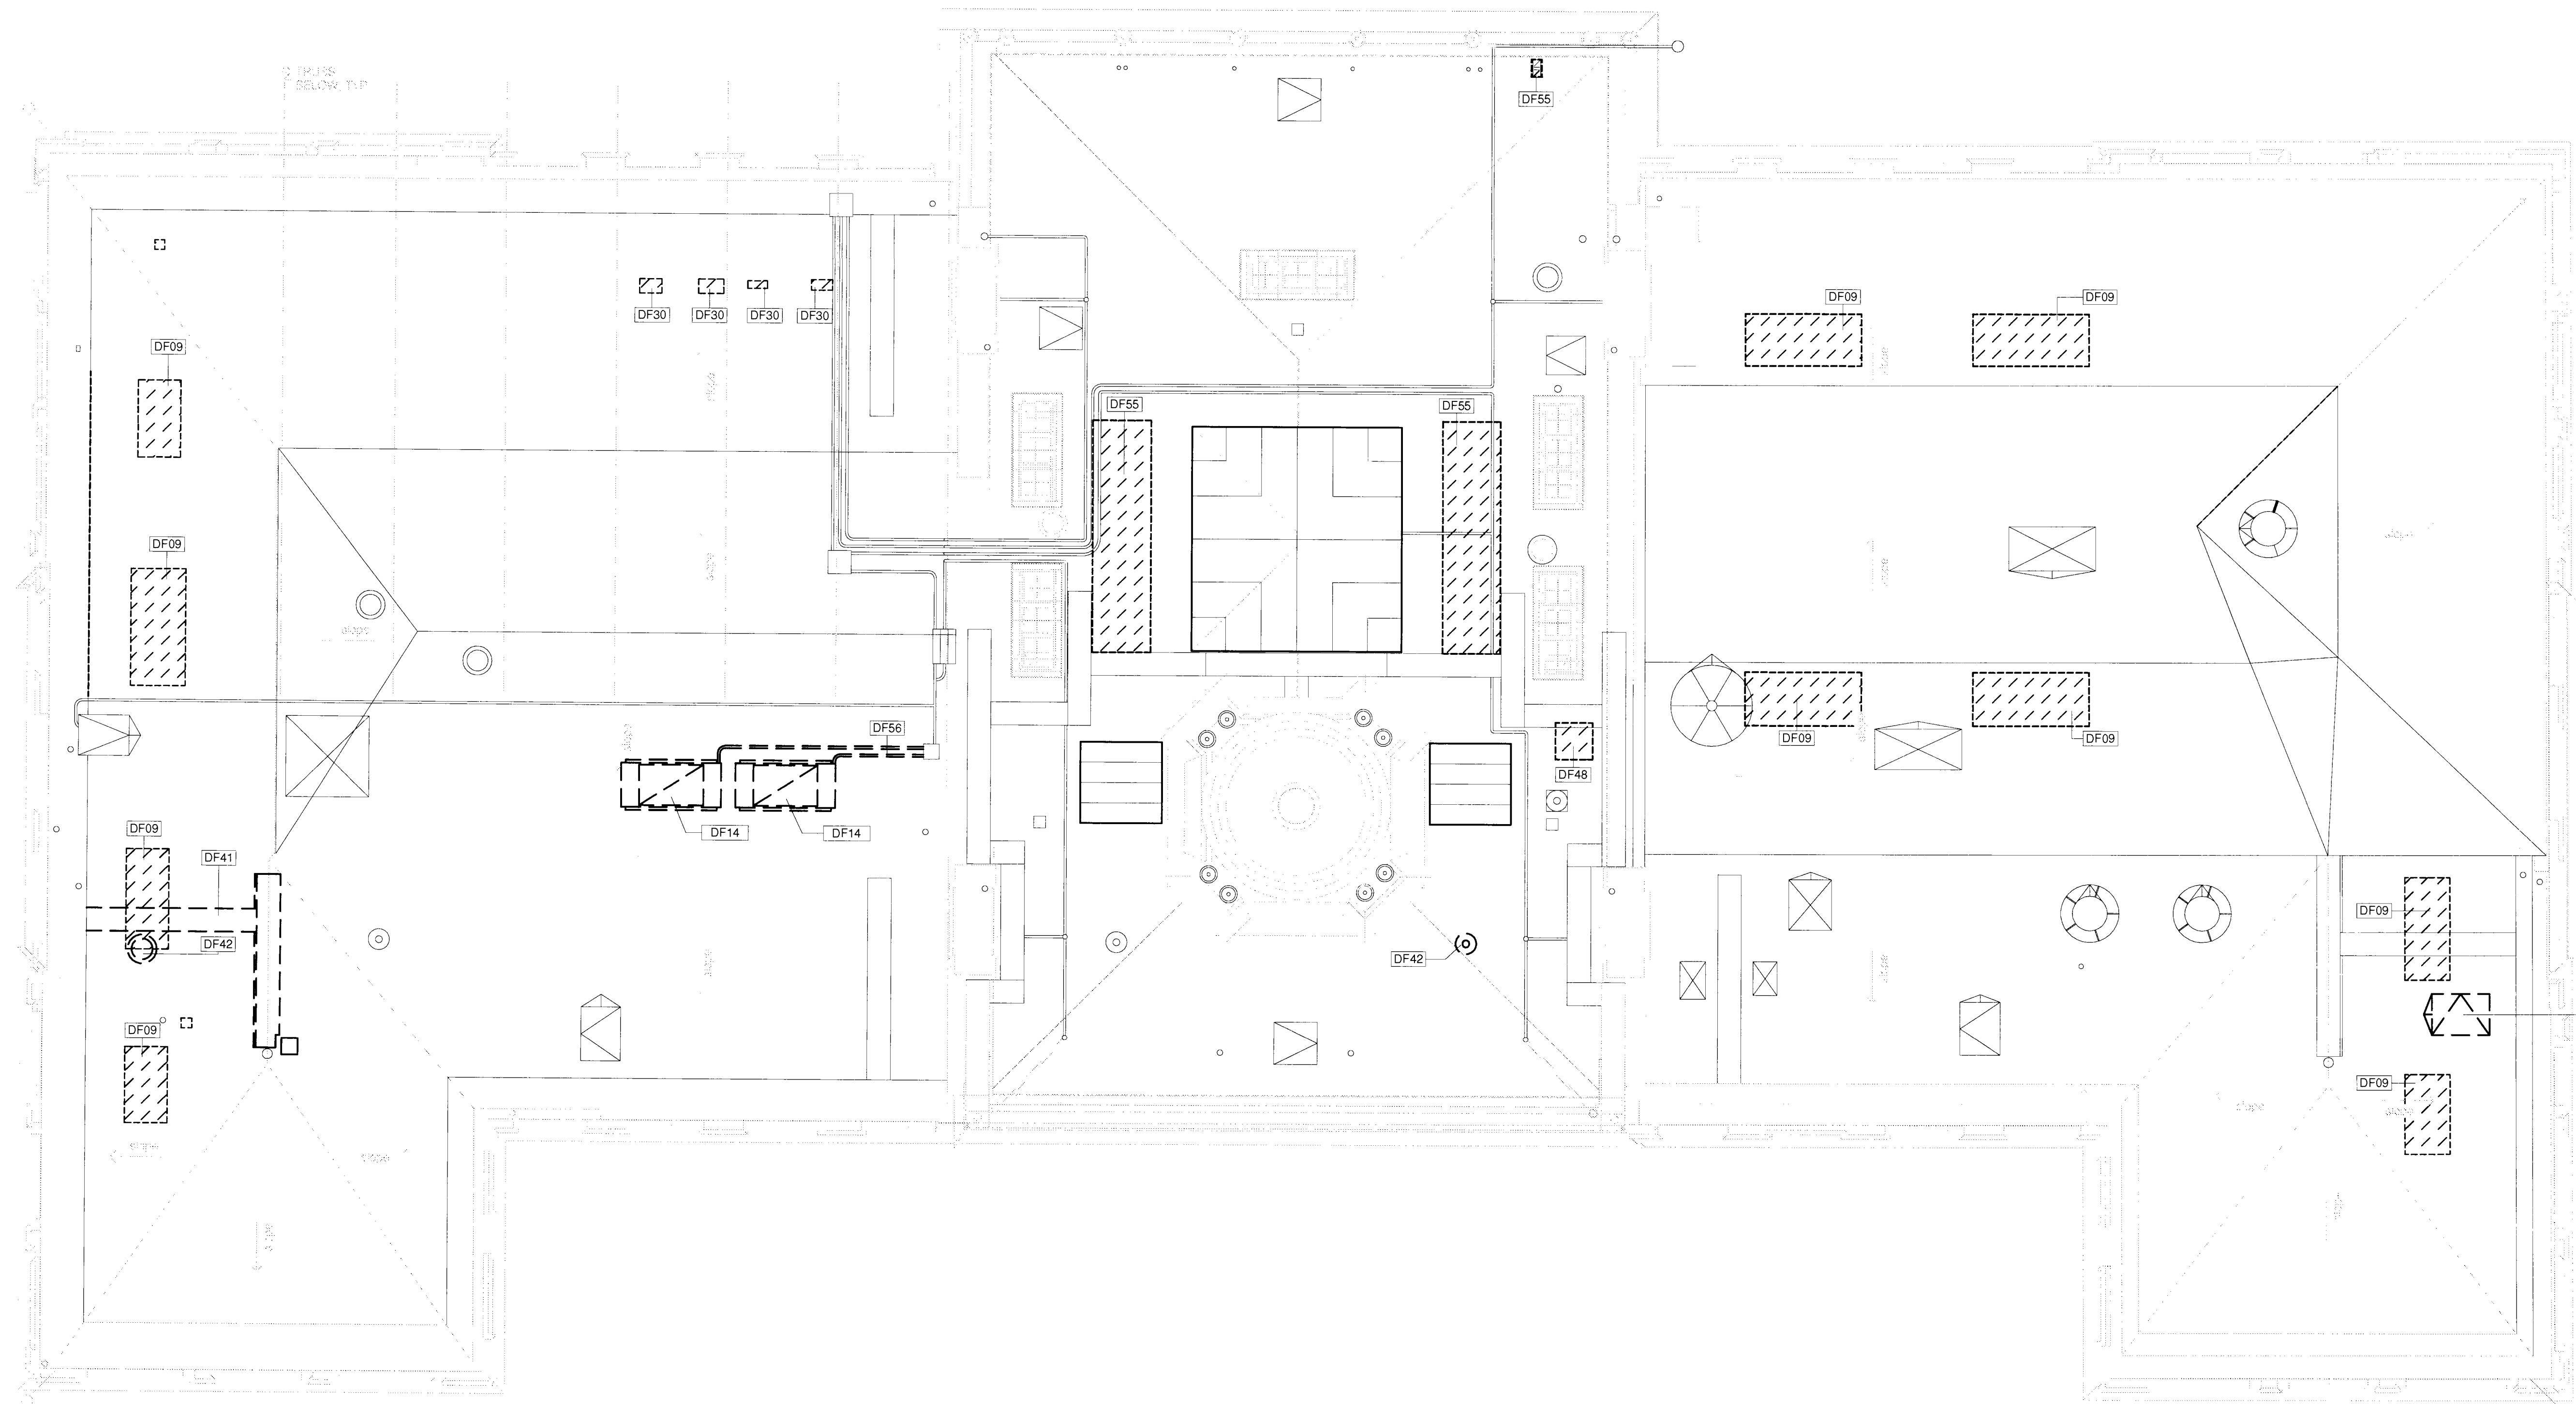


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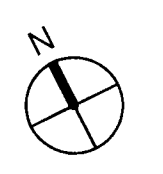
SHEET NUMBER:
8 OF 42

KEYNOTE LEGEND	
DF09	REMOVE ROOFING AND SHEATHING TO PROVIDE OPENING FOR MECHANICAL PENTHOUSE. MECHANICAL PENTHOUSE PROVIDED UNDER SEPARATE CONTRACT. SEE MECHANICAL DRAWINGS AND COORDINATE WITH MECHANICAL CONTRACTOR. REFER TO STRUCTURAL DRAWINGS FOR ROOF OPENINGS.
DF14	REMOVE EXISTING ROOF RELIEF HOOD. SEE MECHANICAL DRAWINGS
DF30	CREATE OPENING FOR MECHANICAL EQUIPMENT
DF41	REMOVE EXISTING METAL WALKWAYS, DUNNAGE & RAILINGS
DF42	REMOVE EXISTING VENTILATOR
DF44	REMOVE EXISTING ACCESS HATCH
DF48	PROVIDE ROOF OPENING FOR NEW ACCESS HATCH LOCATION
DF55	REMOVE EXISTING ROOFING AND CONCRETE ROOF DECK TO PROVIDE NEW MECHANICAL OPENING. SEE HVAC DWGS
DF56	

NOTE: PROVIDE TEMPORARY PROTECTION ON ALL ROOF OPENINGS UNTIL CONSTRUCTION OF PENTHOUSES, HATCHES, VENTS OR OTHER STRUCTURES IN BID PACKAGE 3

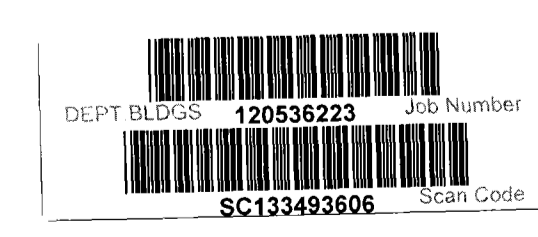

RICHARD GABEL
 DEC 2 8 2019
 ACCOUNTABLE FOR PERMIT
 SUBMITTANTIVE NO. 141925



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NEW YORK CITY DEPARTMENT OF DESIGN + CONSTRUCTION
 DIVISION OF STRUCTURES
 BUREAU OF ARCHITECTURE & ENGINEERING
 CAPITAL PROJECT NUMBER:
 CITYHALL2
 PROJECT NAME:
 Renovation of City Hall
 Bid Package 2

FOR THE:


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Roof Demolition Plan

DRAWN BY: TB SCALE: 1/8" = 1'-0"
 CHECKED BY: NA DATE: 10.08.10

DRAWING NUMBER:
DM-105.00

SHEET NUMBER:
 9 OF 42

KEYNOTE LEGEND	
AW27	EXISTING WALL OPENING
AW120	EXISTING CMU WALLS

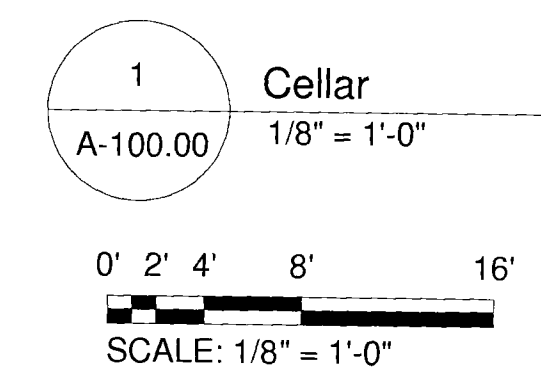

SEAL:

REVISIONS:		
NUMBER	DESCRIPTION	DATE





NEW YORK CITY DEPARTMENT OF DESIGN + CONSTRUCTION
 DIVISION OF STRUCTURES
 BUREAU OF ARCHITECTURE & ENGINEERING
 CAPITAL PROJECT NUMBER:
CITYHALL2
 PROJECT NAME:
 Renovation of City Hall
 Bid Package 2

FOR THE:

DRAWING TITLE:
Cellar Floor Plan

REWARD GABEL
 DEC 20 2008
 NEW YORK STATE PERMIT
 LICENSE NO. 141977

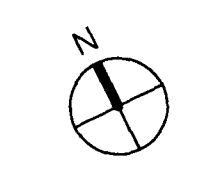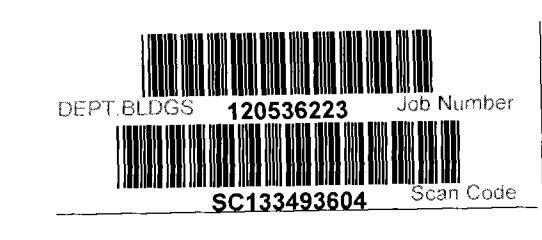

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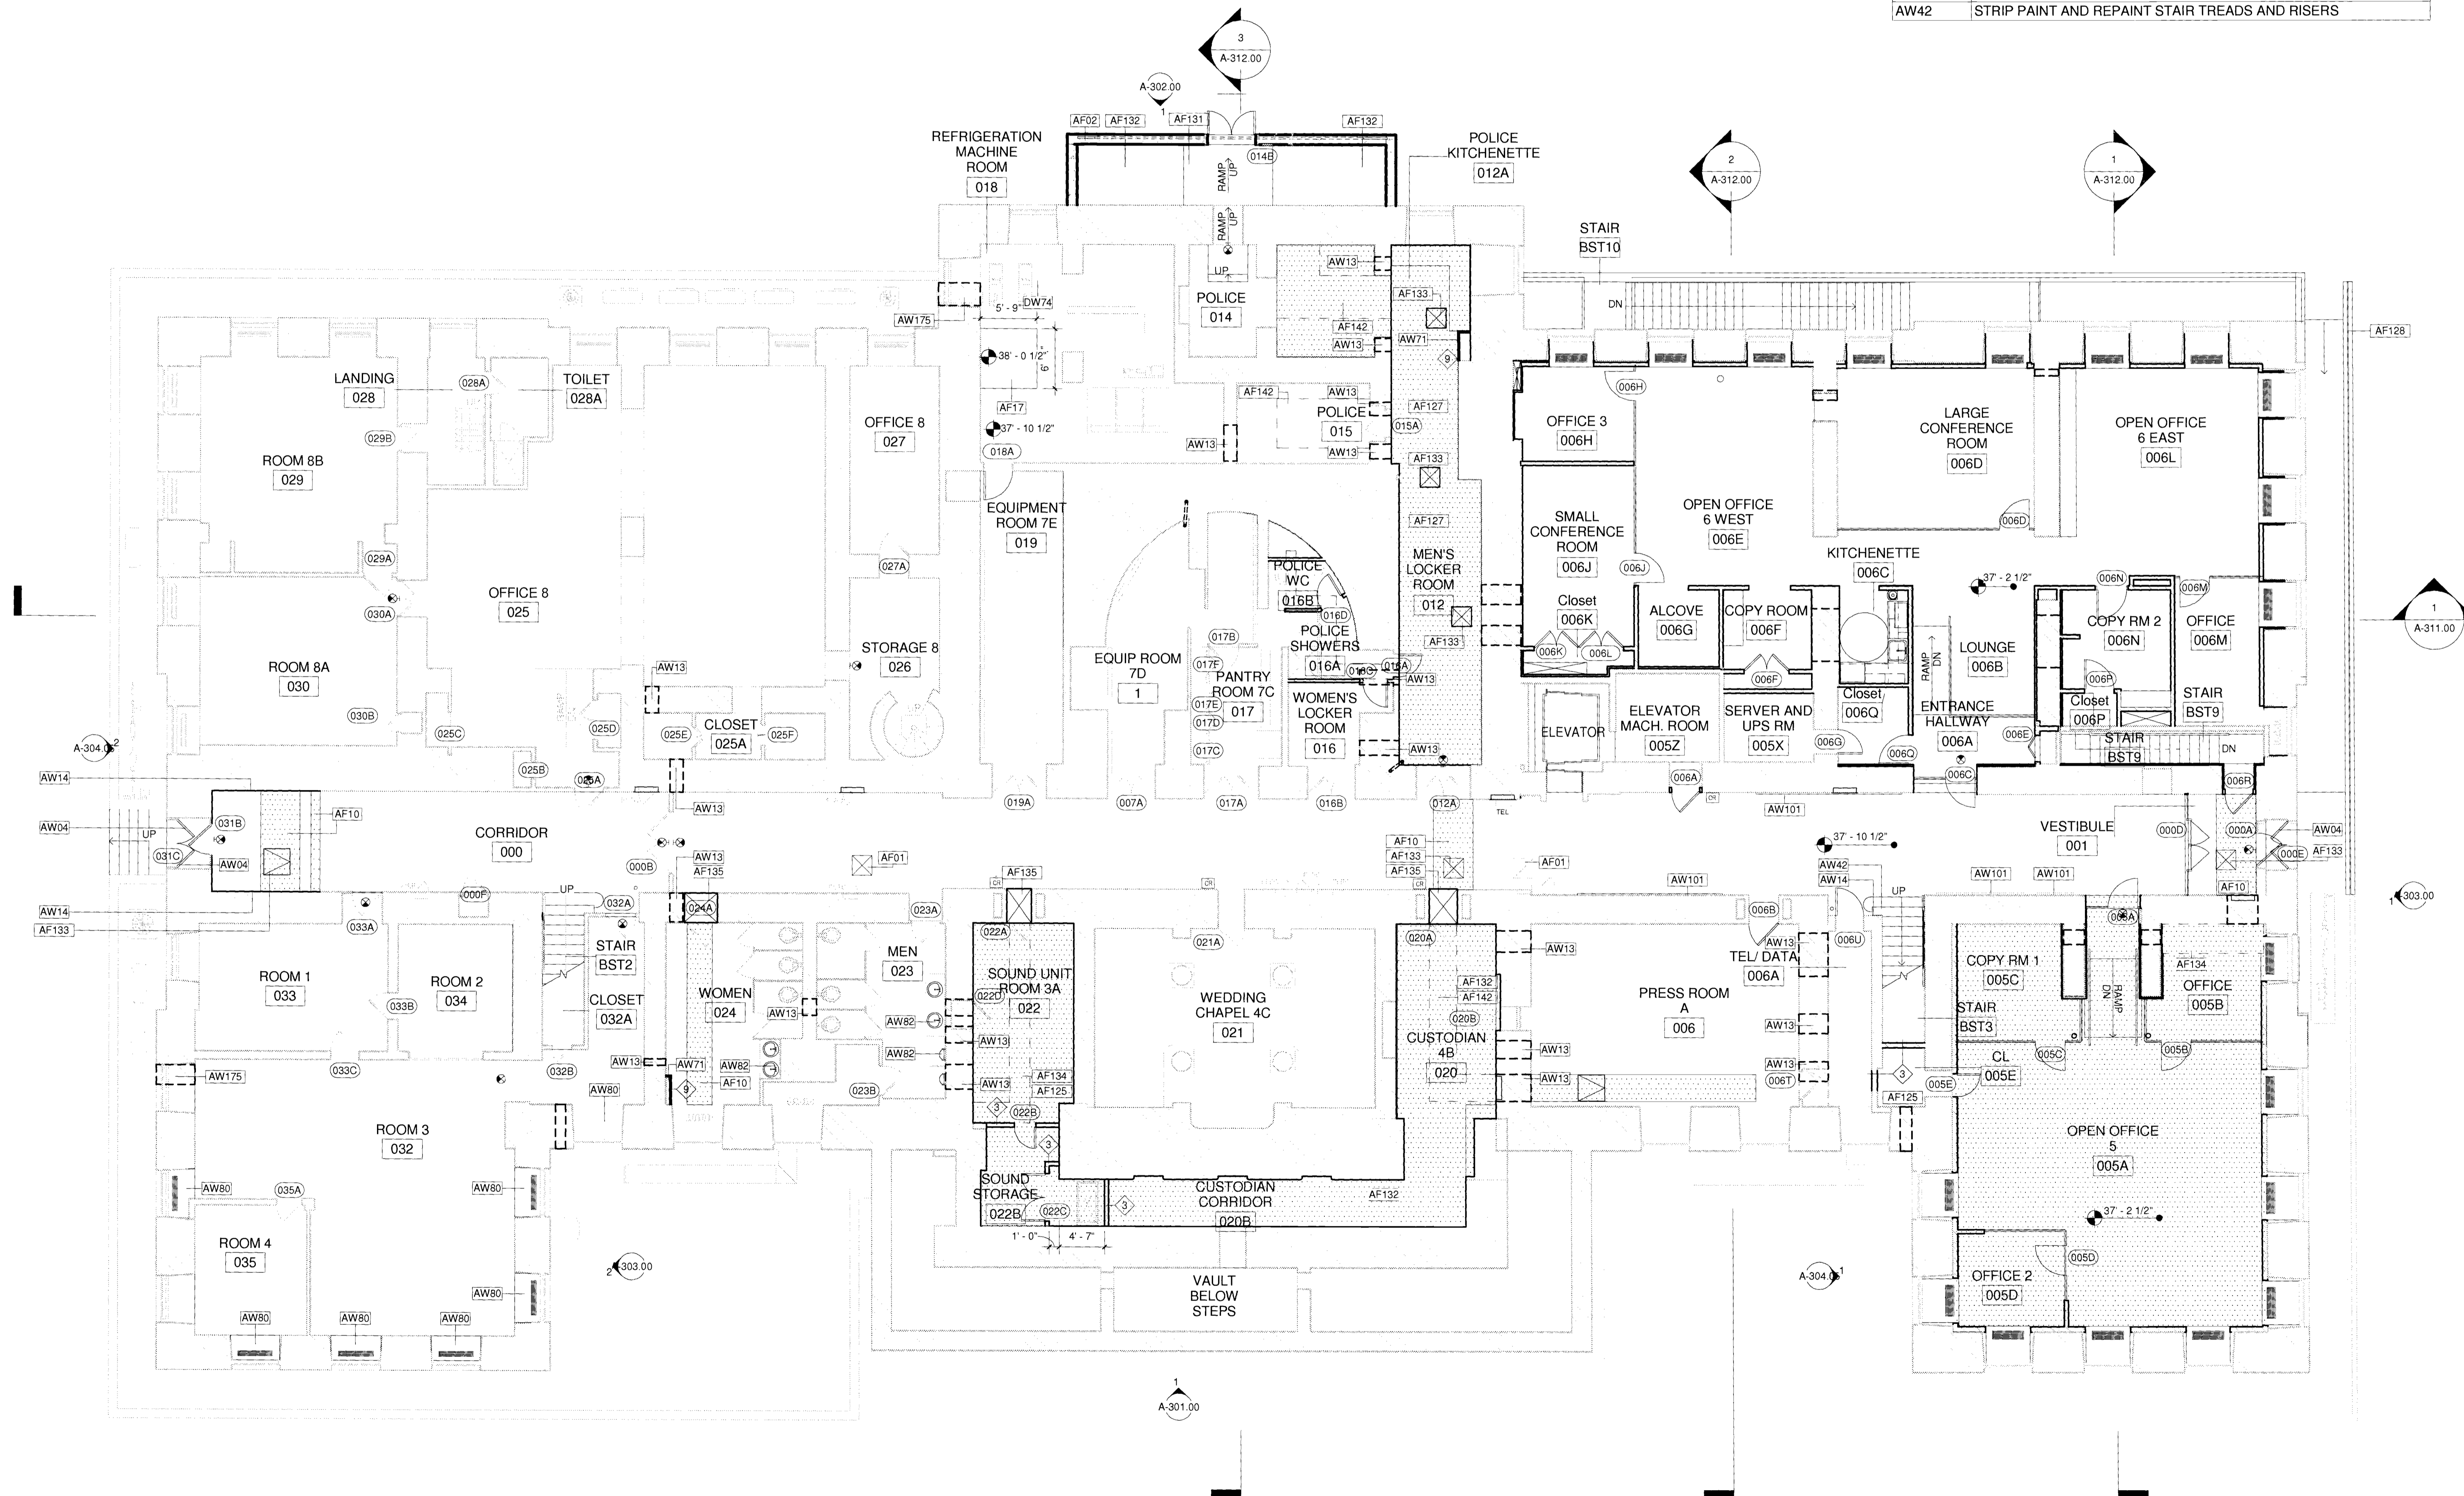
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SHEET NUMBER:
 10 OF 42

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KEYNOTE LEGEND	
AW71	PROVIDE OPENING IN FLOOR ABOVE OR BELOW AS REQUIRED FOR PIPING. COORDINATE SIZE OF CHASE AND OPENING WITH HVAC, ELECTRICAL AND/OR PLUMBING CONTRACTORS. PROVIDE FIRESTOPPING AT FLOOR SLABS AND WALLS.
AW80	DISASSEMBLE, SALVAGE & REINSTALL EXG FAN COIL ENCLOSURE. MODIFY EXG FRAMING AT NEW FAN COIL OR PIPING LOCATIONS. PAINT PREVIOUSLY PAINTED PORTIONS & PROVIDE 2" FOIL FACED INSULATION (INS-02) AT BACK INSIDE BACK OF ENCLOSURE. PROVIDE 1" FOIL FACED INSULATION (INS-02A) AT SIDES OF ENCLOSURE. SEE HVAC DWGS FOR REPLACEMENT OF FAN COIL UNIT.
AW82	PLUMBING CONTRACTOR TO PROVIDE HIGH EFFICIENCY PLUMBING FIXTURES (TYP). SEE PLUMBING DRAWING
AW101	EXISTING HISTORIC WALL PLAQUE. PROTECT DURING CONSTRUCTION
AW175	PROVIDE DRAINABLE LOUVER BELOW WINDOW IN AREAWAY UNDER GRATING.
DW74	CAREFULLY DISASSEMBLE & SALVAGE EXISTING WOOD PANELING FOR REUSE. PROVIDE NEW OPENING FOR DOOR

KEYNOTE LEGEND	
AF01	EXISTING FLOOR HATCH TO REMAIN (TYP)
AF02	CONCRETE WALL FOR STAIR RECONSTRUCTION
AF10	PATCH FLOOR WITH TILES TO MATCH EXISTING ADJACENT TILES
AF17	6" CONCRETE PAD. COORDINATE LOCATION WITH MECH / ELEC / PLUM CONTRACTOR
AF28	PROVIDE GLAZED DOOR ASSEMBLY
AF125	PROVIDE CONCRETE SLAB ON GRADE UNDER RAISED FLOOR. SEE STRUCTURAL DWG FOR SLAB DETAILS.
AF127	PROVIDE NEW CONCRETE FLOOR SLAB. SEE STRUCTURAL DRAWINGS.
AF128	REINSTALL EXISTING STEEL PICKET RAILING
AF131	EXISTING RAMP TO REMAIN
AF132	CONCRETE SLAB ON GRADE. SEE DETAILS AND STRUCTURAL DRAWINGS
AF133	PROVIDE FLOOR HATCH. CONFIRM LOCATION WITH MEP CONTRACTORS.
AF134	TRENCH IN CONCRETE SLAB BELOW RAISED FLOOR
AF135	PROVIDE NEW ACCESS HATCH. REFER TO STRUCTURAL DRAWINGS FOR DETAIL OF OPENING IN WALL BELOW.
AF142	FLOOR TRENCH BELOW CONCRETE SLAB. REFER TO MEP DRAWINGS FOR DETAILS. COORDINATE FINAL SIZE WITH MEP SUB CONTRACTORS PRIOR TO POURING CONCRETE.
AW04	EXISTING STEEL PICKET GATE TO REMAIN
AW13	WALL OPENING ABOVE
AW14	PATCH AND PAINT WALLS AFTER REMOVAL OF OTHER WORK.
AW42	STRIP PAINT AND REPAINT STAIR TREADS AND RISERS



1
 A-101.00
 Basement Floor
 1/8" = 1'-0"
 0' 2' 4' 8' 16'
 SCALE: 1/8" = 1'-0"

SEAL
[Signature]

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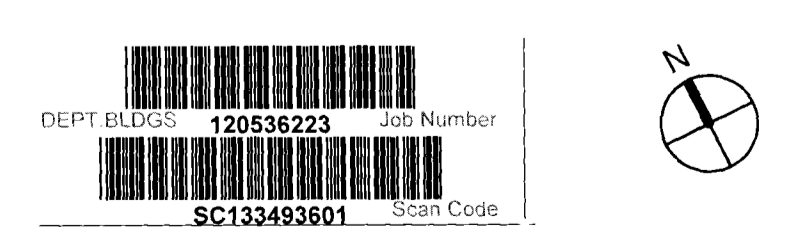
NEW YORK CITY DEPARTMENT OF DESIGN + CONSTRUCTION
 DIVISION OF STRUCTURES
 BUREAU OF ARCHITECTURE & ENGINEERING
 CAPITAL PROJECT NUMBER:
 CITYHALL2
 PROJECT NAME:
 Renovation of City Hall
 Bid Package 2

FOR THE:
 DRAWING TITLE:
Basement Floor Plan

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A-101.00


SHEET NUMBER:
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DOB PERMIT APPLICATION

KEYNOTE LEGEND	
AW71	PROVIDE OPENING IN FLOOR ABOVE OR BELOW AS REQUIRED FOR PIPING. COORDINATE SIZE OF CHASE AND OPENING WITH HVAC, ELECTRICAL AND/OR PLUMBING CONTRACTORS. PROVIDE FIRESTOPPING AT FLOOR SLABS AND WALLS.
AW99	CLOSE DOOR AND SECURE PERMANENTLY IN CLOSED POSITION.

KEYNOTE LEGEND	
AF19	REINSTALL EXISTING SUBFLOOR, WOOD FLOORING AND SUPPORTING STRUCTURE.
AF36	AT THE CONCLUSION OF PIPING INSTALLATION REINSTALL EXISTING STONE UNITS IN THEIR ORIGINAL LOCATION.
AF129	INFILL OPENING IN FLOOR WITH WOOD JOISTS AND PLYWOOD SHEATHING. SEE STRUCTURAL DWGS. REINSTALL WOOD FLOORING. MATCH EXISTING ADJACENT WOOD SPECIES. REFINISH FLOOR IN ENTIRE ROOM.
AF130	INSTALL NEW WOOD FLOORING TO MATCH EXISTING ADJACENT SPECIES. REFINISH FLOOR IN ENTIRE ROOM.
AF136	PROVIDE OPENING IN FLOOR FOR MEP PIPING AND DUCTS - REFER TO MEP AND STRUCTURAL DRAWINGS.
AF140	RETURN AIR FLOOR GRILLE, SEE MECHANICAL DRAWINGS FOR DETAILS.
AF143	INSTALL PLYWOOD OVER SUBFLOORING TO LEVEL THE FLOOR. EXISTING WOOD PLANKS TO BE REFINISHED THROUGHOUT ENTIRE ROOM.
AW13	WALL OPENING ABOVE
AW14	PATCH AND PAINT WALLS AFTER REMOVAL OF OTHER WORK.
AW48	RESTORE WALL OPENINGS WITH PLASTER ON METAL LATH



1 First Floor
A-102.00 1/8" = 1'-0"
0' 2' 4' 8' 16'
SCALE: 1/8" = 1'-0"

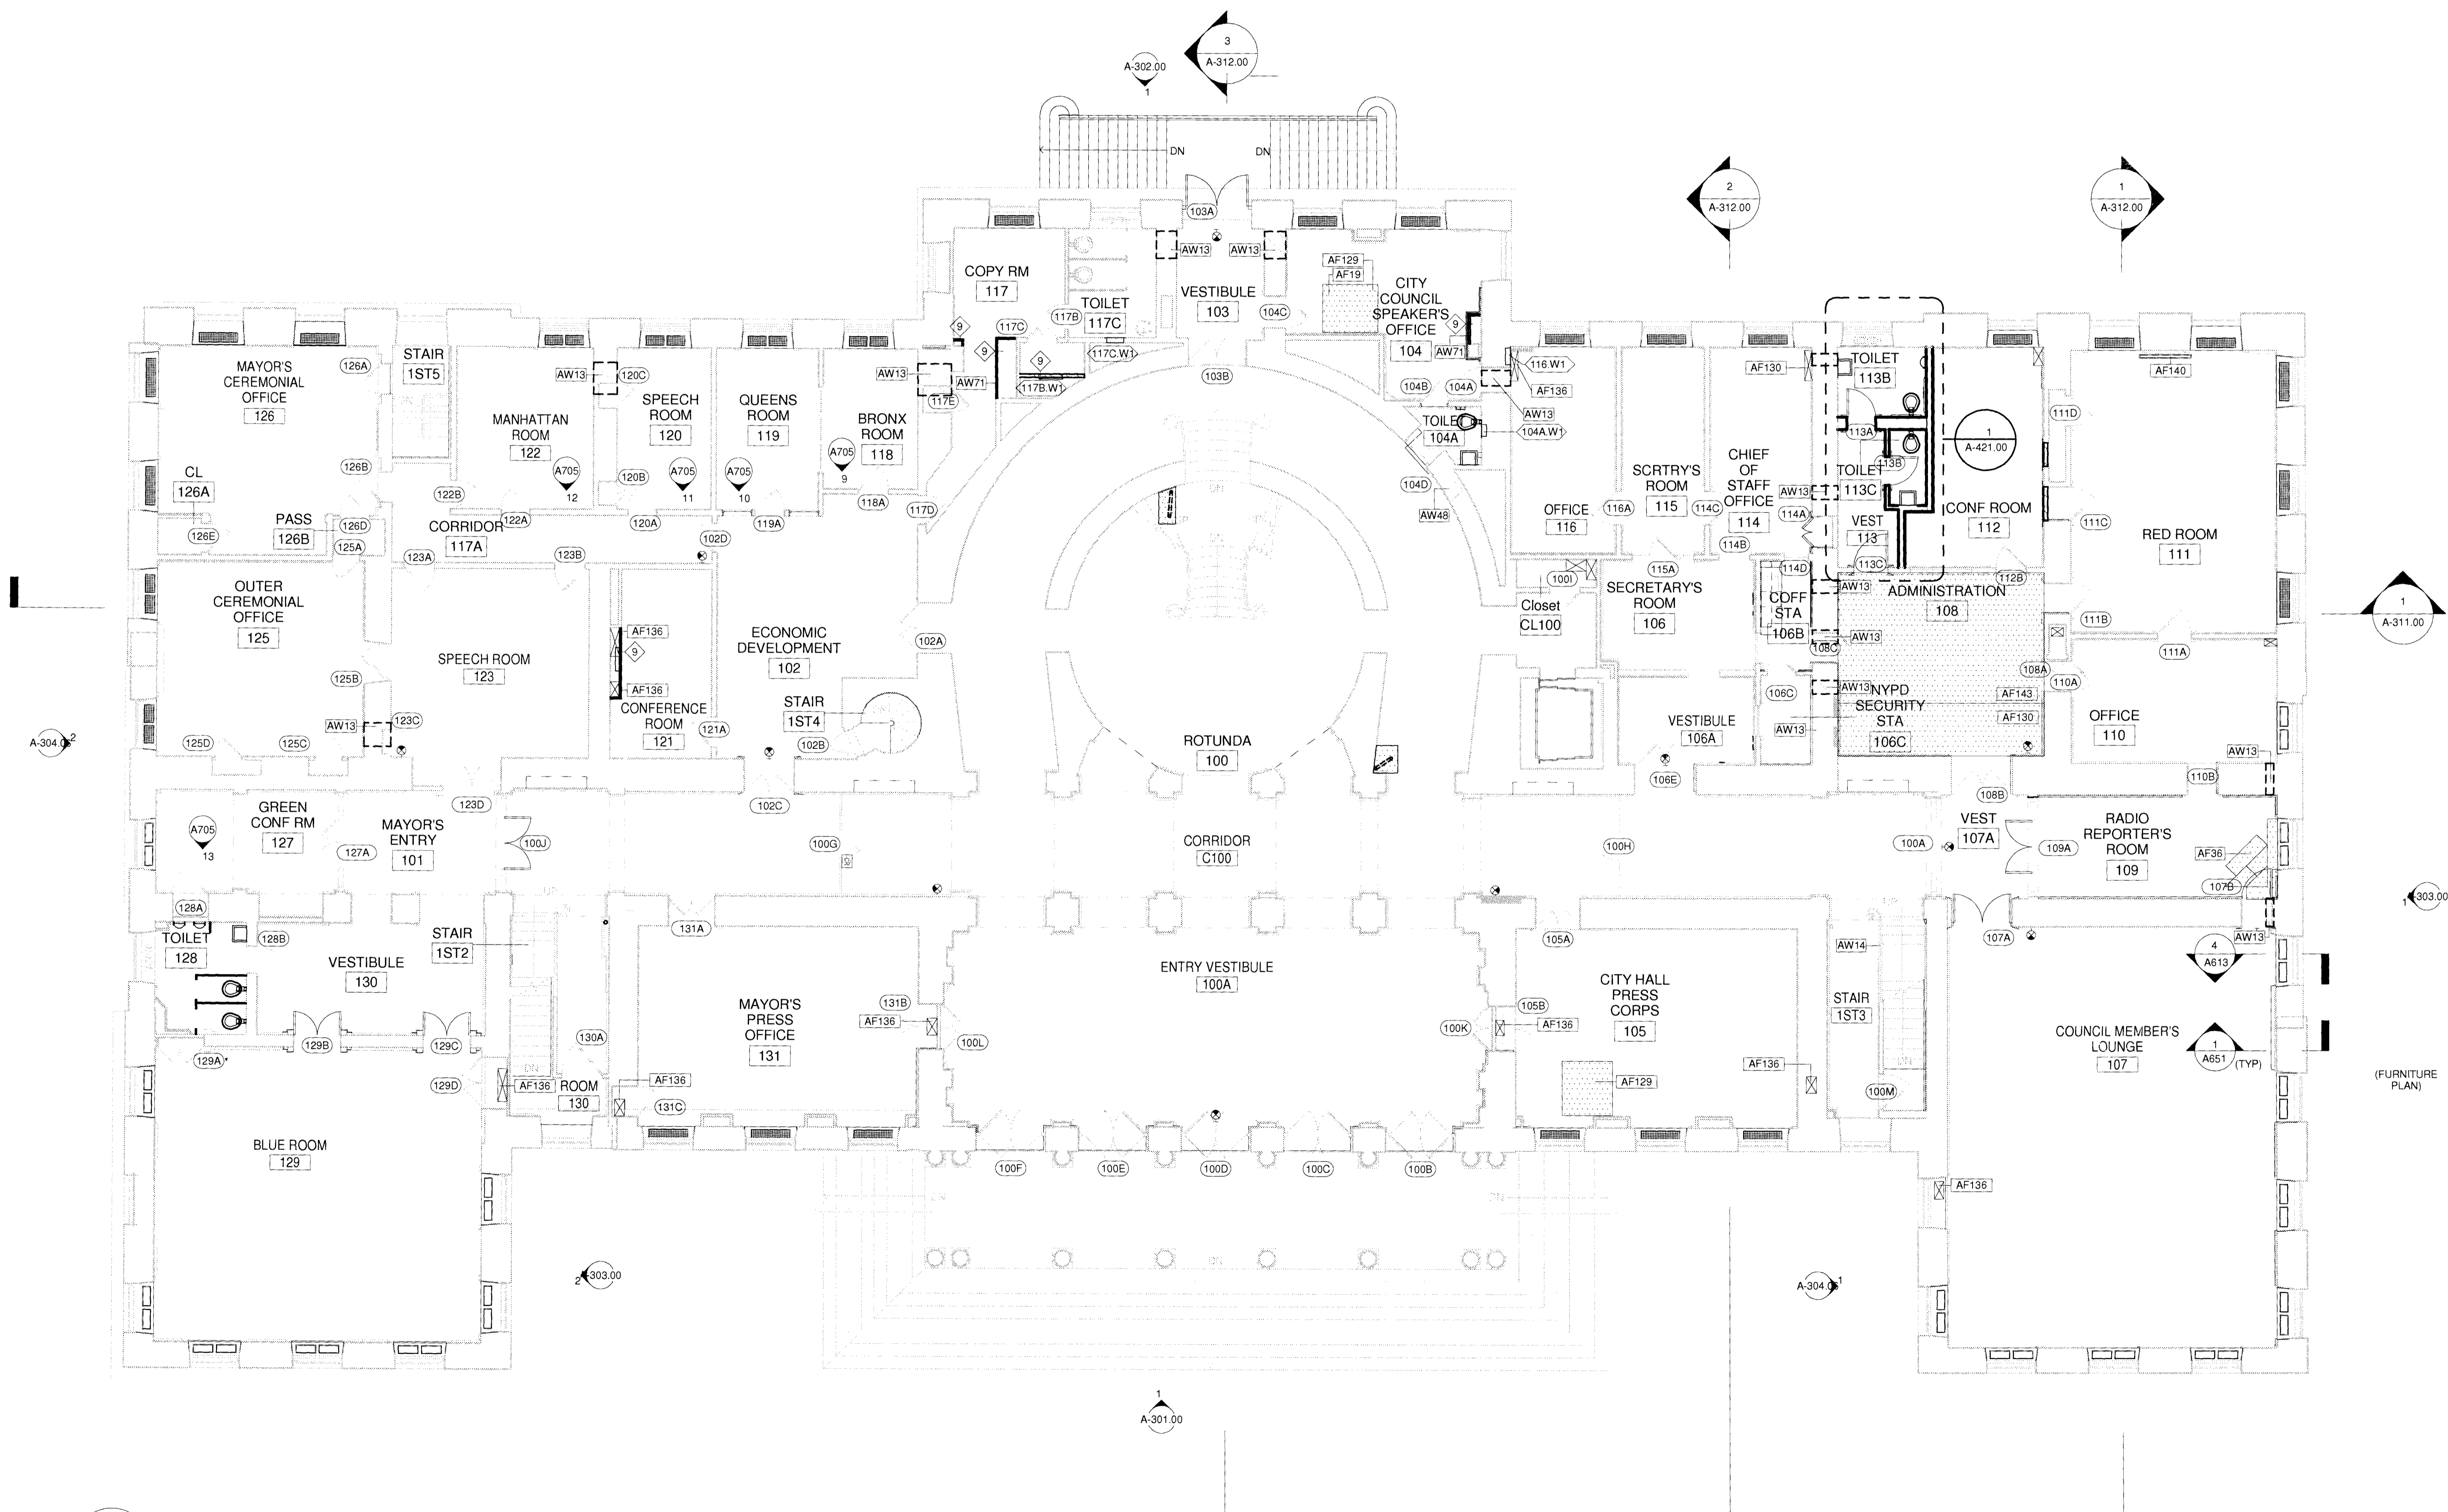SEAL:
[Signature]

REVISIONS:

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NEW YORK CITY DEPARTMENT OF DESIGN + CONSTRUCTION
DIVISION OF STRUCTURES
BUREAU OF ARCHITECTURE & ENGINEERING
CAPITAL PROJECT NUMBER:
CITYHALL2
PROJECT NAME:
Renovation of City Hall
Bid Package 2

FOR THE:

DRAWING TITLE:
First Floor Plan

DRAWN BY: TB SCALE: 1/8" = 1'-0"
CHECKED BY: NA DATE: 10.08.10

DRAWING NUMBER:
A-102.00

SHEET NUMBER:
12 OF 42

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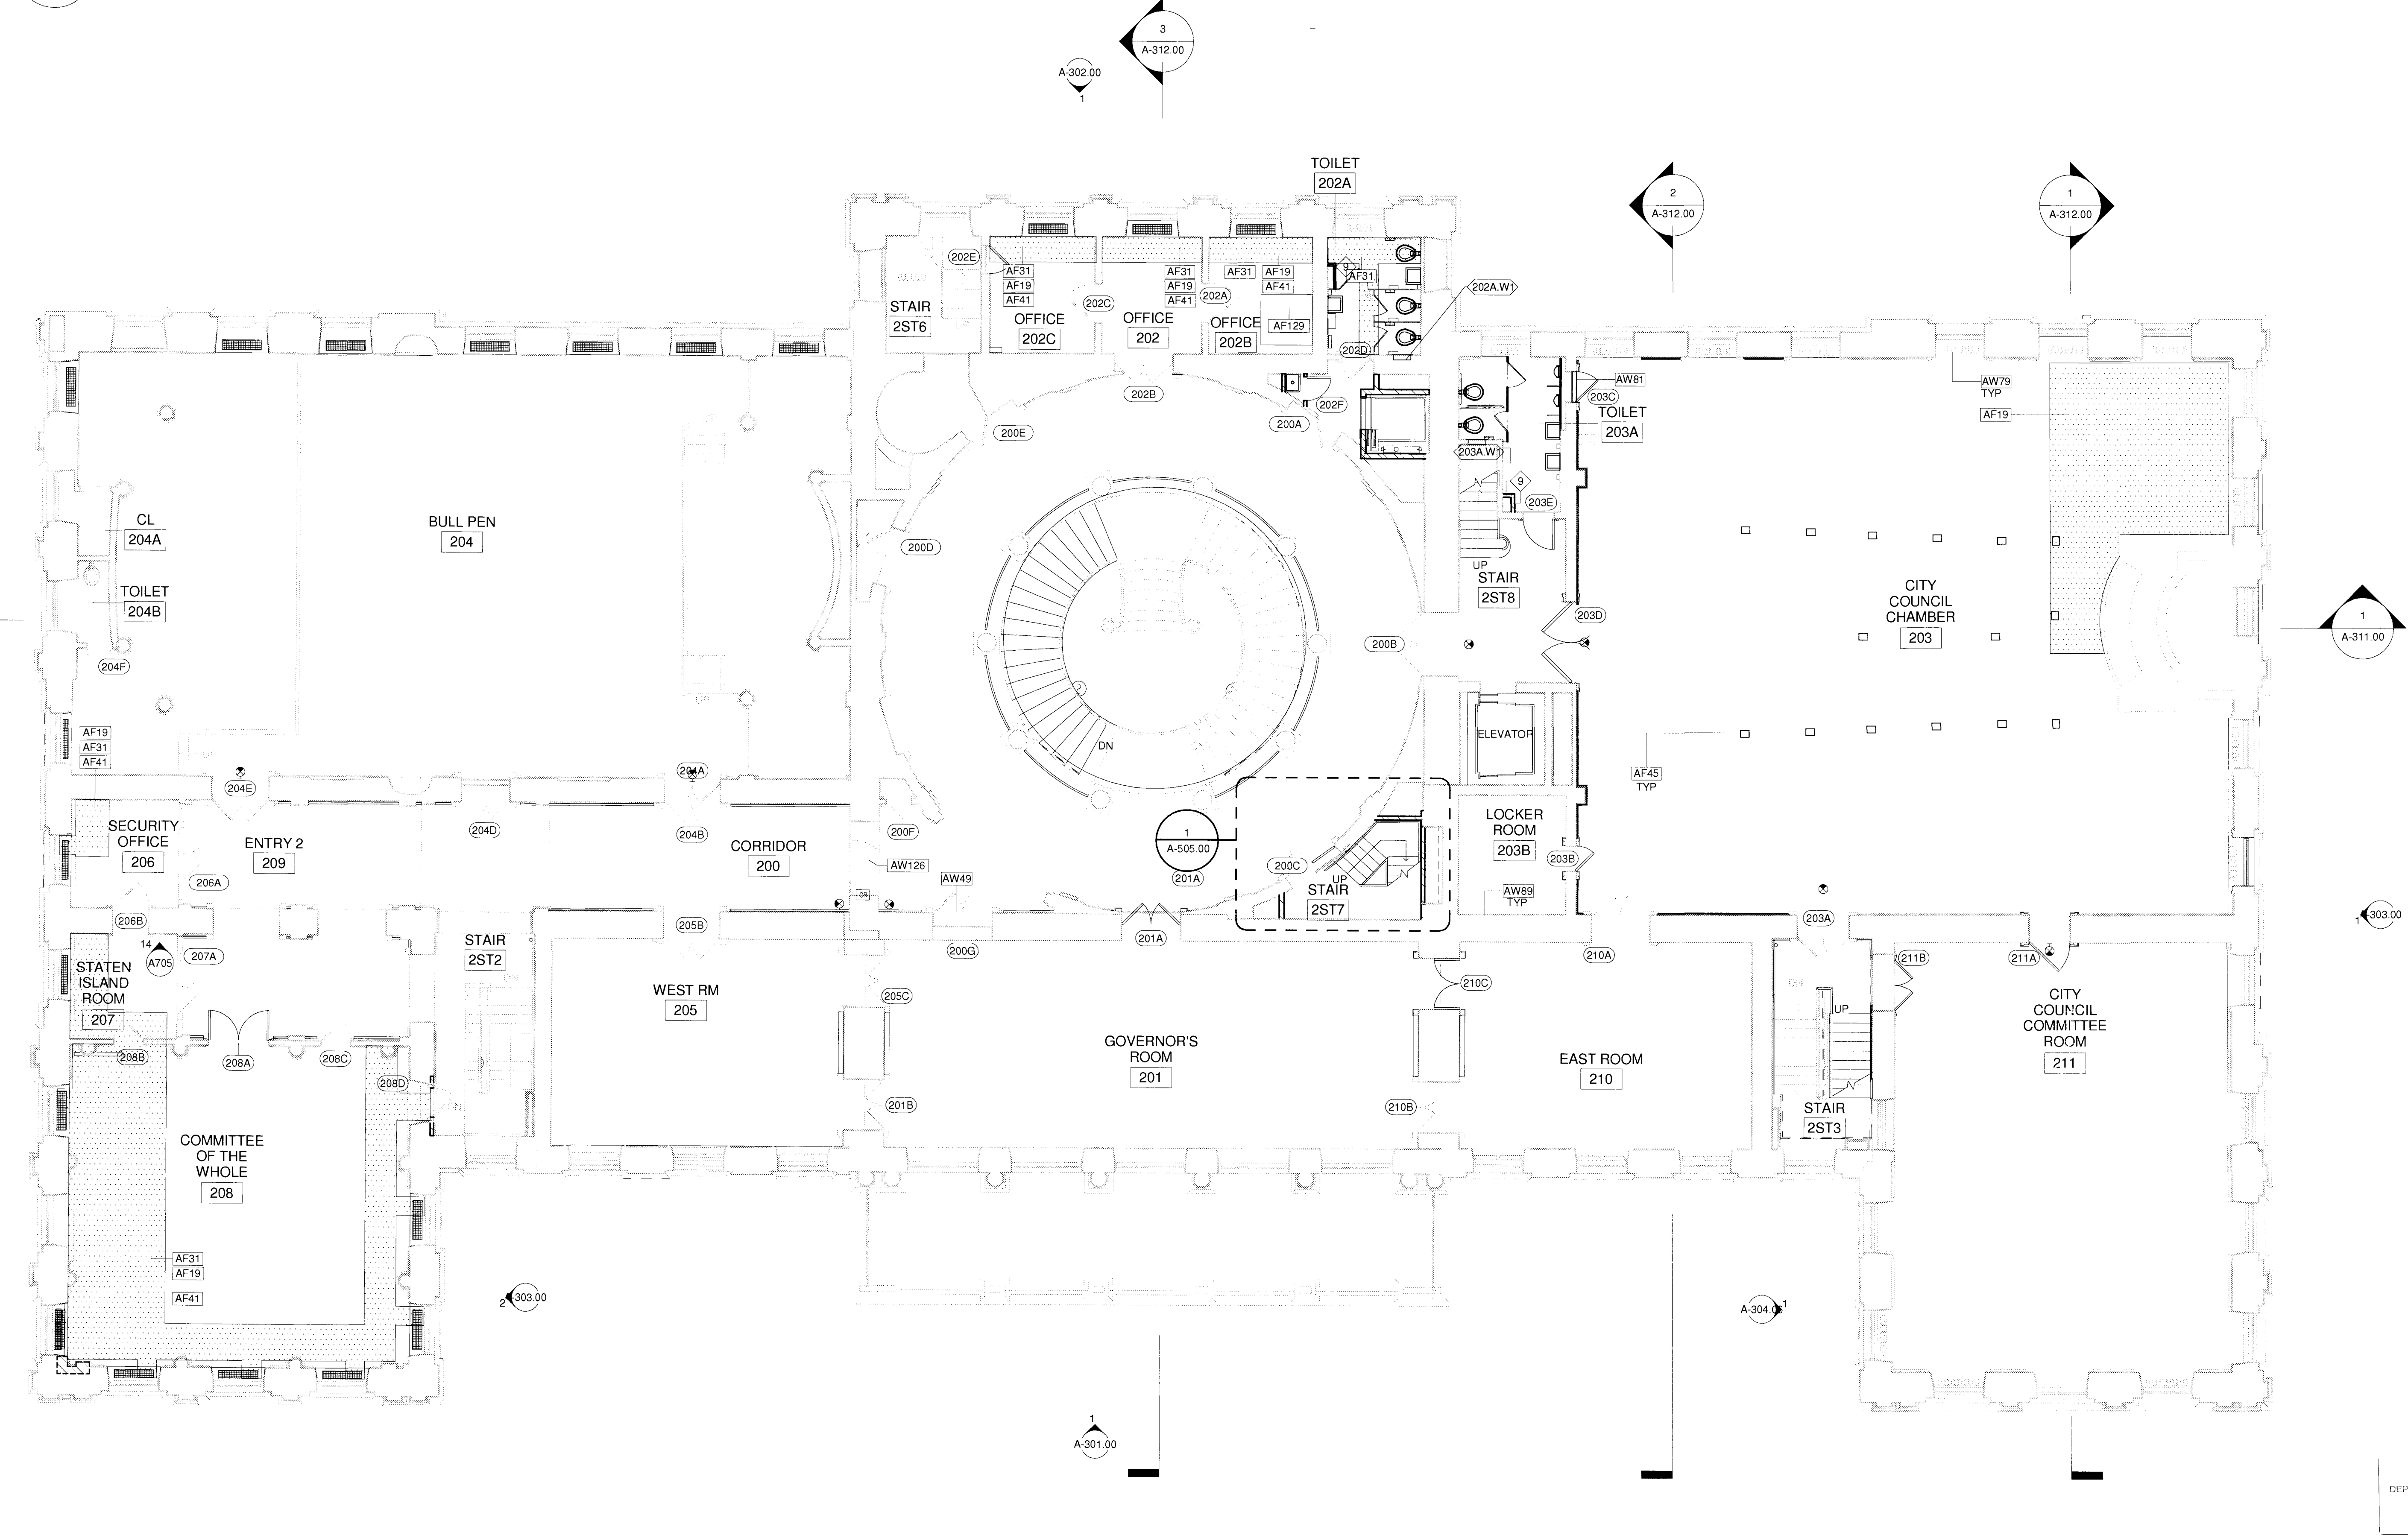
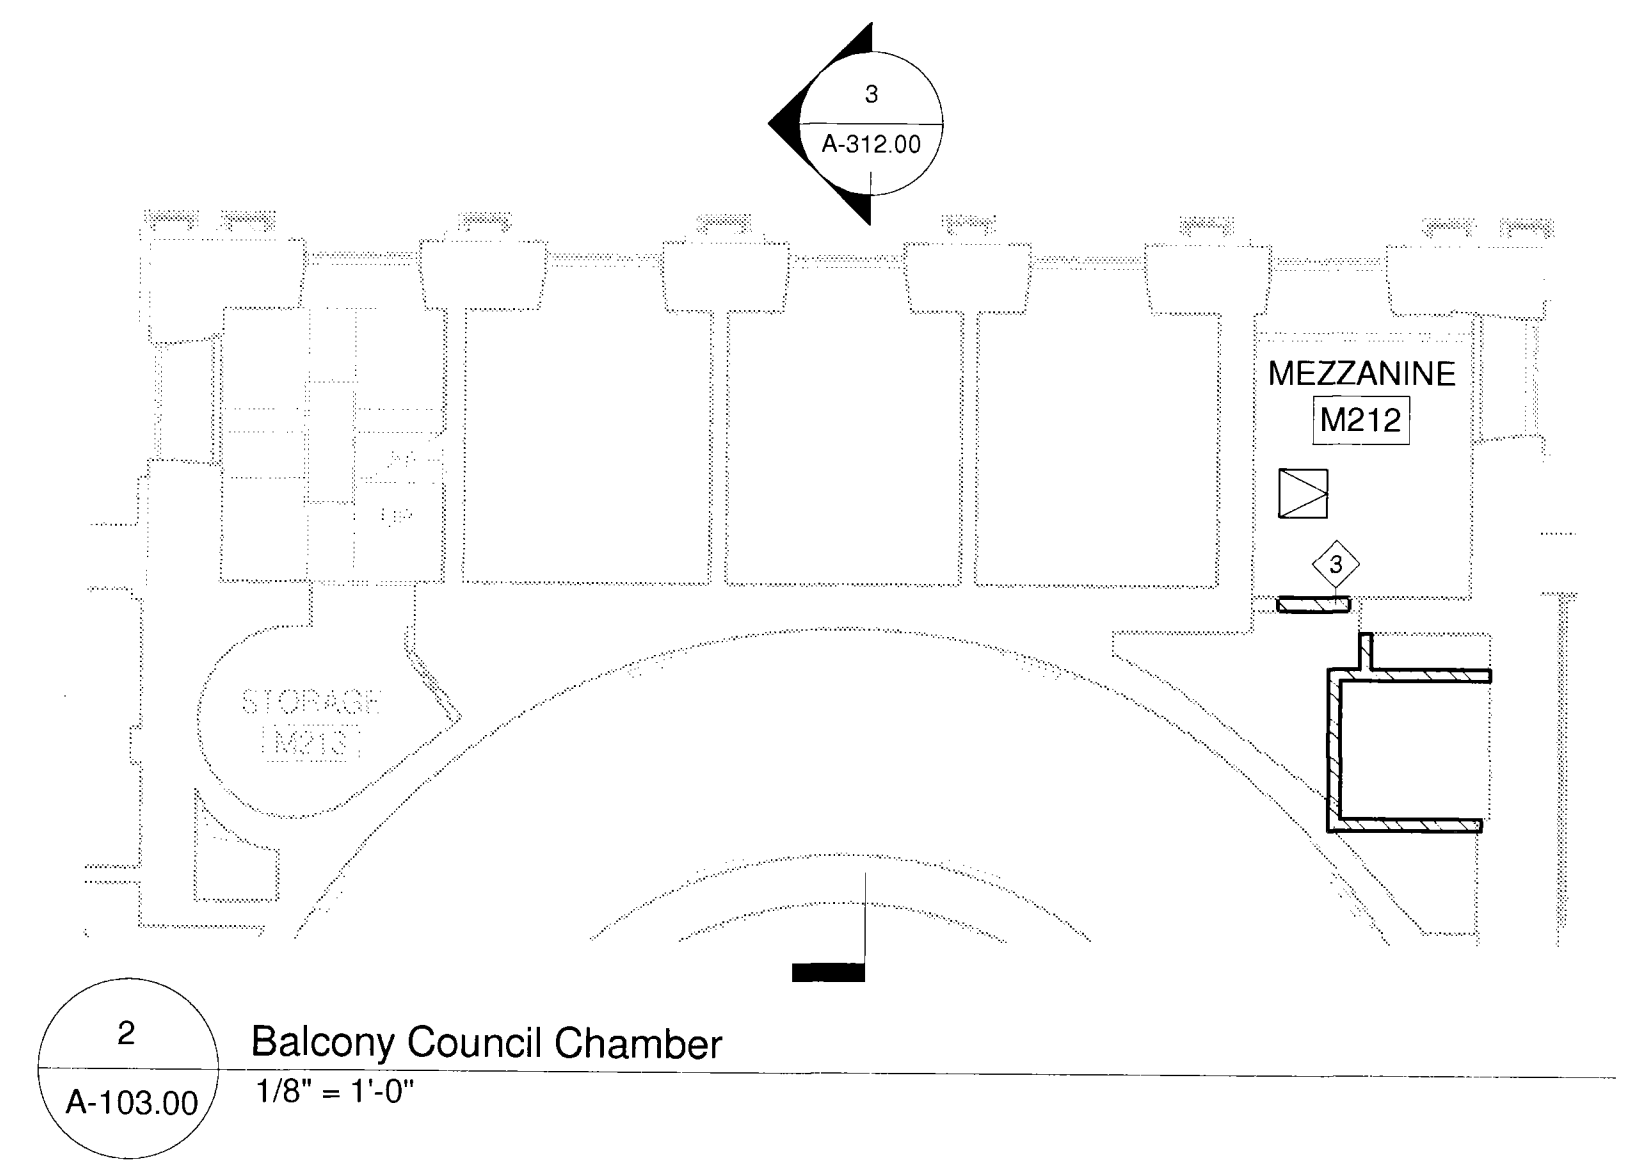
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DEPT. OF BUILDINGS

120536223

SC133403598

KEYNOTE LEGEND	
AF19	REINSTALL EXISTING SUBFLOOR, WOOD FLOORING AND SUPPORTING STRUCTURE.
AF31	MODIFY FLOOR FRAMING FOR NEW PIPING. NEW FRAMING SHALL ACCOMMODATE ALL PIPES AND CONDUITS AND ALLOW 1/8" PER FT SLOPE FOR CONDENSATE DRAIN PIPING. COORDINATE SIZE OF PIPING AND CONDUITS WITH THE HVAC AND ELECTRICAL CONTRACTORS. REFER TO STRUCTURAL DRAWINGS FOR JOIST MODIFICATION TO ACCOMMODATE PIPES
AF41	STRIP, SAND AND REFINISH EXISTING WOOD FLOOR.
AF45	EXISTING FLOOR ELECTRIC OUTLET TO REMAIN
AF129	INFILL OPENING IN FLOOR WITH WOOD JOISTS AND PLYWOOD SHEATHING. SEE STRUCTURAL DWGS. REINSTALL WOOD FLOORING. MATCH EXISTING ADJACENT WOOD SPECIES. REFINISH FLOOR IN ENTIRE ROOM.
AW49	STRIP PAINT AND REPAINT CASING WITH TWO BASE COATS AND A FINISH COAT. SEE DOOR SCHEDULE FOR WORK AT DOOR.
AW77	EXISTING DOOR TO BE REINSTALLED WITH REVERSED SWING. SEE DOOR SCHEDULE
AW79	SALVAGE AND REINSTALL EXISTING SECURITY CAMERA
AW81	WOOD DOOR TO BE FIXED IN PLACE. PROVIDE BLANK OFF PANEL BEHIND GRILLE
AW89	ELECTRIC PANELS
AW126	STRIP, PRIME AND PAINT EXISTING WOOD GATE AND RAILING



1 Second Floor
 A-103.00
 1/8" = 1'-0"

0' 2' 4' 8' 16'
 SCALE: 1/8" = 1'-0"

SEAL:

REVISIONS:

NUMBER	DESCRIPTION	DATE



DIVISION OF STRUCTURES
 BUREAU OF ARCHITECTURE & ENGINEERING

CAPITAL PROJECT NUMBER:
 CITYHALL2

PROJECT NAME:
 Renovation of City Hall
 Bid Package 2

FOR THE:

DRAWING TITLE:
Second Floor Plan

DRAWN BY: TB	SCALE: 1/8" = 1'-0"
CHECKED BY: NA	DATE: 10.08.10
DRAWING NUMBER: A-103.00	


SHEET NUMBER:
 13 OF 42

NOTE:
 FOR FLOOR RESTORATION NOTES SEE ENLARGED FLOOR PLAN A405



DOB PERMIT APPLICATION

KEYNOTE LEGEND	
AC66	NEW DUCT TO TIE INTO EXISTING. SEE MECH DWGS
AF01	EXISTING FLOOR HATCH TO REMAIN (TYP)
AF03	LINE OF WALL AT CRAWL SPACE BELOW
AF05	INFILL EXISTING OPENING IN GRATING WITH NEW GRATING. REFER TO STRUCTURAL DRAWINGS FOR DETAILS.
AF11	STEEL GRATING. SEE STRUCTURAL DRAWINGS
AF20	EXISTING METAL GRATING
AF31	MODIFY FLOOR FRAMING FOR NEW PIPING. NEW FRAMING SHALL ACCOMMODATE ALL PIPES AND CONDUITS AND ALLOW 1/8" PER FT SLOPE FOR CONDENSATE DRAIN PIPING. COORDINATE SIZE OF PIPING AND CONDUITS WITH THE HVAC AND ELECTRICAL CONTRACTORS. REFER TO STRUCTURAL DRAWINGS FOR JOIST MODIFICATION TO ACCOMMODATE PIPES
AF32	AT THE CONCLUSION OF PIPING INSTALLATION THE SAME CONTRACTOR THAT REMOVED THE FLOORING SHALL REINSTALL THE FLOORING TO ITS ORIGINAL LOCATION. STRIP, SAND AND REFINISH THE ENTIRE FLOOR IN THE ROOM.
AF38	EXISTING SKYLIGHTS ABOVE TO REMAIN
AF138	LOCATION OF EXISTING RELOCATED FREESTANDING CORNER CABINET
AF141	EXISTING WOOD STAIR TO BE RELOCATED AFTER INSTALLATION OF NEW MECHANICAL EQUIPMENT.
AF145	IN ALL ATTIC SPACES (INCLUDING EAST AND WEST ATTICS AS WELL AS ATTIC ABOVE DESIGN COMMISSION AND ROTUNDA SPACES) INSTALL INSULATION AT FLOOR FRAMING TO CREATE AS CONTINUOUS INSULATIVE LAYER AS POSSIBLE, RUNNING INSULATION BELOW GRATING, BETWEEN JOISTS, ETC.
AW12	EXISTING DUCTWORK TO REMAIN - REFER TO MECHANICAL DRAWINGS

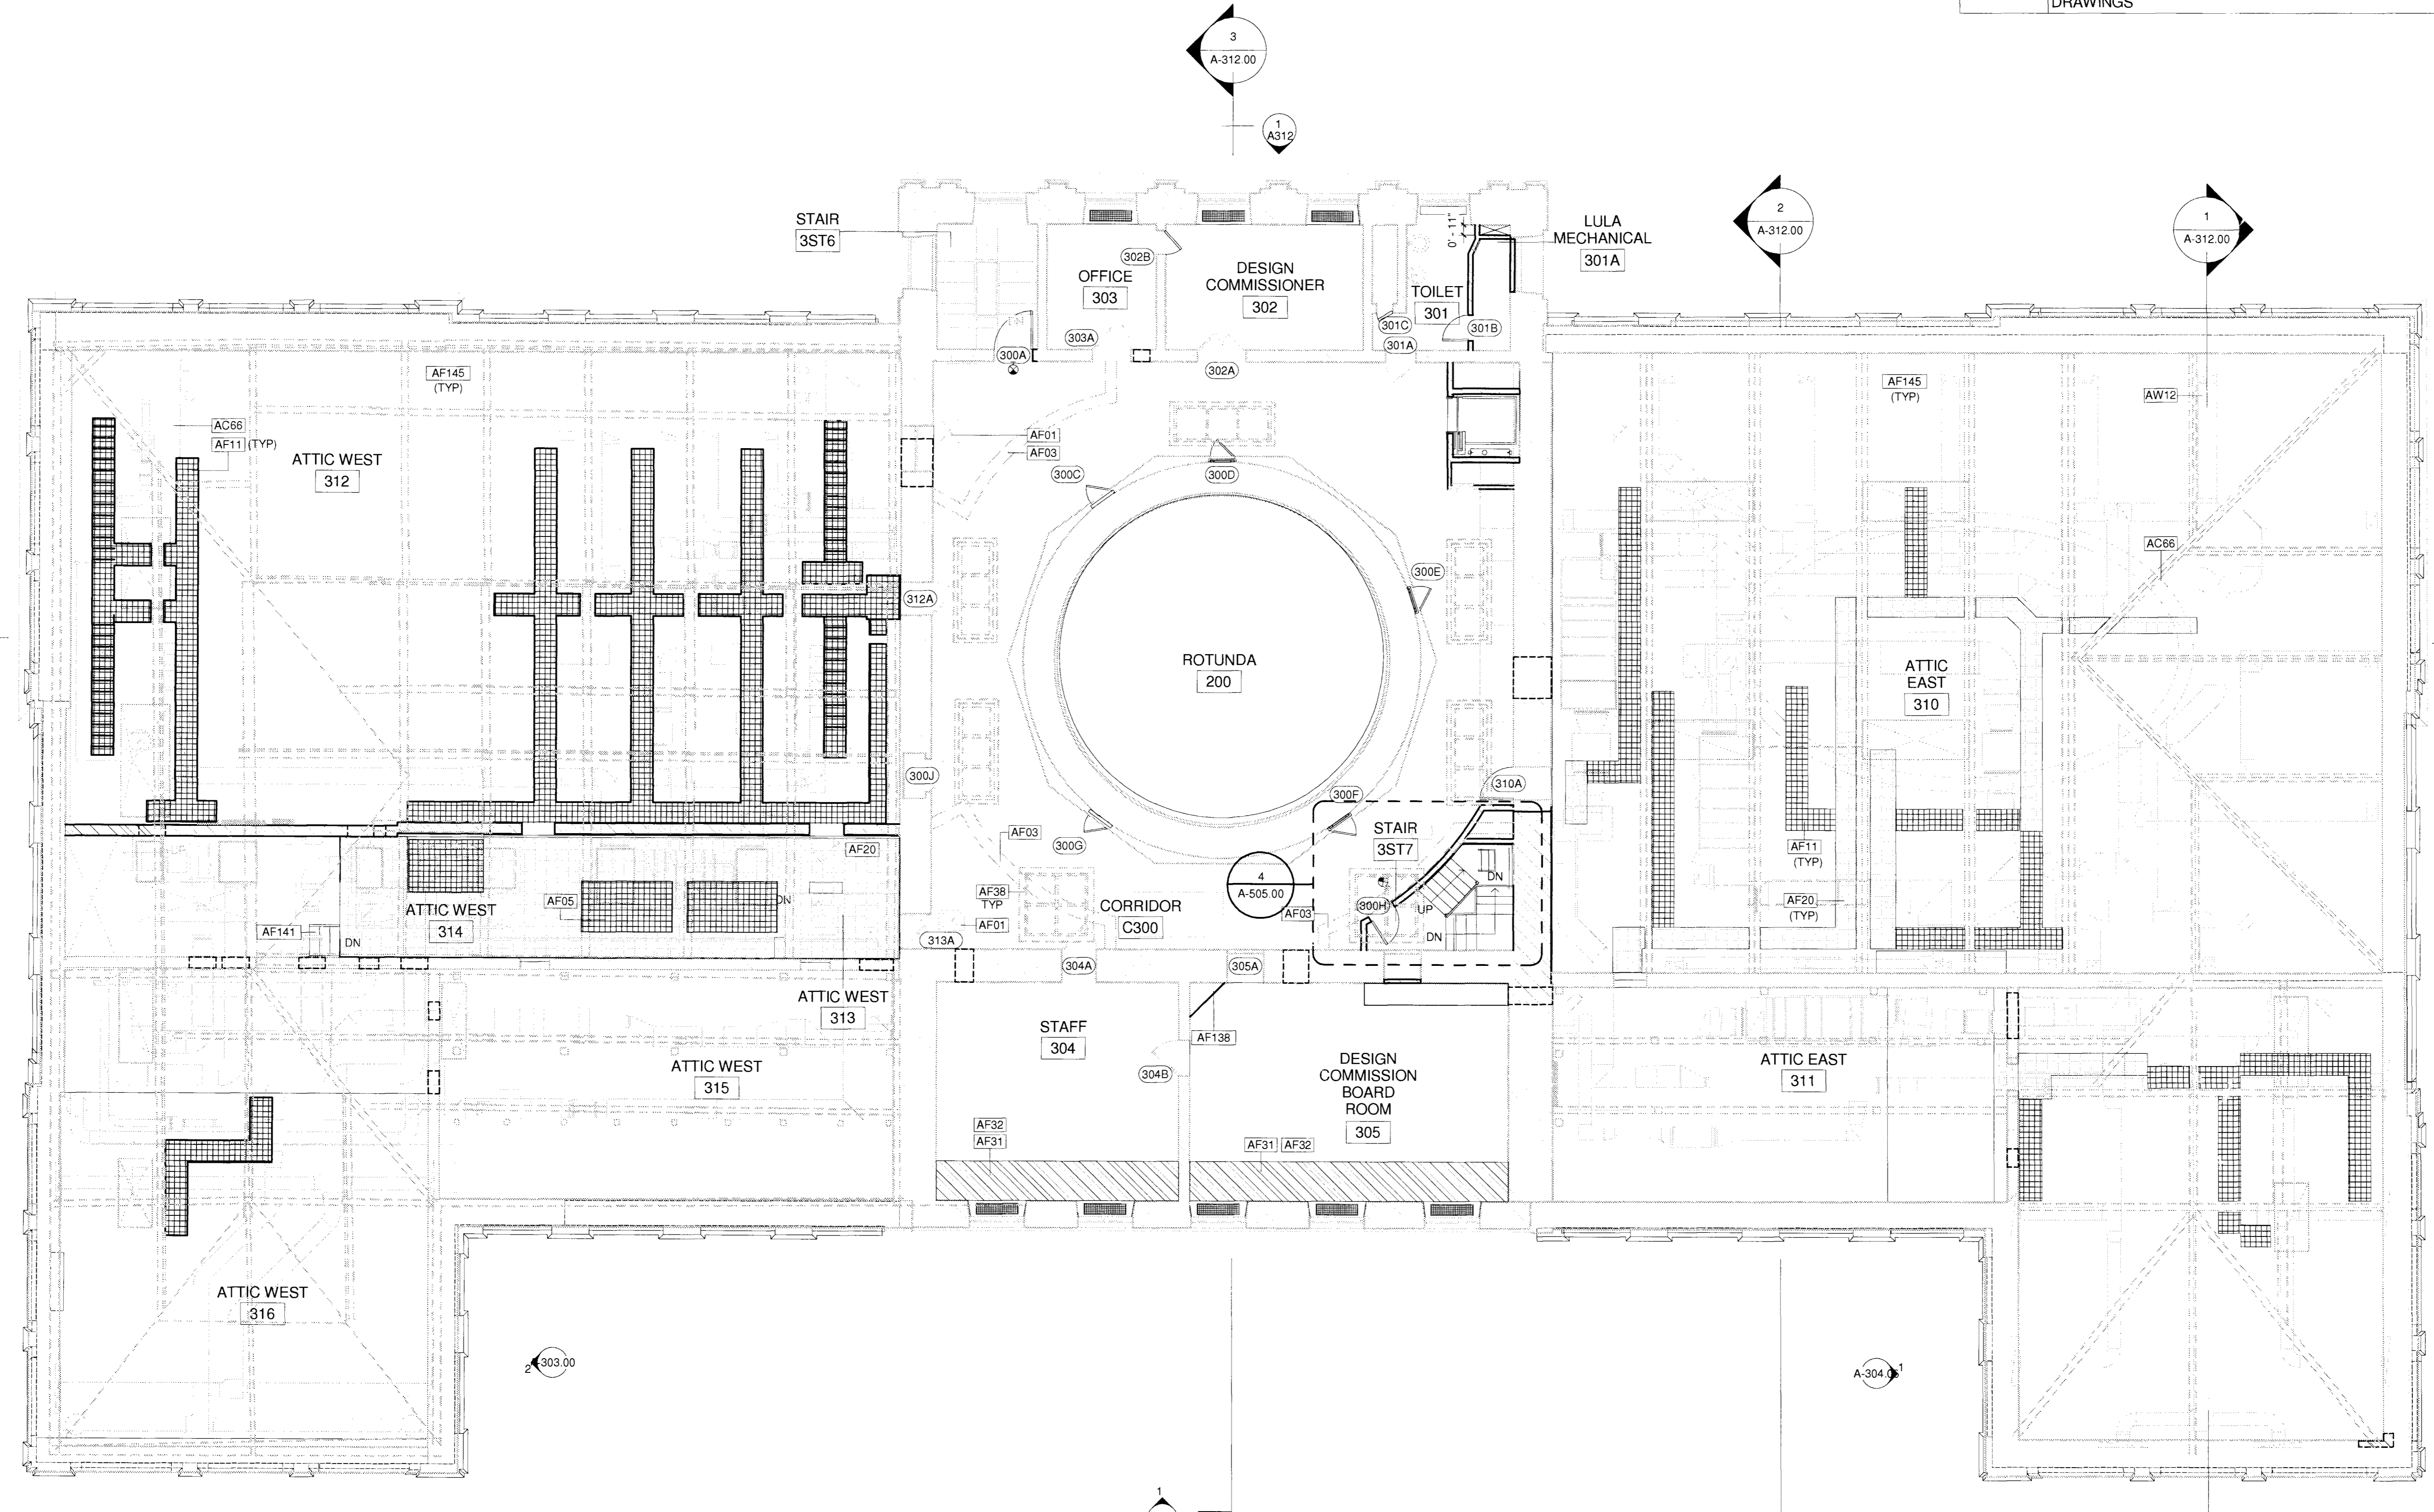

1 Third Floor
 A-104.00
 1/8" = 1'-0"
 0' 2' 4' 8' 16'
 SCALE: 1/8" = 1'-0"

SEAL:

REVISIONS:		
NUMBER	DESCRIPTION	DATE



NEW YORK CITY DEPARTMENT OF DESIGN + CONSTRUCTION
 DIVISION OF STRUCTURES
 BUREAU OF ARCHITECTURE & ENGINEERING
 CAPITAL PROJECT NUMBER
 CITYHALL2
 PROJECT NAME
 Renovation of City Hall
 Bid Package 2

FOR THE:
 DRAWING TITLE:
Third Floor Plan

DRAWN BY: TB SCALE: 1/8" = 1'-0"
 CHECKED BY: NA DATE: 10.08.10


DRAWING NUMBER:
A-104.00

SHEET NUMBER:
 14 OF 42



DOB PERMIT APPLICATION

KEYNOTE LEGEND	
AF47	EXISTING LEAD COATED COPPER ROOF
AW178	EXISTING GRANITE BASE
AW179	EXISTING STONE FACADE
AW180	EXISTING WINDOW, TYP.
AW181	LINE OF AREAWAY BELOW
AW182	LOUVER BELOW WINDOW, REFER TO MECHANICAL AND STRUCTURAL DRAWINGS FOR ADDITIONAL INFORMATION.
DF48	PROVIDE ROOF OPENING FOR NEW ACCESS HATCH LOCATION
DW40	EXISTING MEP EQUIPMENT TO BE REMOVED: REFER TO MEP DEMOLITION DRAWINGS, TYPICAL.
DW76	REMOVE EXISTING WINDOW A/C UNIT, TYPICAL.

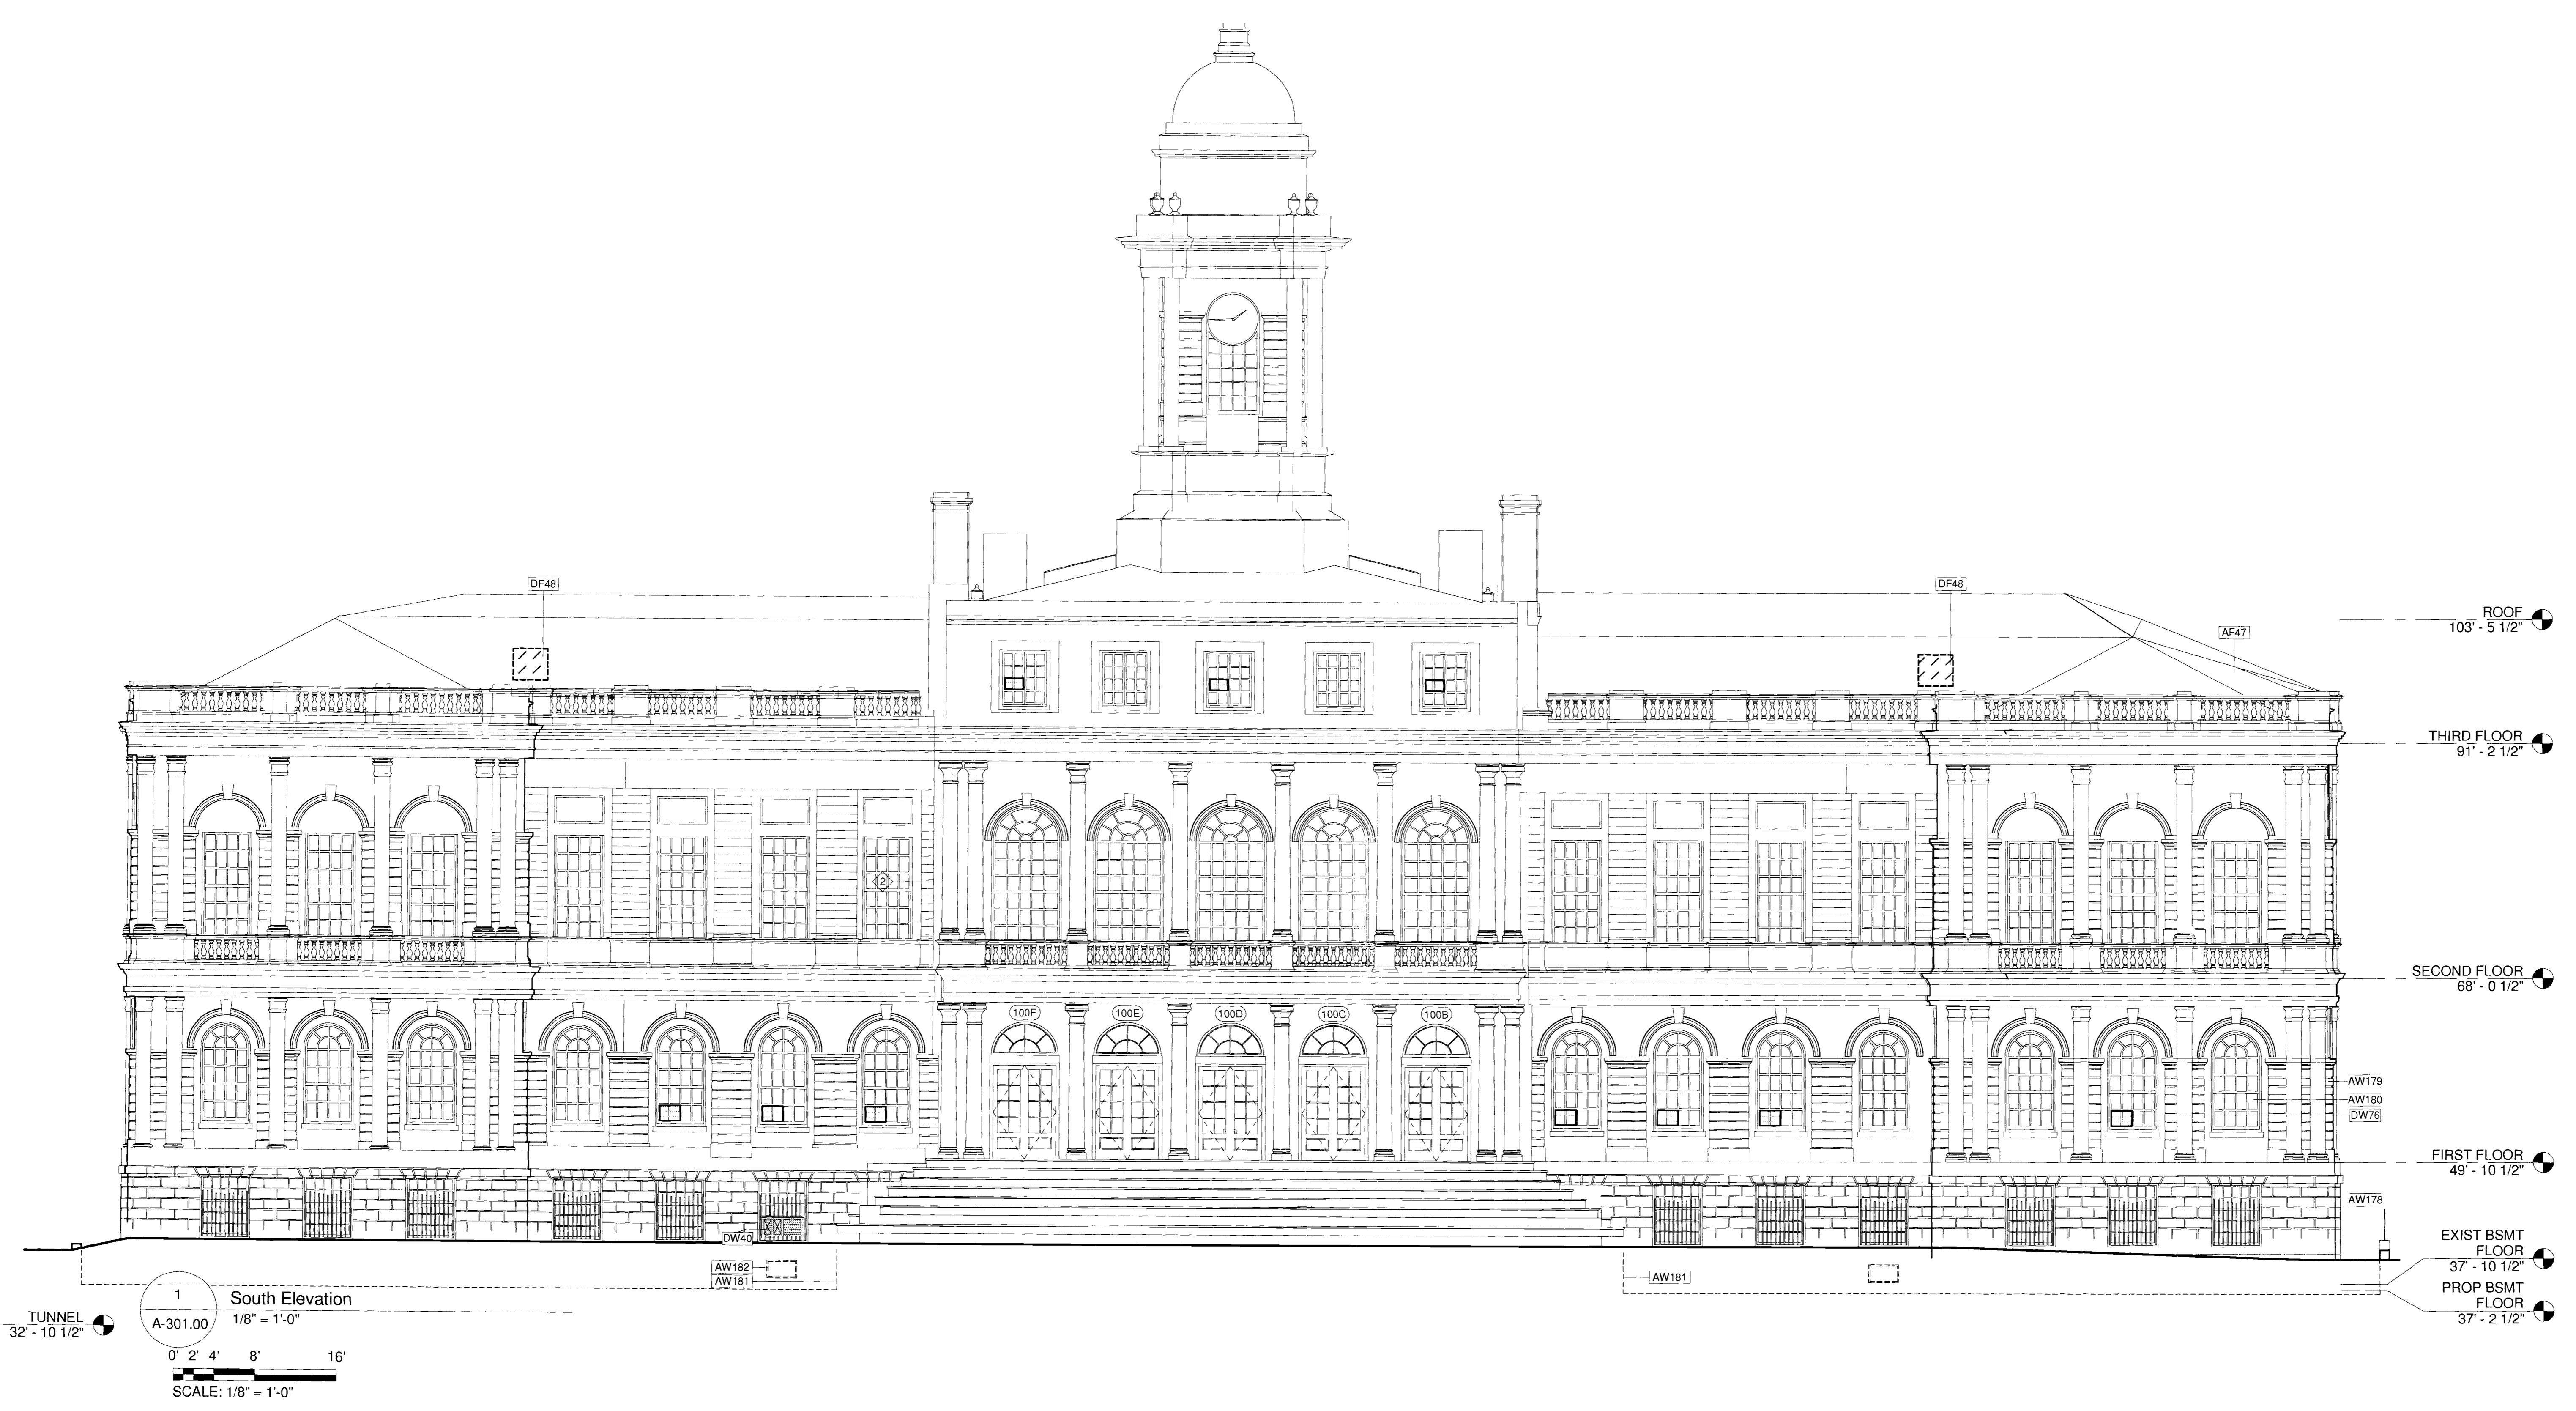

SEAL:

REVISIONS:		
NUMBER	DESCRIPTION	DATE



NEW YORK CITY DEPARTMENT OF DESIGN + CONSTRUCTION

DIVISION OF STRUCTURES
 BUREAU OF ARCHITECTURE & ENGINEERING

CAPITAL PROJECT NUMBER:
 CITYHALL2

PROJECT NAME:
 Renovation of City Hall
 Bid Package 2

FOR THE:

DRAWING TITLE:
South Elevation

DRAWN BY: TB SCALE: 1/8" = 1'-0"
 CHECKED BY: NA DATE: 10.08.10

DRAWING NUMBER:
A-301.00


SHEET NUMBER:
 15 OF 42

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 OCT 20 2010
 DEPT OF DESIGN + CONSTRUCTION



DOB PERMIT APPLICATION

KEYNOTE LEGEND	
AF47	EXISTING LEAD COATED COPPER ROOF
AW178	EXISTING GRANITE BASE
AW179	EXISTING STONE FACADE
AW180	EXISTING WINDOW, TYP.
AW181	LINE OF AREAWAY BELOW
DF09	REMOVE ROOFING AND SHEATHING TO PROVIDE OPENING FOR MECHANICAL PENTHOUSE. MECHANICAL PENTHOUSE PROVIDED UNDER SEPARATE CONTRACT. SEE MECHANICAL DRAWINGS AND COORDINATE WITH MECHANICAL CONTRACTOR. REFER TO STRUCTURAL DRAWINGS FOR ROOF OPENINGS.
DW40	EXISTING MEP EQUIPMENT TO BE REMOVED: REFER TO MEP DEMOLITION DRAWINGS, TYPICAL.
DW76	REMOVE EXISTING WINDOW A/C UNIT, TYPICAL.
DW77	CAREFULLY REMOVE WINDOW SASHES TO PROVIDE ACCESS ROUTE FOR EQUIPMENT TO THE REFRIGERATION MACHINE ROOM. PROTECT SASHES AND REINSTALL.

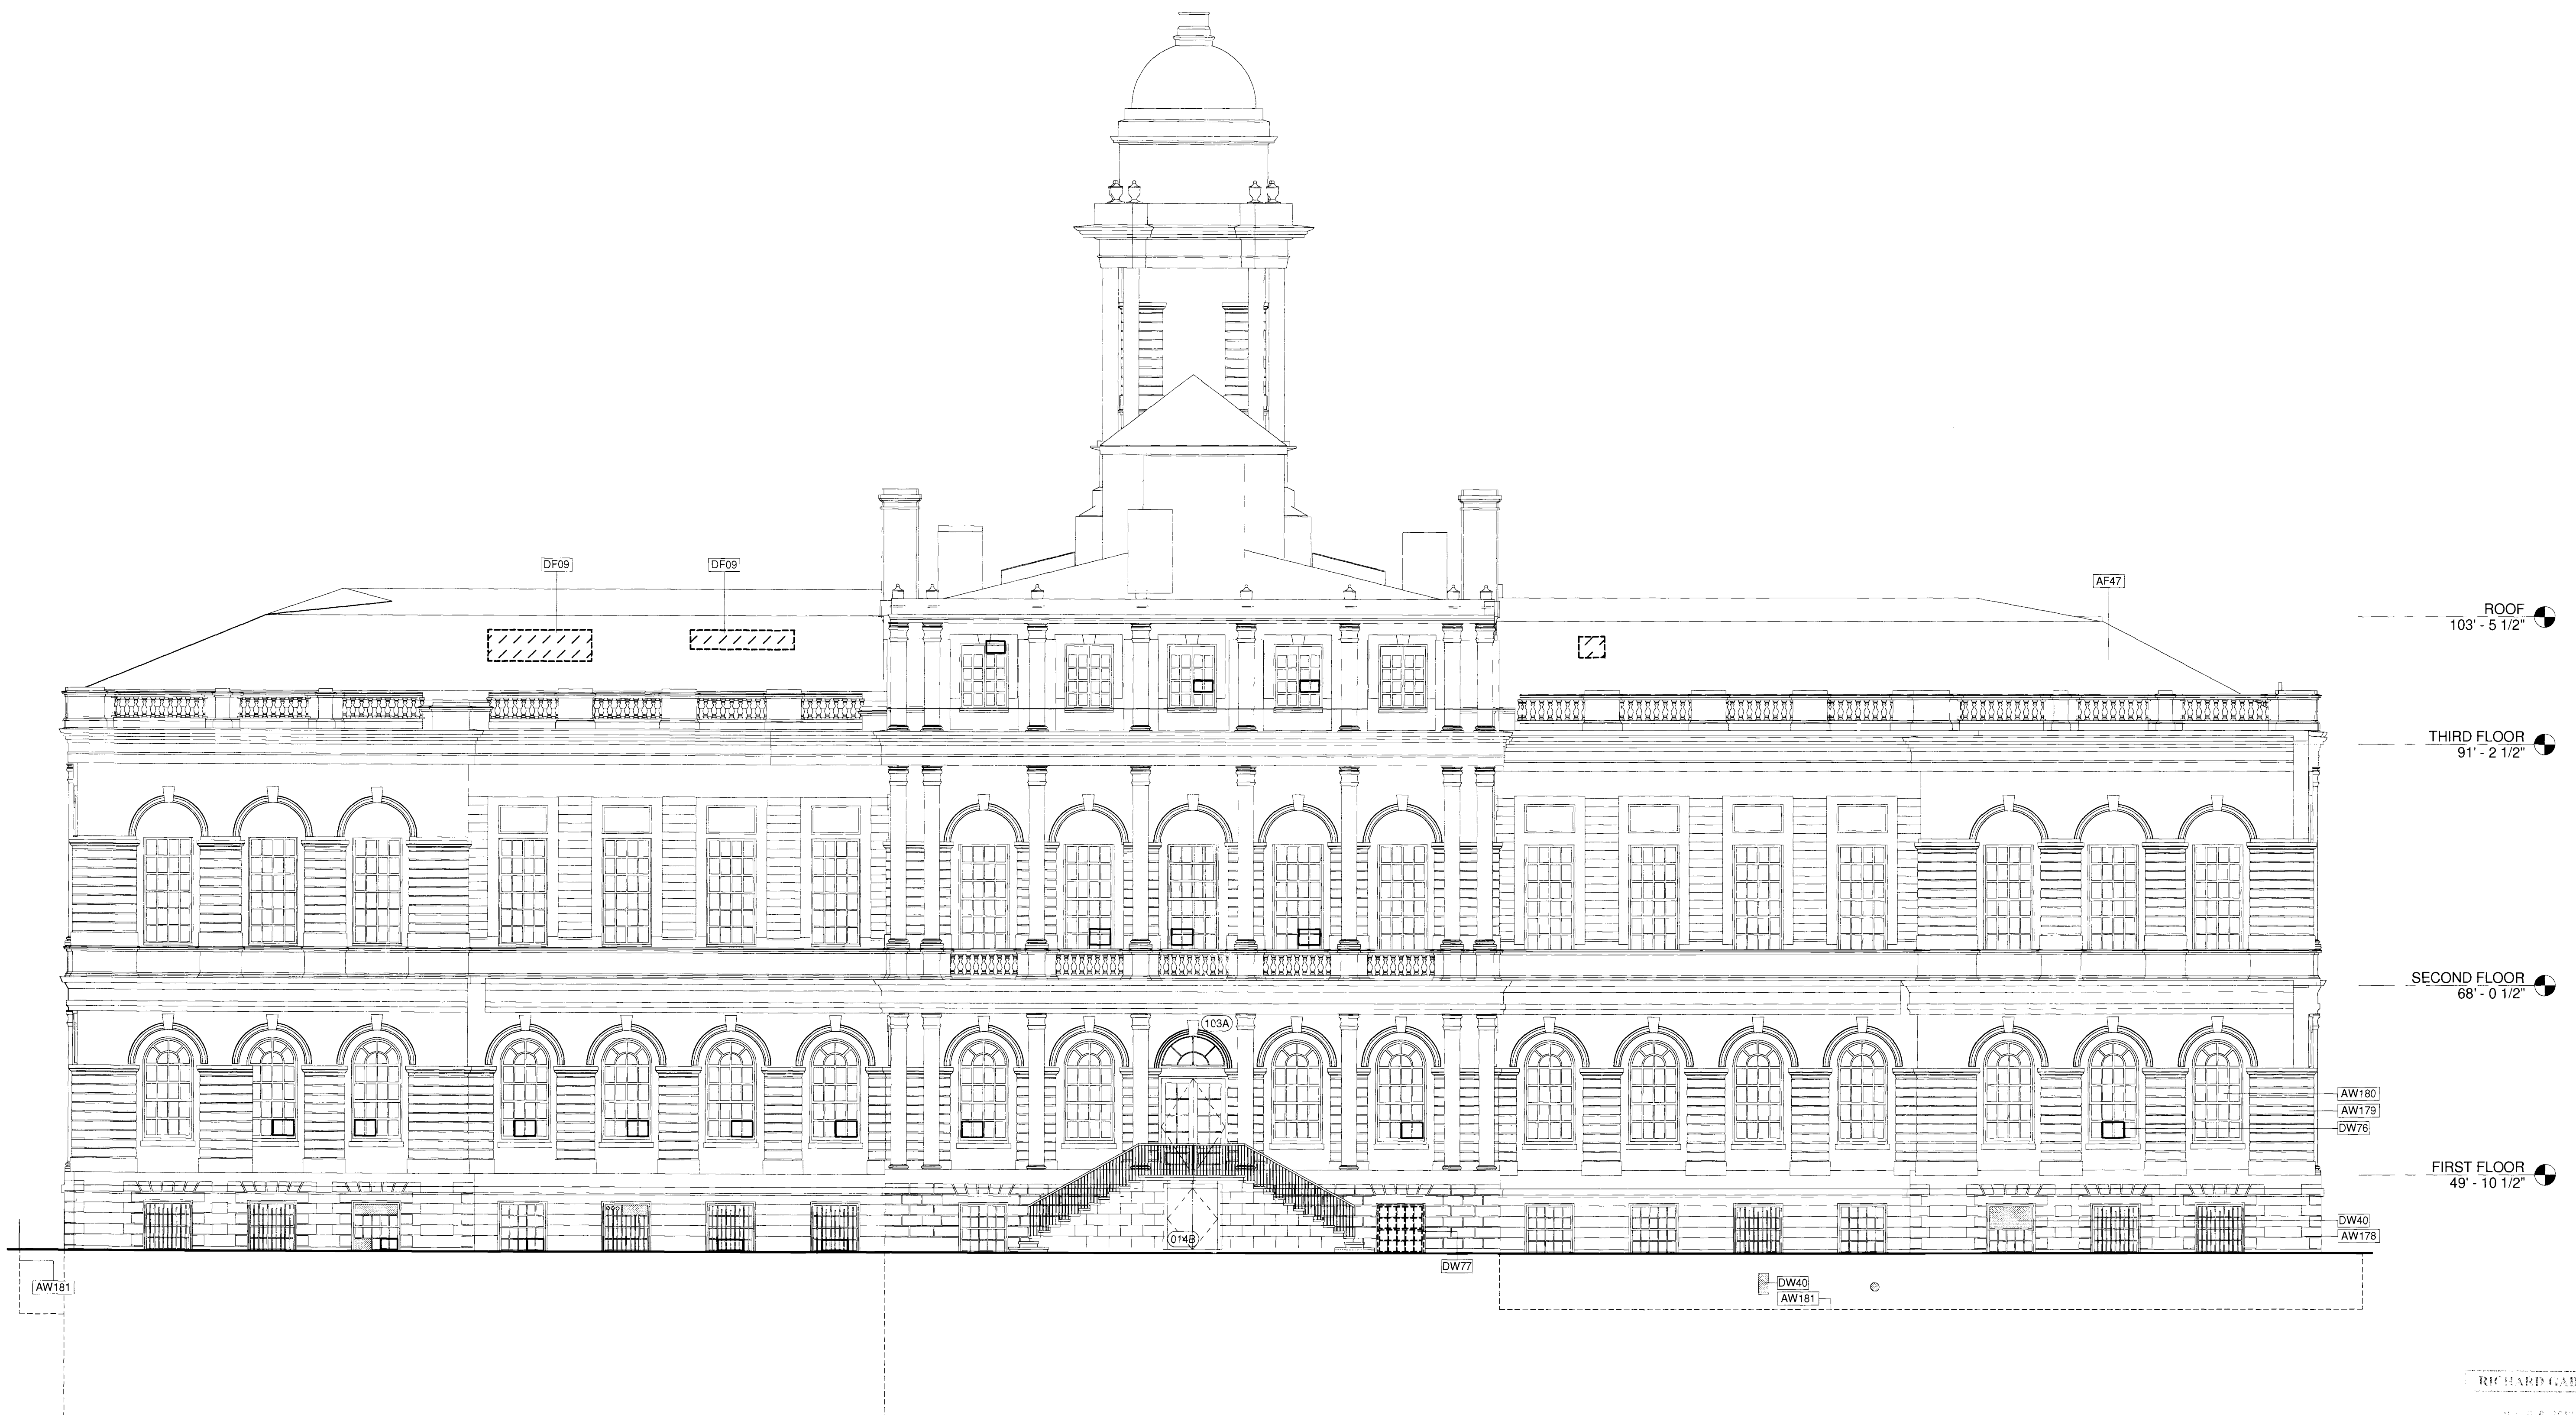

1 North Elevation
 A-302.00 1/8" = 1'-0"
 0' 2' 4' 8' 16'
 SCALE: 1/8" = 1'-0"

SEAL:

REVISIONS:		
NUMBER	DESCRIPTION	DATE



DIVISION OF STRUCTURES
 BUREAU OF ARCHITECTURE & ENGINEERING

CAPITAL PROJECT NUMBER:
 CITYHALL2
 PROJECT NAME:
 Renovation of City Hall
 Bid Package 2

FOR THE:

DRAWING TITLE:
 North Elevation

DRAWN BY: TB SCALE: 1/8" = 1'-0"
 CHECKED BY: NA DATE: 10.08.10

DRAWING NUMBER:


A-302.00

SHEET NUMBER:
 16 OF 42



DOB PERMIT APPLICATION


KEYNOTE LEGEND	
AF47	EXISTING LEAD COATED COPPER ROOF
AW178	EXISTING GRANITE BASE
AW179	EXISTING STONE FACADE
AW180	EXISTING WINDOW, TYP.
DF09	REMOVE ROOFING AND SHEATHING TO PROVIDE OPENING FOR MECHANICAL PENTHOUSE. MECHANICAL PENTHOUSE PROVIDED UNDER SEPARATE CONTRACT. SEE MECHANICAL DRAWINGS AND COORDINATE WITH MECHANICAL CONTRACTOR. REFER TO STRUCTURAL DRAWINGS FOR ROOF OPENINGS.
DW40	EXISTING MEP EQUIPMENT TO BE REMOVED. REFER TO MEP DEMOLITION DRAWINGS, TYPICAL.
DW76	REMOVE EXISTING WINDOW A/C UNIT, TYPICAL.

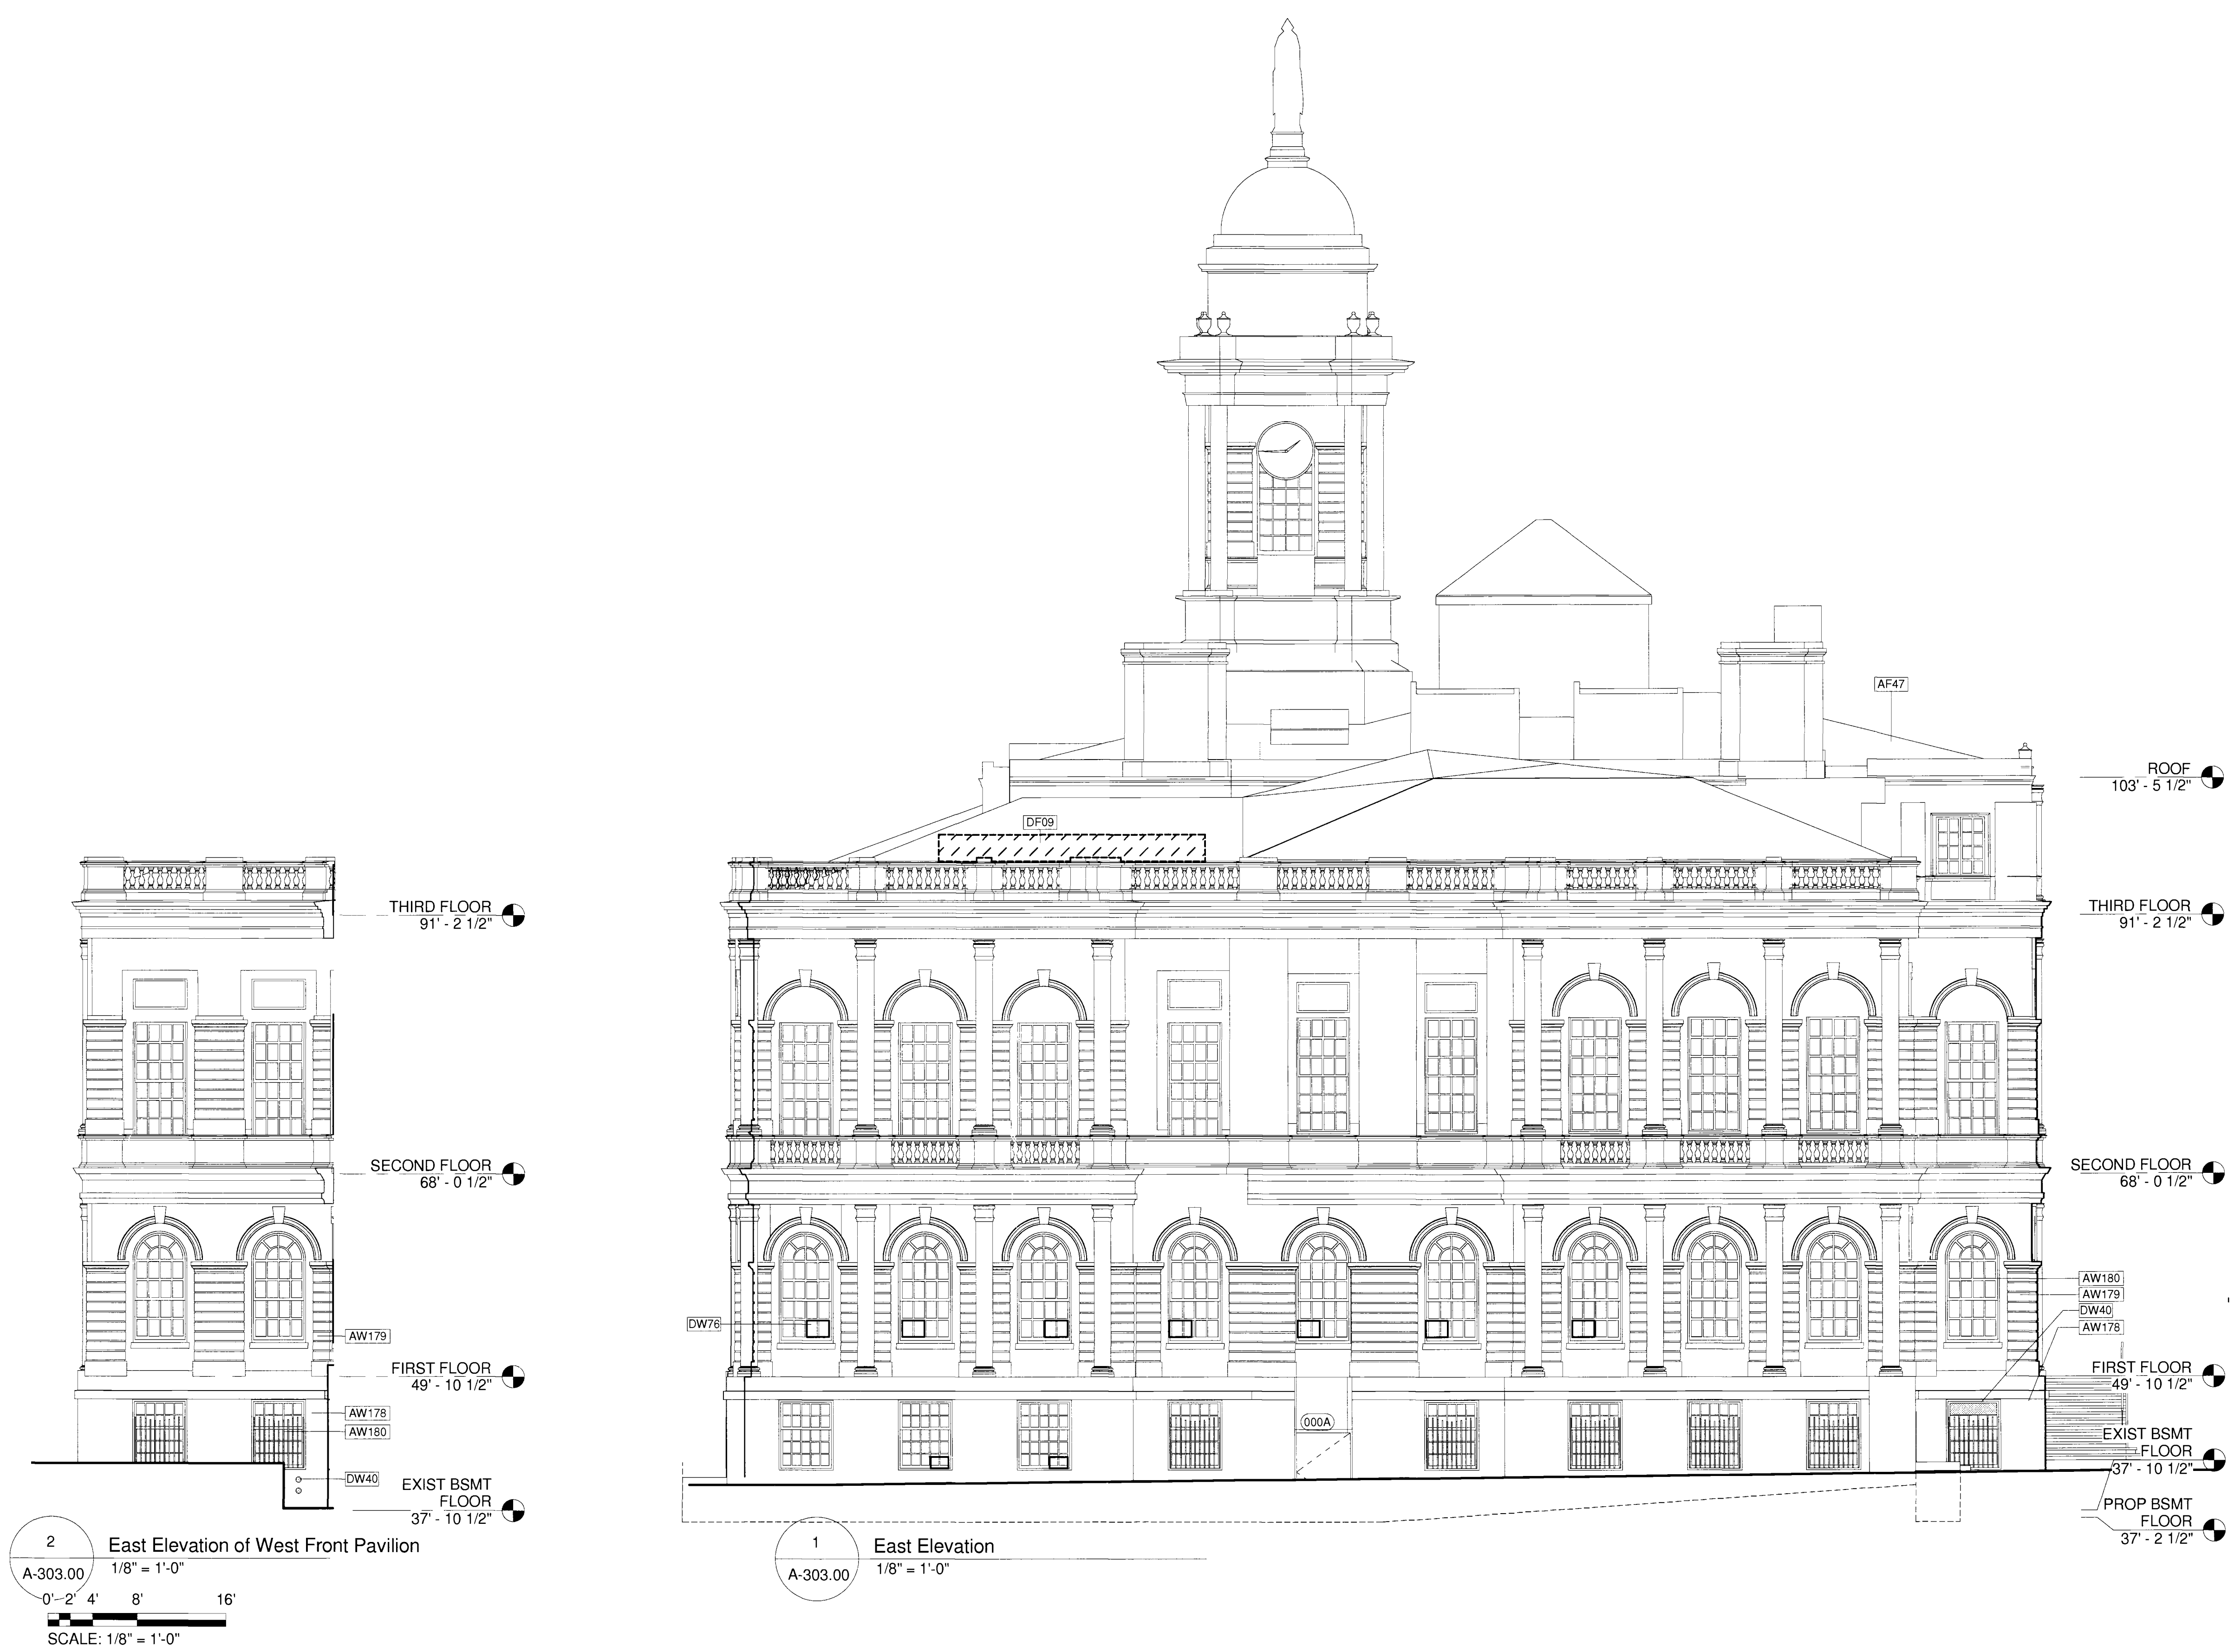

2 East Elevation of West Front Pavilion
 A-303.00 1/8" = 1'-0"
 0' 2' 4' 8' 16'
 SCALE: 1/8" = 1'-0"

1 East Elevation
 A-303.00 1/8" = 1'-0"

SEAL:

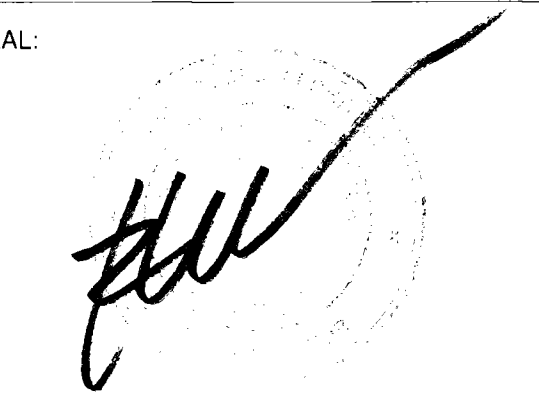

REVISIONS:

NUMBER	DESCRIPTION	DATE



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 BUREAU OF ARCHITECTURE & ENGINEERING

CAPITAL PROJECT NUMBER:
 CITYHALL2
 PROJECT NAME:
 Renovation of City Hall
 Bid Package 2

FOR THE:

DRAWING TITLE:
East Elevations

DRAWN BY: TB SCALE: 1/8" = 1'-0"
 CHECKED BY: NA DATE: 10.06.10

DRAWING NUMBER:


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SHEET NUMBER:
 17 OF 42




DOB PERMIT APPLICATION


KEYNOTE LEGEND	
AF47	EXISTING LEAD COATED COPPER ROOF
AW178	EXISTING GRANITE BASE
AW179	EXISTING STONE FACADE
AW180	EXISTING WINDOW, TYP.
AW181	LINE OF AREAWAY BELOW
AW182	LOUVER BELOW WINDOW. REFER TO MECHANICAL AND STRUCTURAL DRAWINGS FOR ADDITIONAL INFORMATION.
DF09	REMOVE ROOFING AND SHEATHING TO PROVIDE OPENING FOR MECHANICAL PENTHOUSE. MECHANICAL PENTHOUSE PROVIDED UNDER SEPARATE CONTRACT. SEE MECHANICAL DRAWINGS AND COORDINATE WITH MECHANICAL CONTRACTOR. REFER TO STRUCTURAL DRAWINGS FOR ROOF OPENINGS.
DW40	EXISTING MEP EQUIPMENT TO BE REMOVED: REFER TO MEP DEMOLITION DRAWINGS, TYPICAL.
DW76	REMOVE EXISTING WINDOW A/C UNIT, TYPICAL.

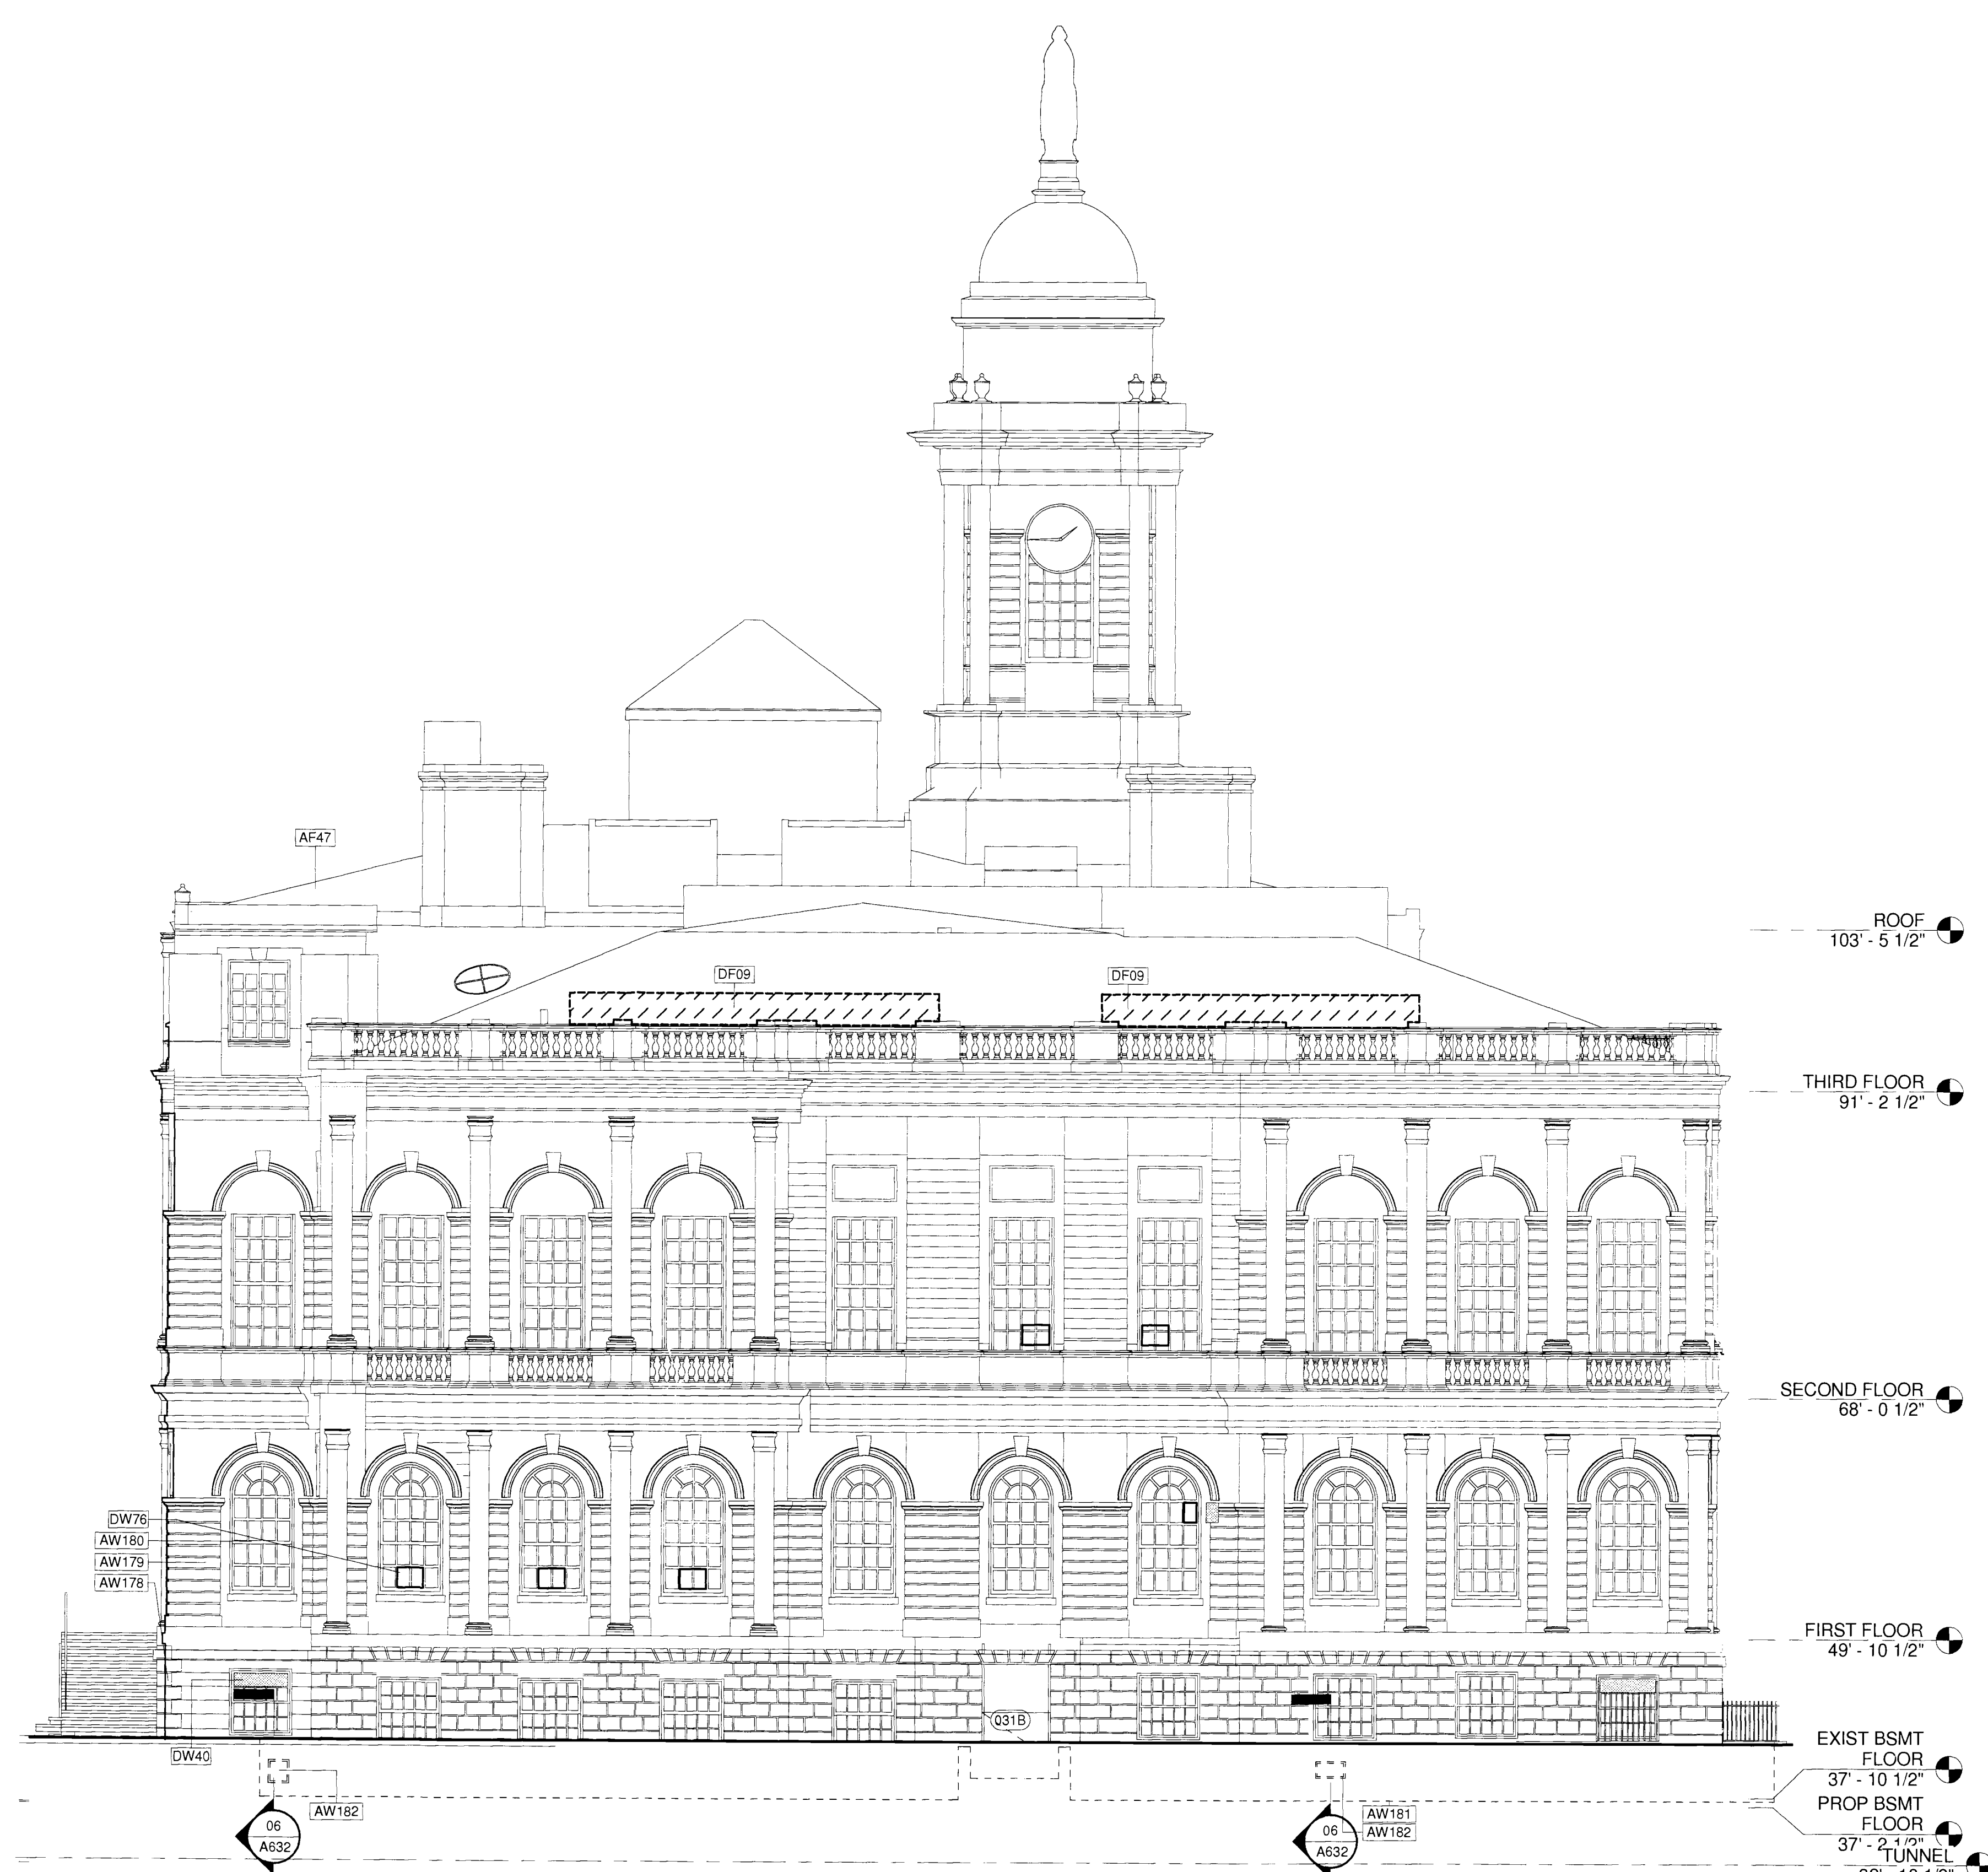

2 West Elevation
 A-304.00
 1/8" = 1'-0"
 0' 2' 4' 8' 16'
 SCALE: 1/8" = 1'-0"

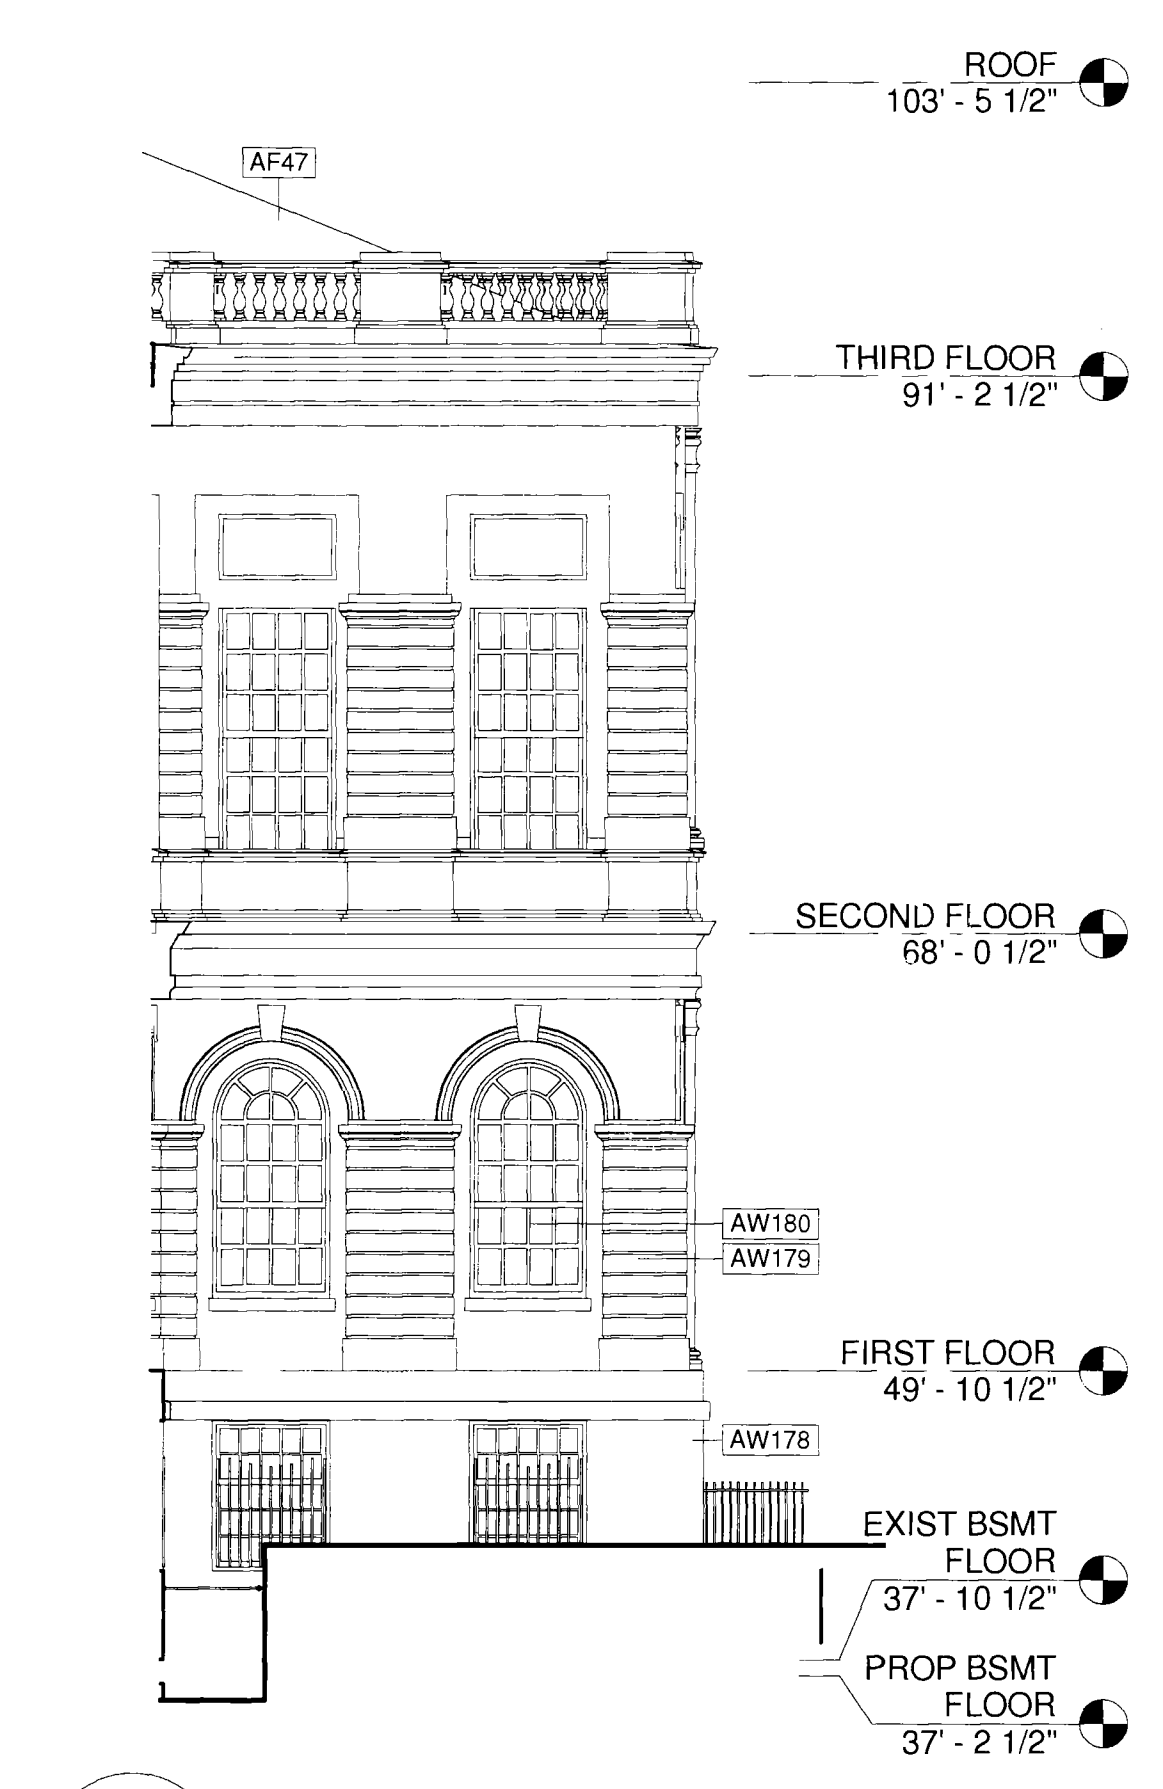

1 West Elevation of East Front Pavilion
 A-304.00
 1/8" = 1'-0"

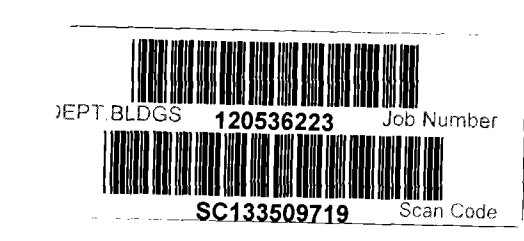

DOB PERMIT APPLICATION

SEAL:

REVISIONS:

NUMBER	DESCRIPTION	DATE



DIVISION OF STRUCTURES
 BUREAU OF ARCHITECTURE &
 ENGINEERING

CAPITAL PROJECT NUMBER:
 CITYHALL2
 PROJECT NAME:
 Renovation of City Hall
 Bid Package 2

FOR THE:


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West Elevations

DRAWN BY: TB SCALE: 1/8" = 1'-0"
 CHECKED BY: NA DATE: 10.08.10

DRAWING NUMBER:
A-304.00

SHEET NUMBER:
 18 OF 42

KEYNOTE LEGEND	
AC89	EXPOSED SPRINKLER PIPING: SEE FIRE SPRINKLER DRAWINGS.
AF139	REFER TO STRUCTURAL AND MEP DRAWINGS FOR INFORMATION ON FRAMING AND MECHANICAL DETAILS FOR NEW COOLING TOWERS. ROOFING TO BE COVERED UNDER SEPARATE CONTRACT.
AW18	FABRICATE AND INSTALL NEW FAN COIL UNIT WOOD ENCLOSURE.
AW185	PROVIDE PLASTER FINISH TO MATCH EXISTING ADJACENT PLASTER

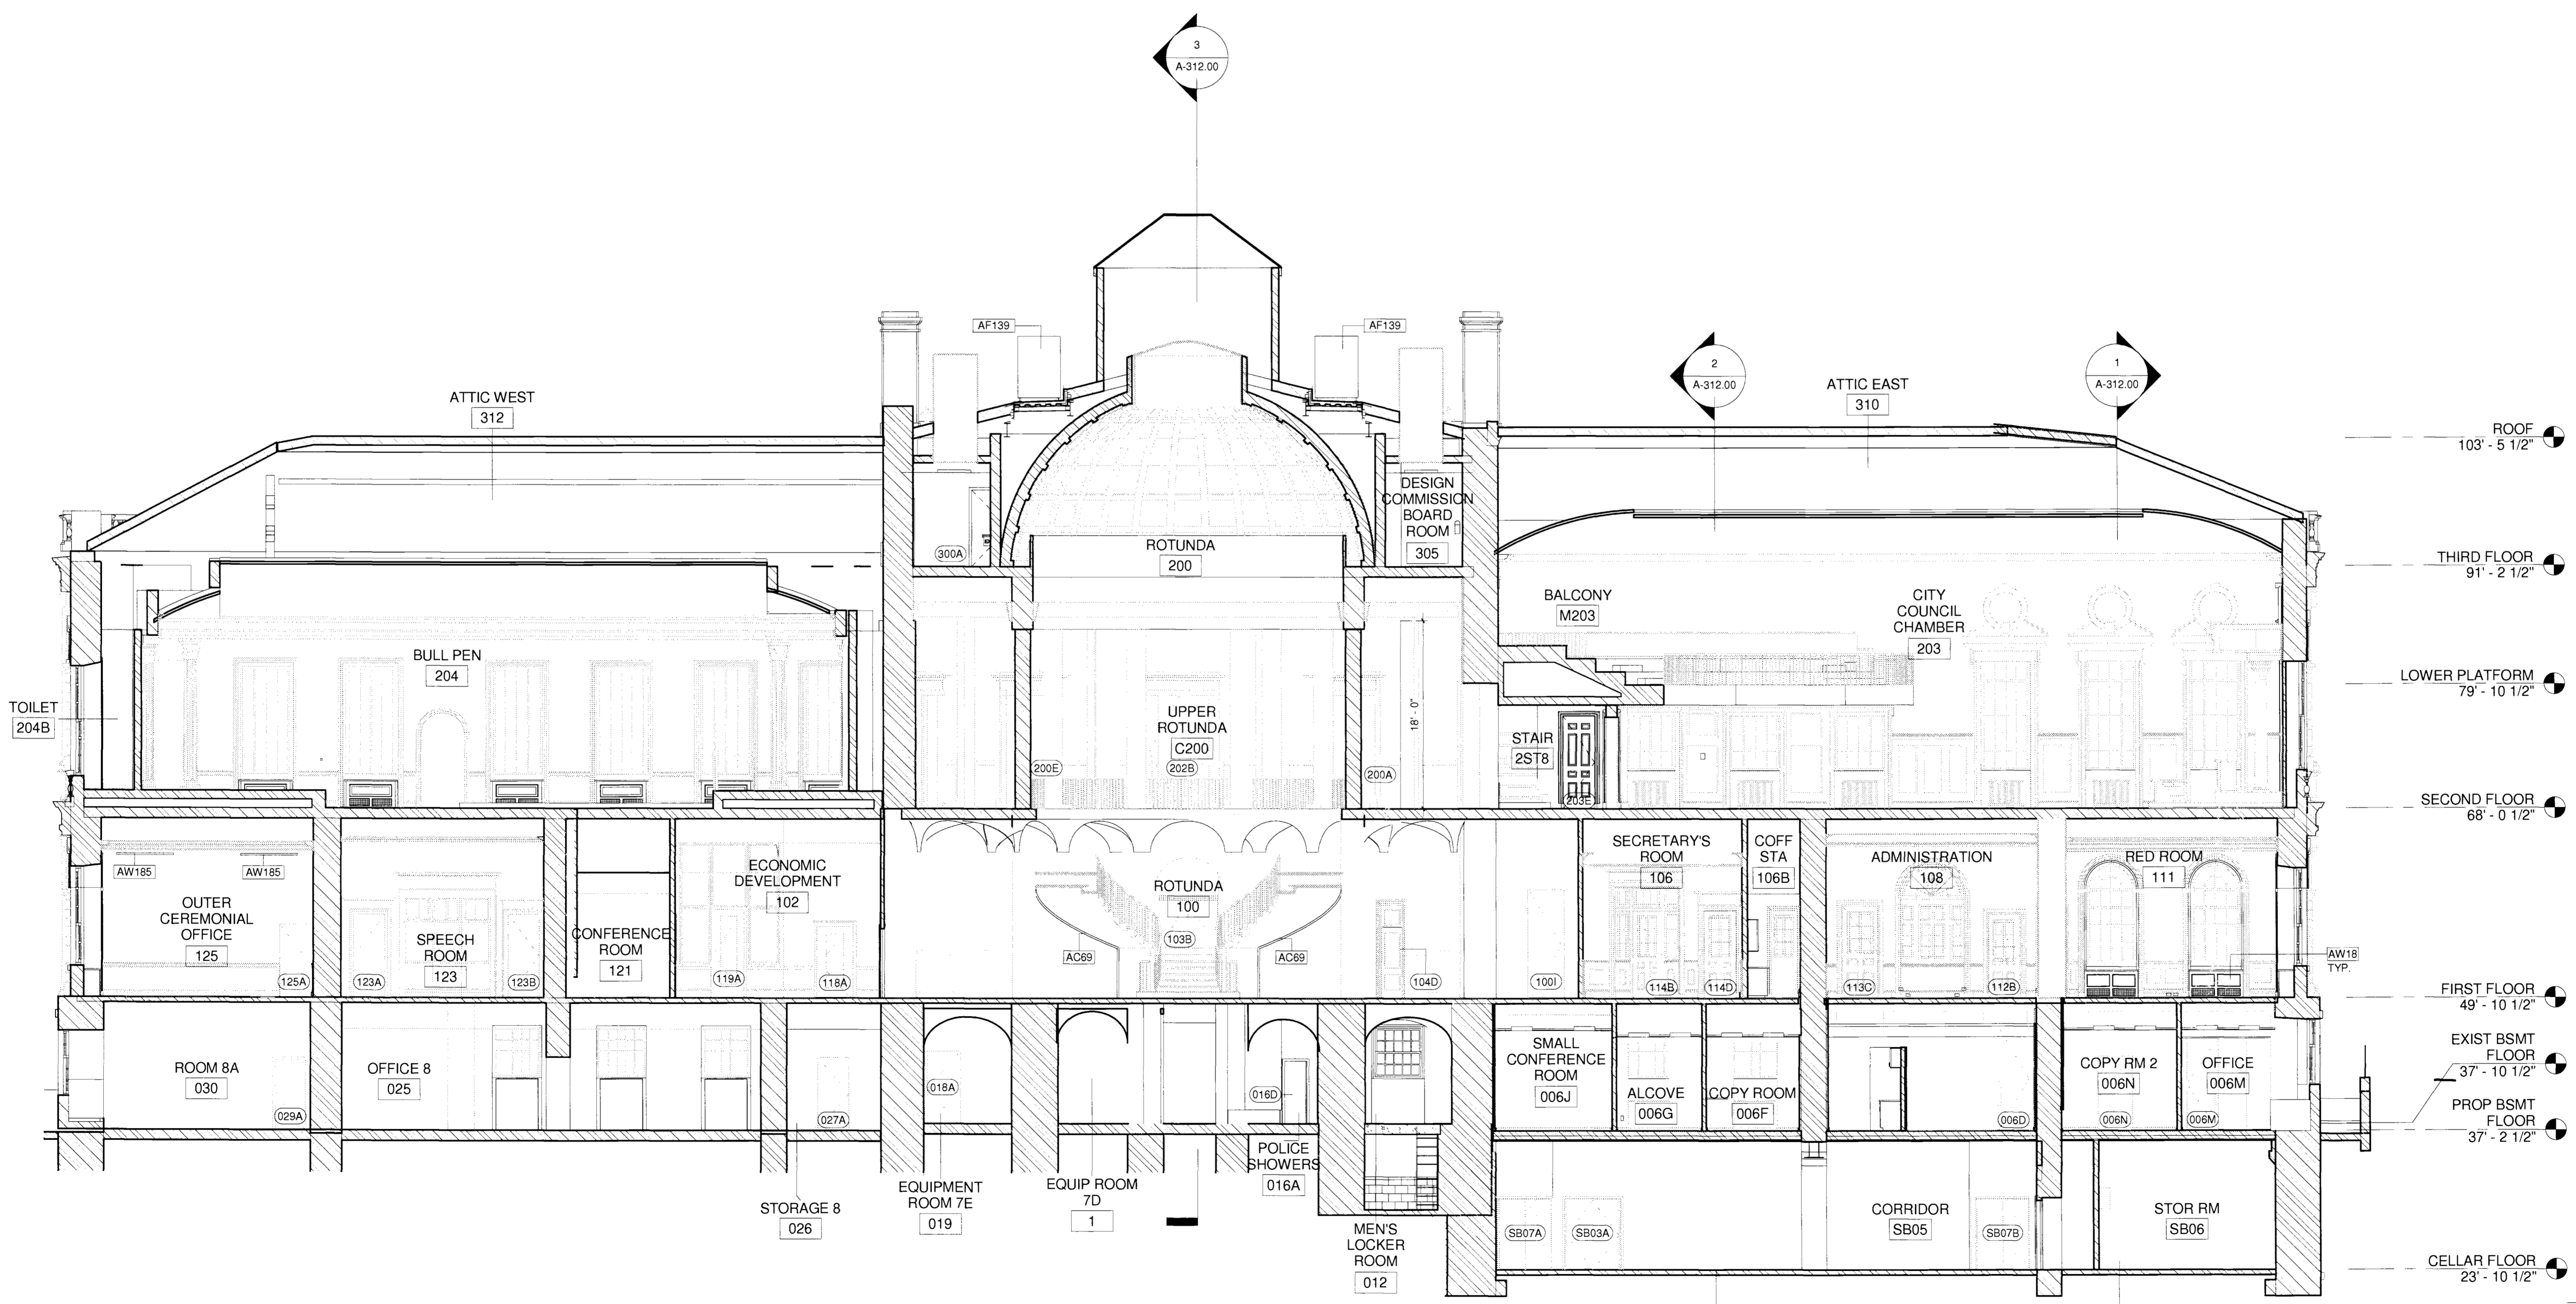

SEAL: *[Signature]*

REVISIONS:

NUMBER	DESCRIPTION	DATE



NEW YORK CITY DEPARTMENT OF DESIGN + CONSTRUCTION

DIVISION OF STRUCTURES
 BUREAU OF ARCHITECTURE & ENGINEERING

CAPITAL PROJECT NUMBER:
 CITYHALL2
 PROJECT NAME:
 Renovation of City Hall
 Bid Package 2

FOR THE:

DRAWING TITLE:
Building Section AA


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CHECKED BY: Checker DATE: 10.08.10

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A-311.00

SHEET NUMBER:
 19 OF 42


1 Section AA - Long Section To North
 A-311.00 1/8" = 1'-0"

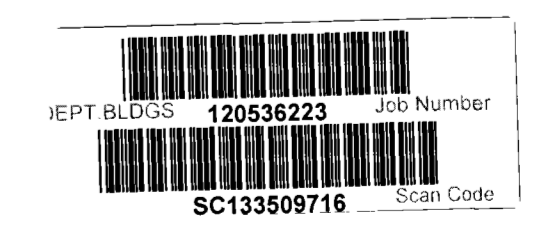


0' 2' 4' 8' 16'
 SCALE: 1/8" = 1'-0"

DOB PERMIT APPLICATION


KEYNOTE LEGEND	
AC69	EXPOSED SPRINKLER PIPING; SEE FIRE SPRINKLER DRAWINGS.
AC70	EXIT SIGN; REFER TO REFLECTED CEILING PLANS FOR MORE INFORMATION, TYPICAL.
AW18	FABRICATE AND INSTALL NEW FAN COIL UNIT WOOD ENCLOSURE.

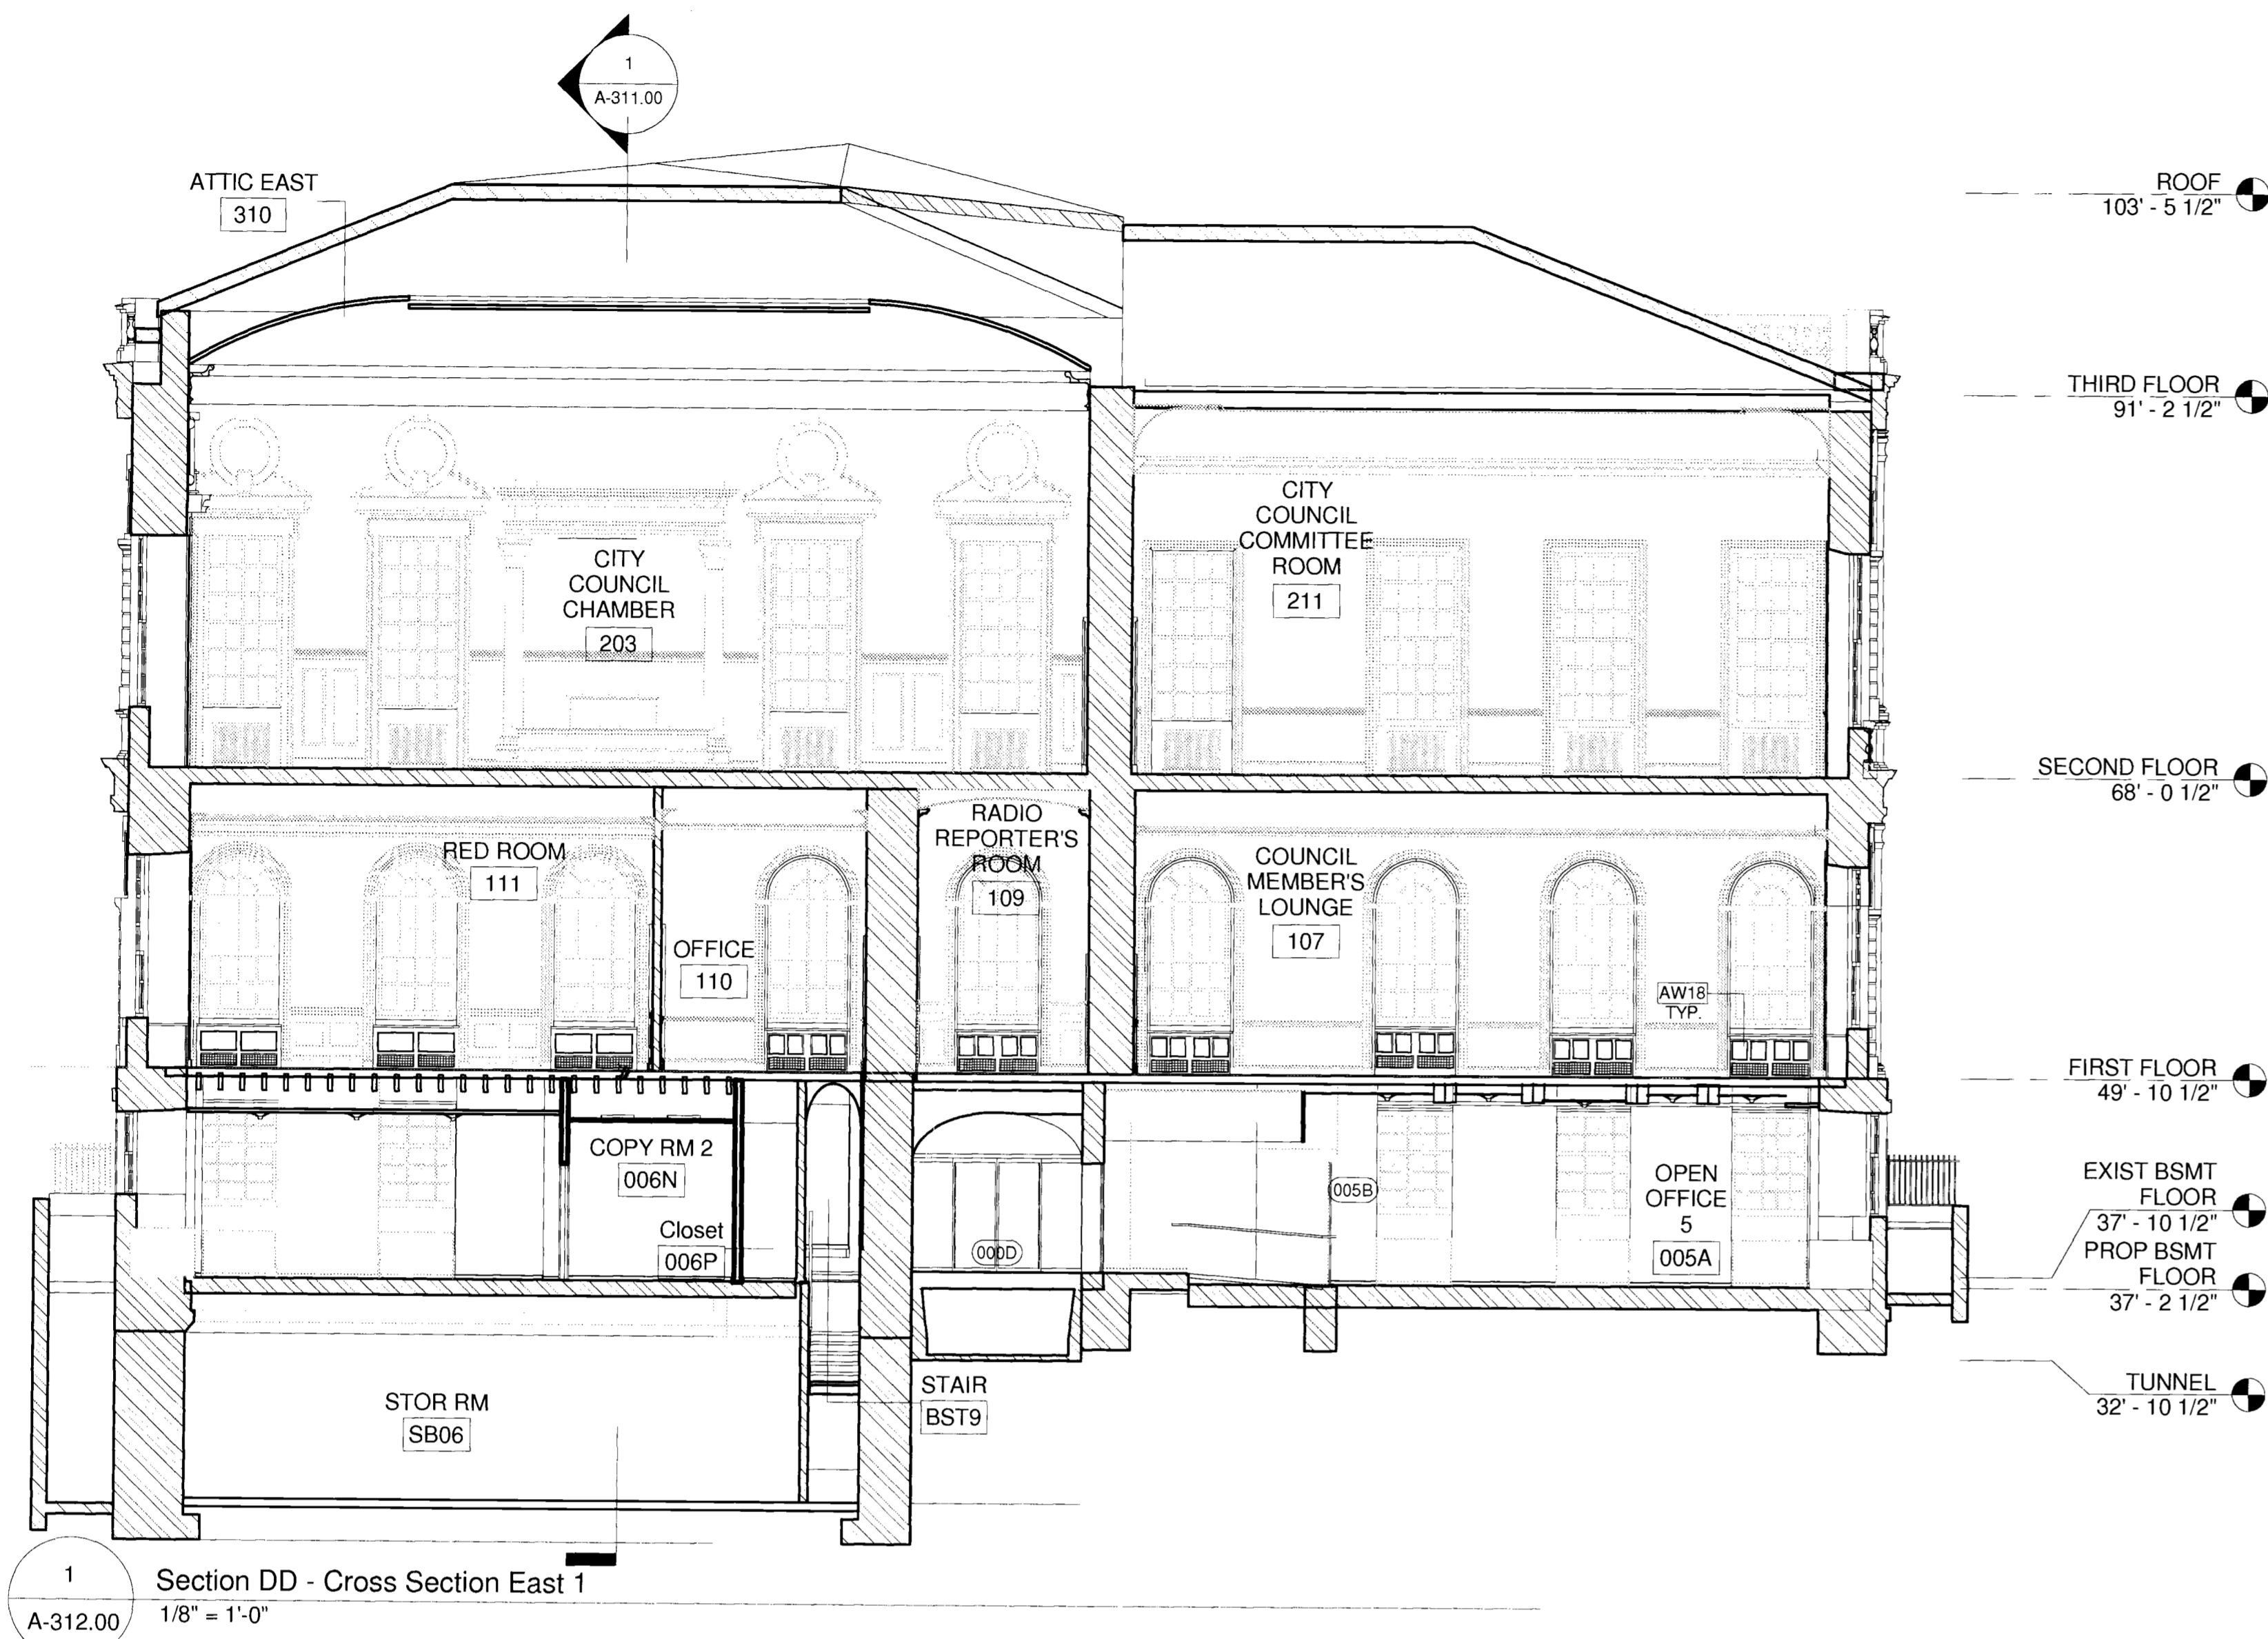

1 Section DD - Cross Section East 1
A-312.00 1/8" = 1'-0"

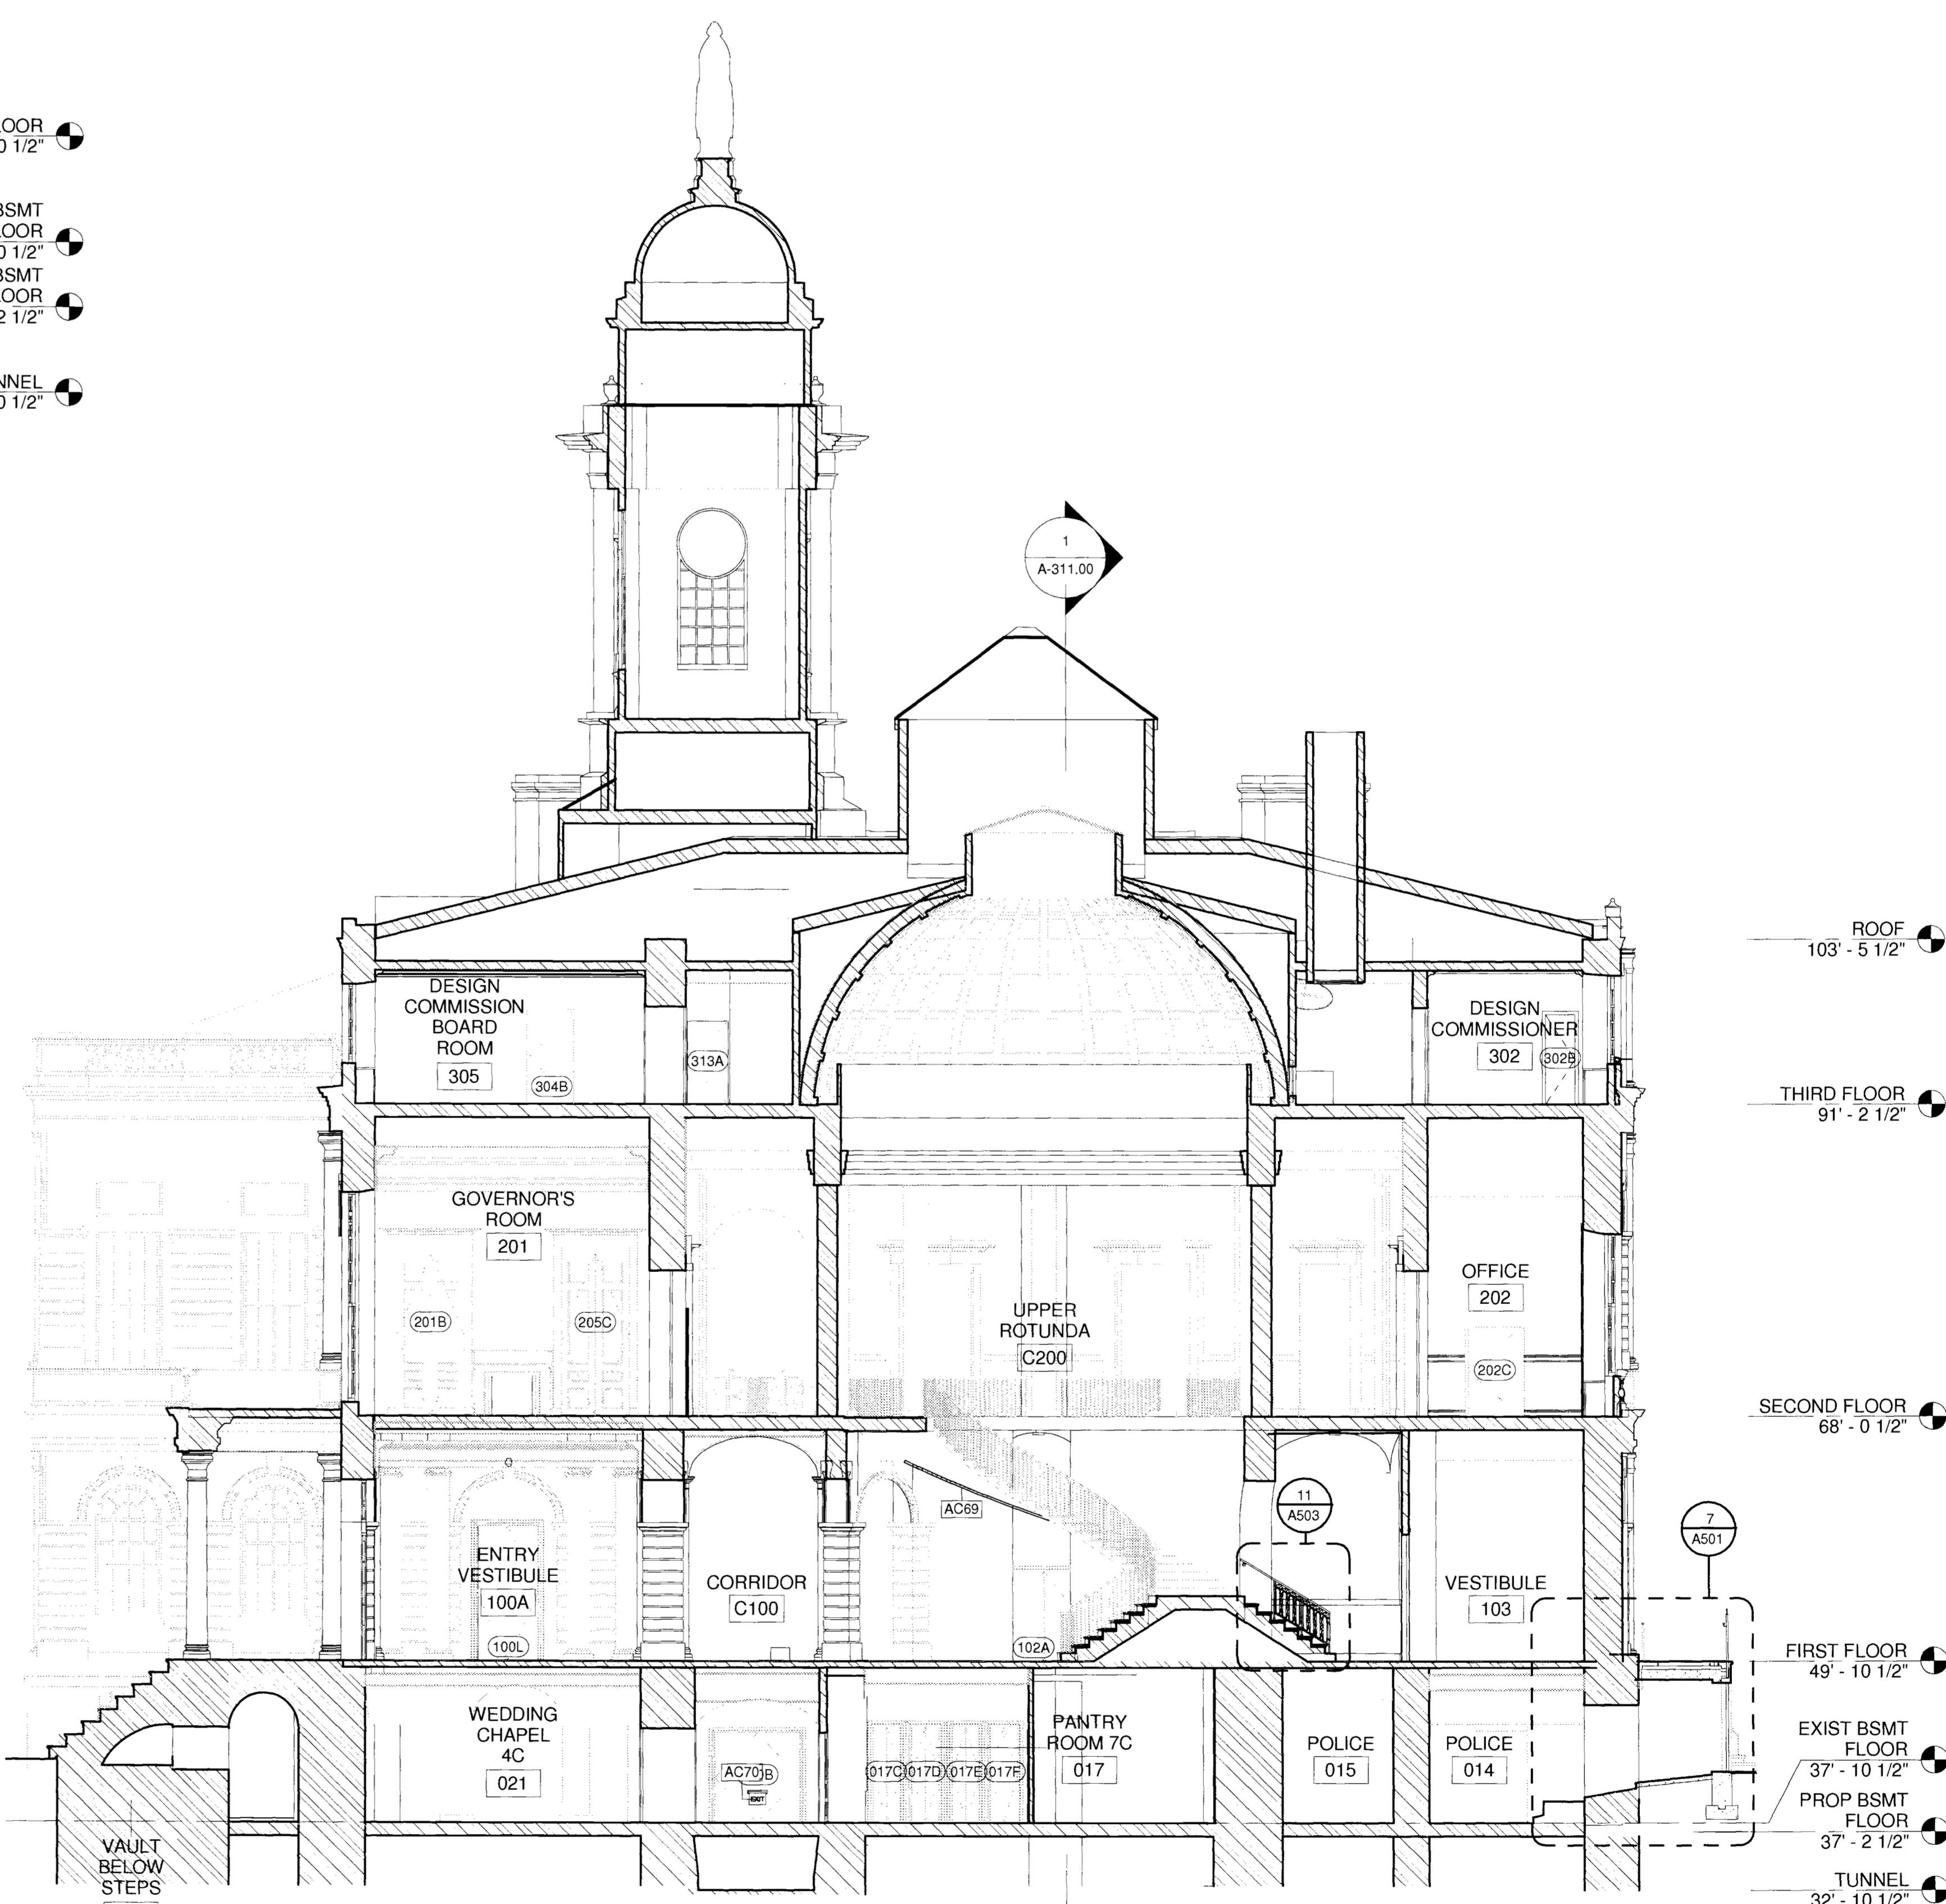

3 Section CC - Cross Section At Rotunda
A-312.00 1/8" = 1'-0"

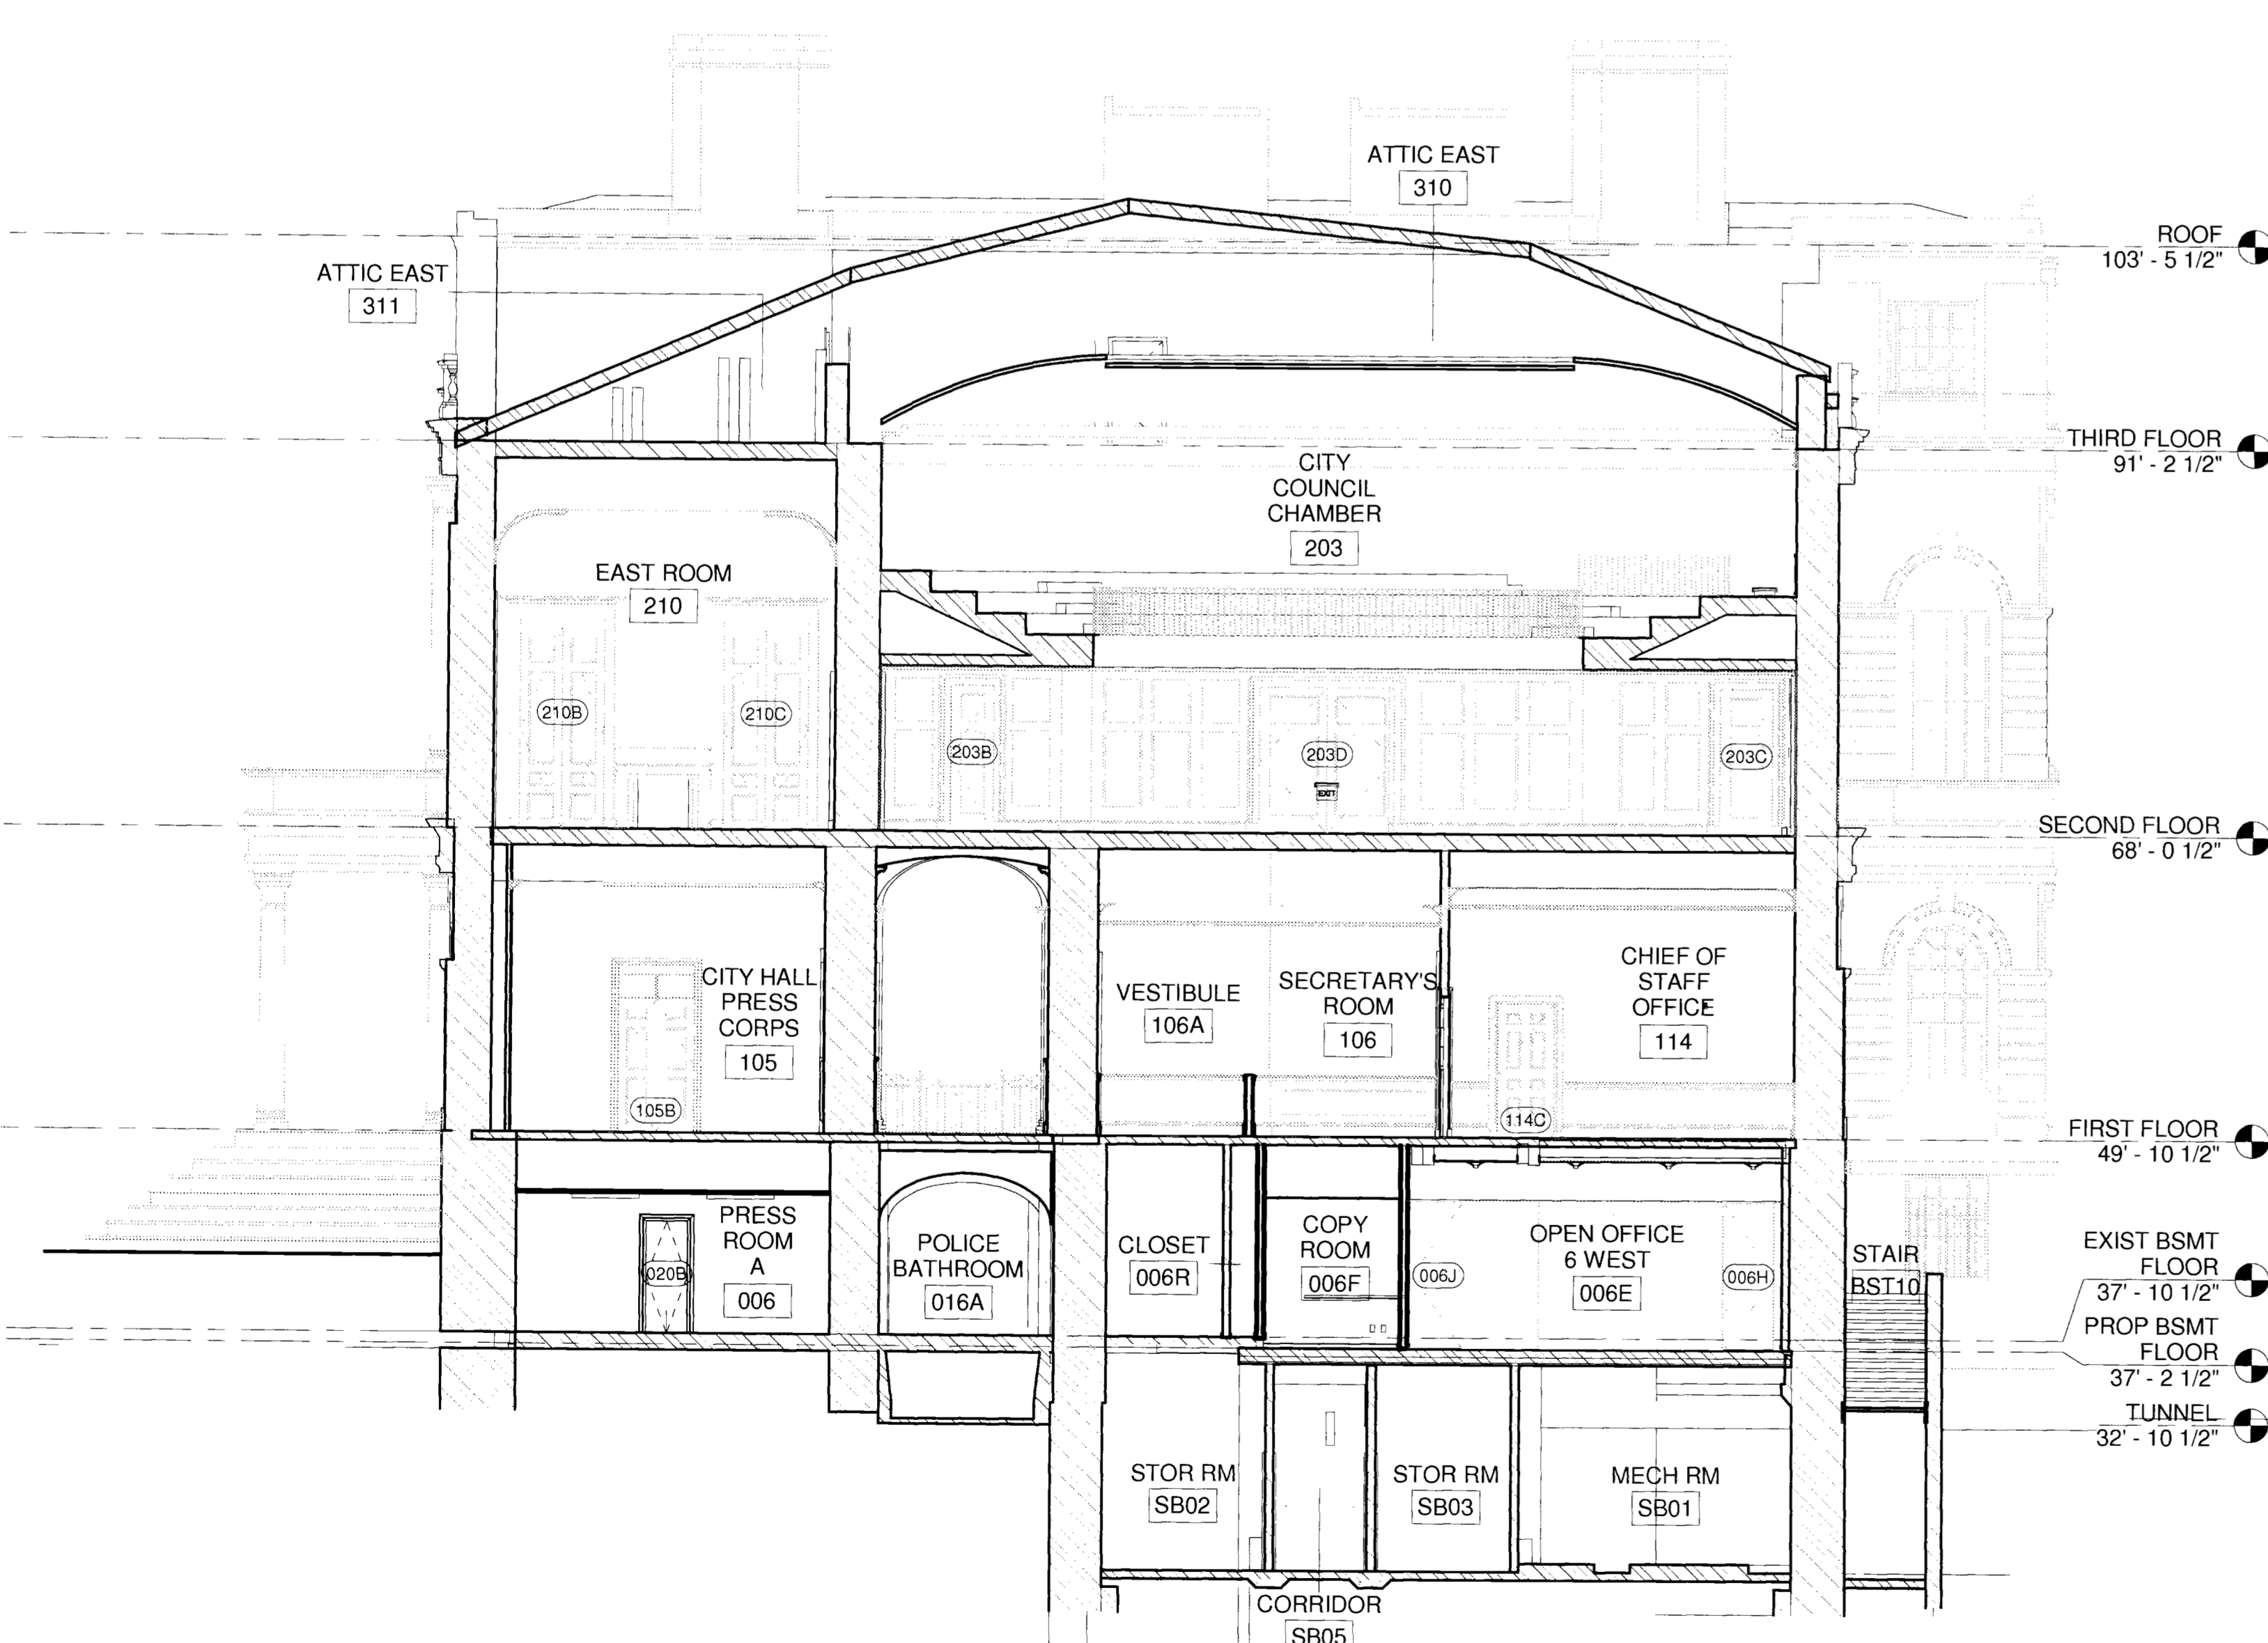

2 Section EE - Cross Section East 2
A-312.00 1/8" = 1'-0"

SEAL:

[Handwritten signature]

REVISIONS:

NUMBER	DESCRIPTION	DATE



NEW YORK CITY DEPARTMENT OF DESIGN + CONSTRUCTION
DIVISION OF STRUCTURES
BUREAU OF ARCHITECTURE & ENGINEERING

CAPITAL PROJECT NUMBER:
CITYHALL2
PROJECT NAME:
Renovation of City Hall
Bid Package 2



FOR THE:

DRAWING TITLE:
**Building Section
CC, DD and EE**

DRAWN BY: TB SCALE: 1/8" = 1'-0"
CHECKED BY: NA DATE: 10.08.10
DRAWING NUMBER:


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SHEET NUMBER:
20 OF 42

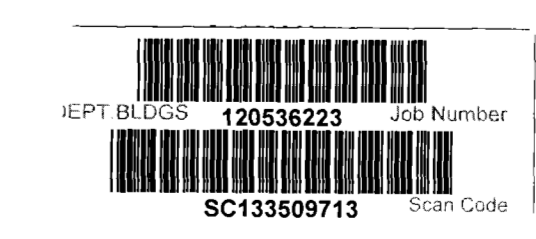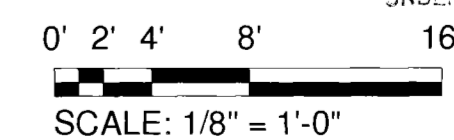


DOB PERMIT APPLICATION


NOTE: SEE PLUMBING DRAWINGS
 FOR ALL FIXTURE TYPES

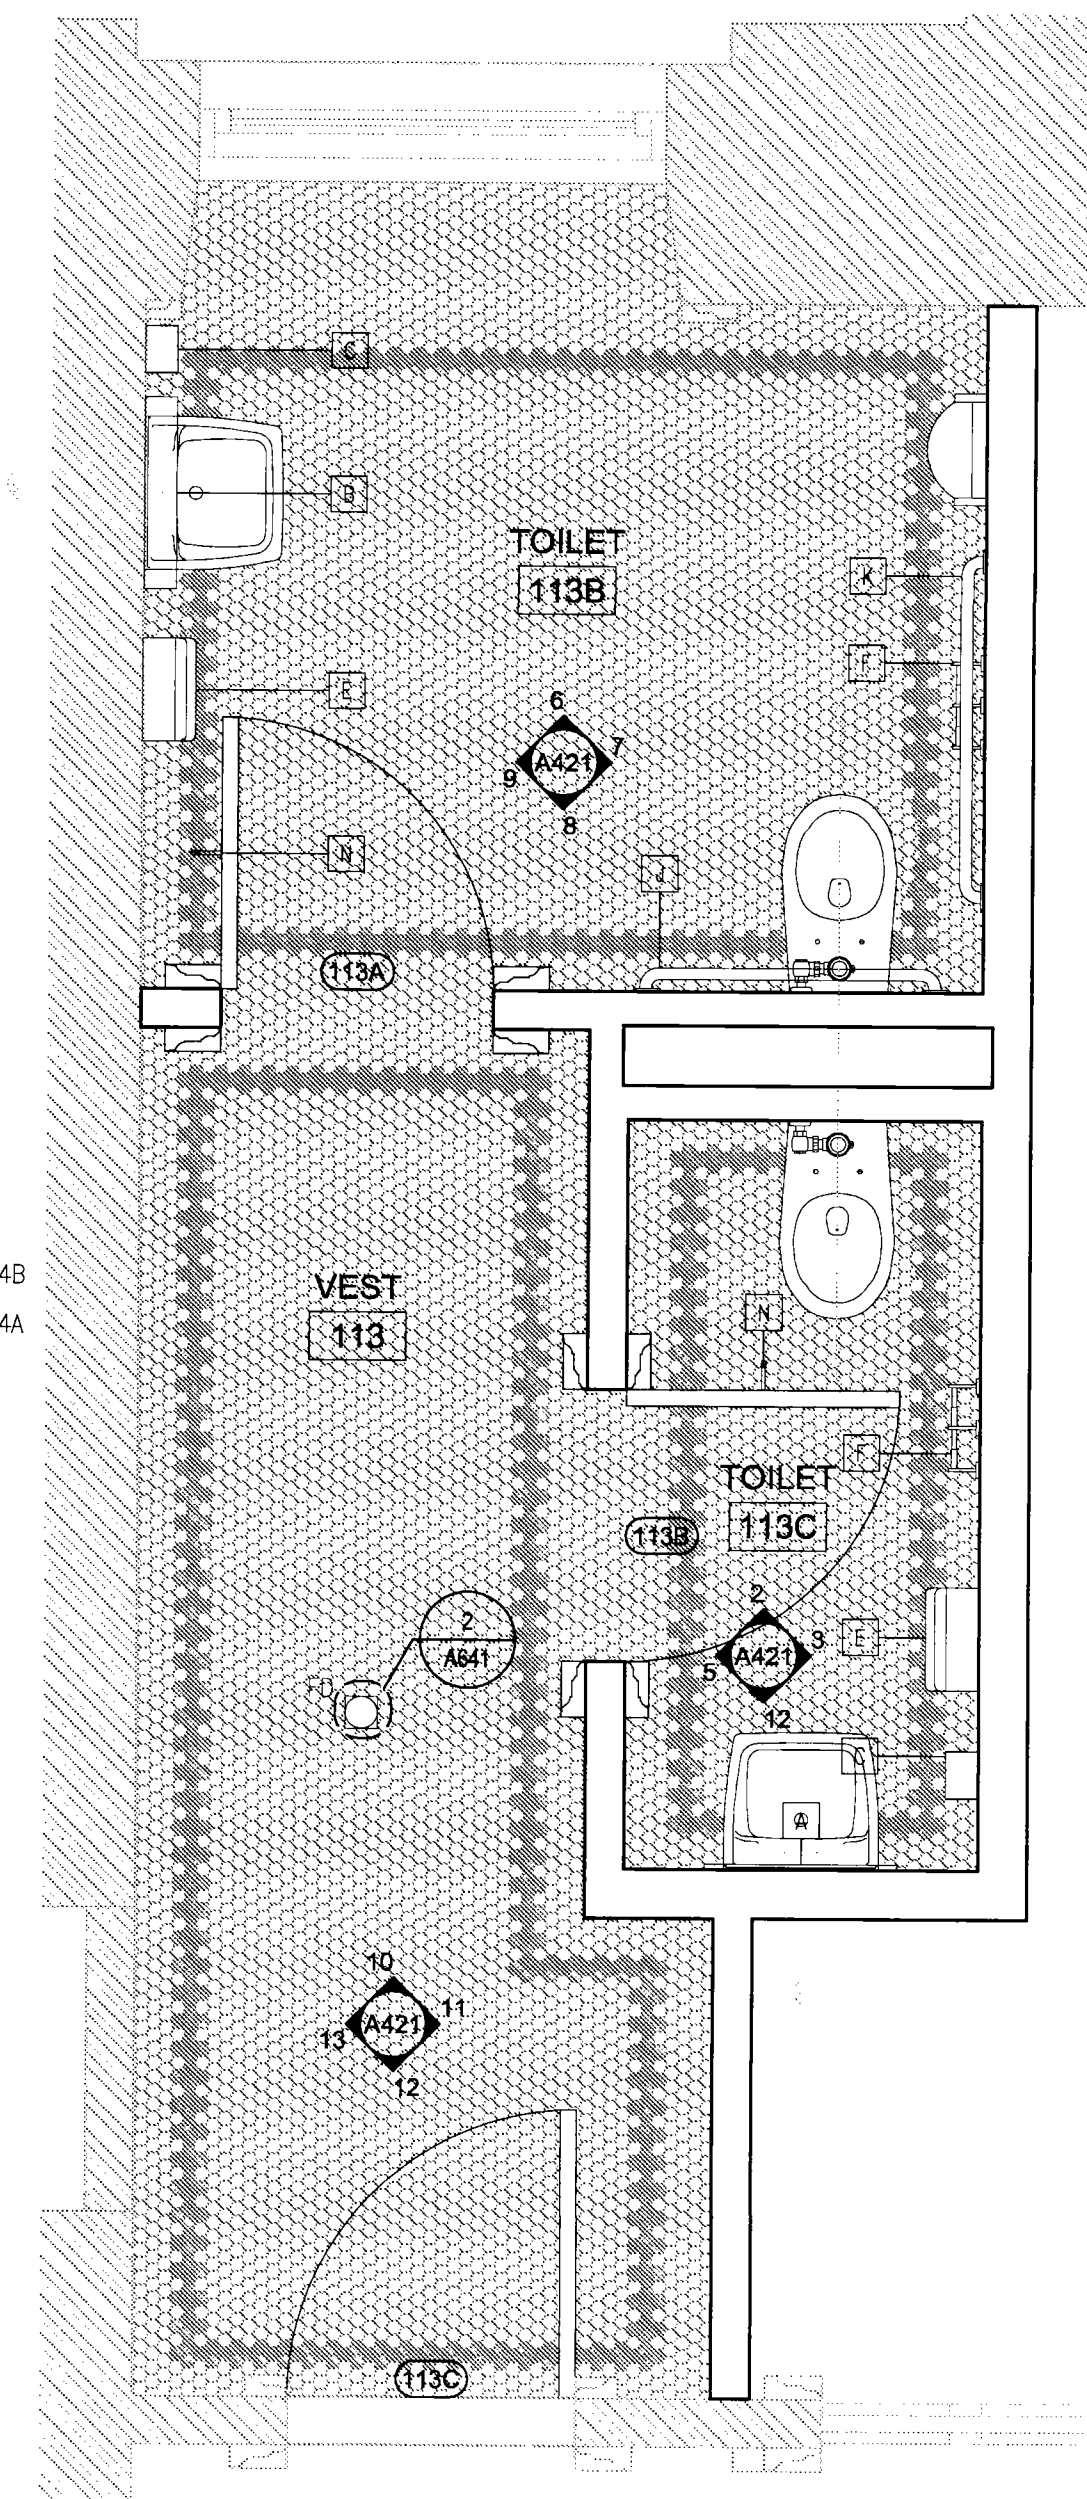


1 113 Toilet
 A421 1/2" = 1'-0"
 NOTE: SLOPE FLOOR
 TILE TO FLOOR DRAIN

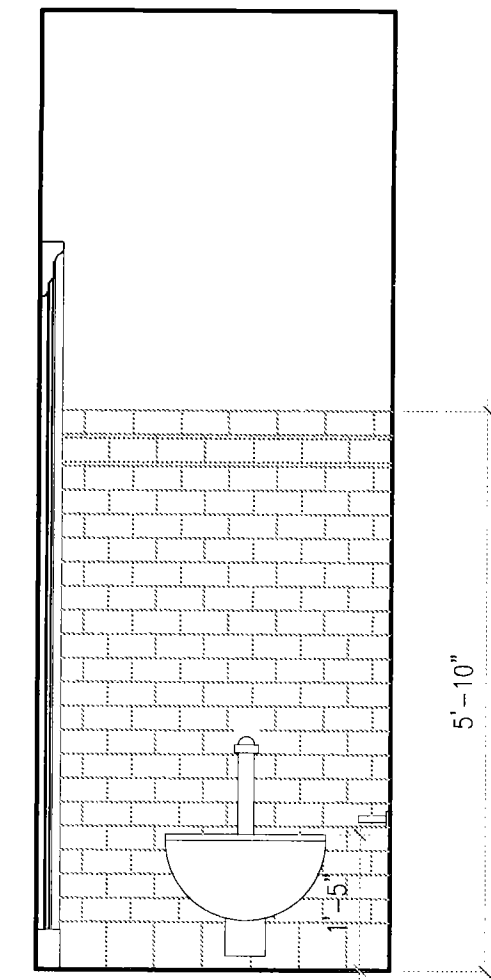


2 113C Toilet - North Elevation
 A421 1/2" = 1'-0"

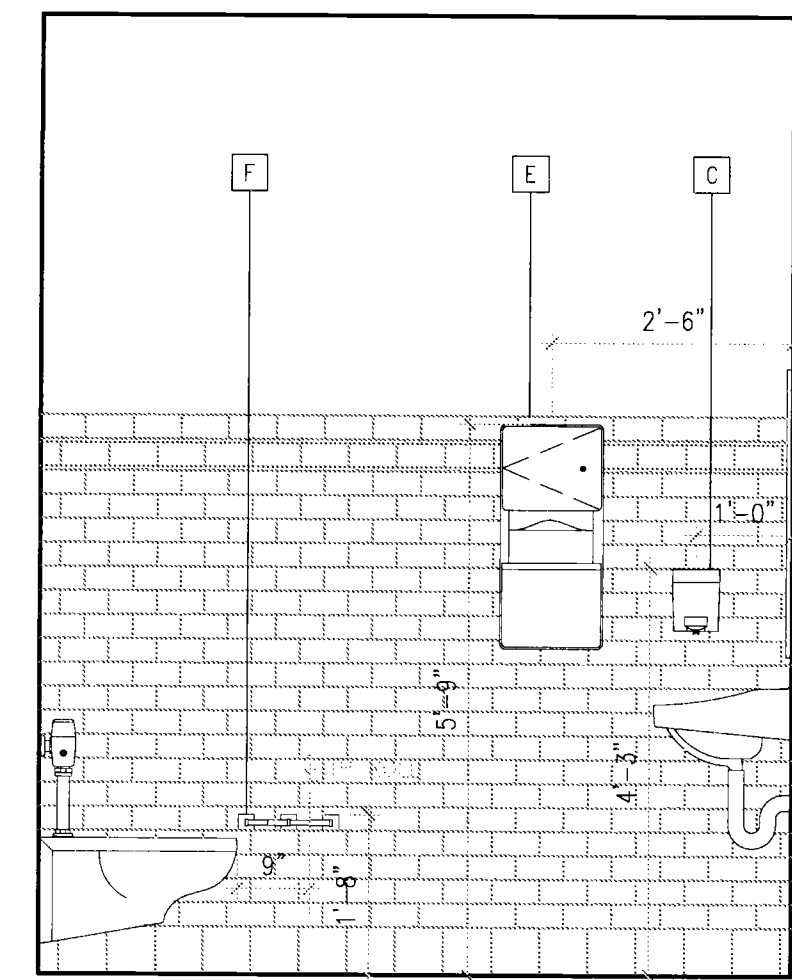


3 113C Toilet - East Elevation
 A421 1/2" = 1'-0"

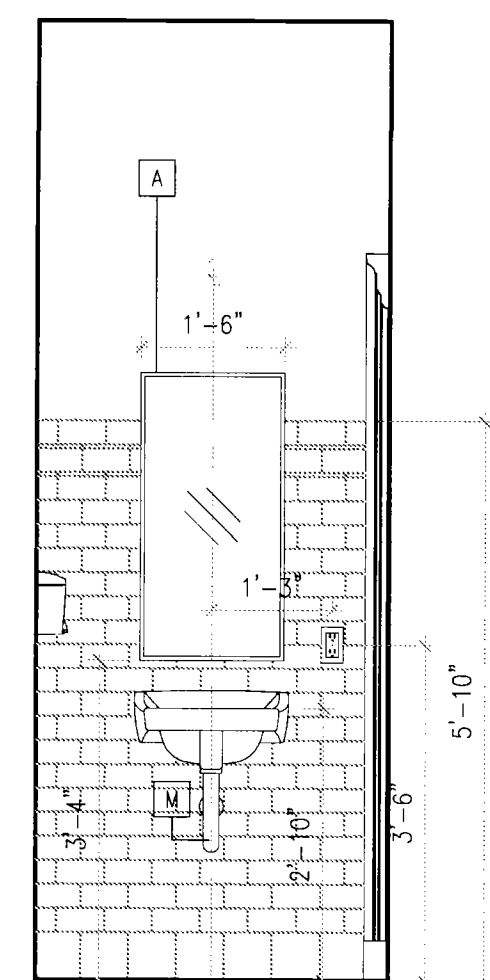


4 113C Toilet - South Elevation
 A421 1/2" = 1'-0"

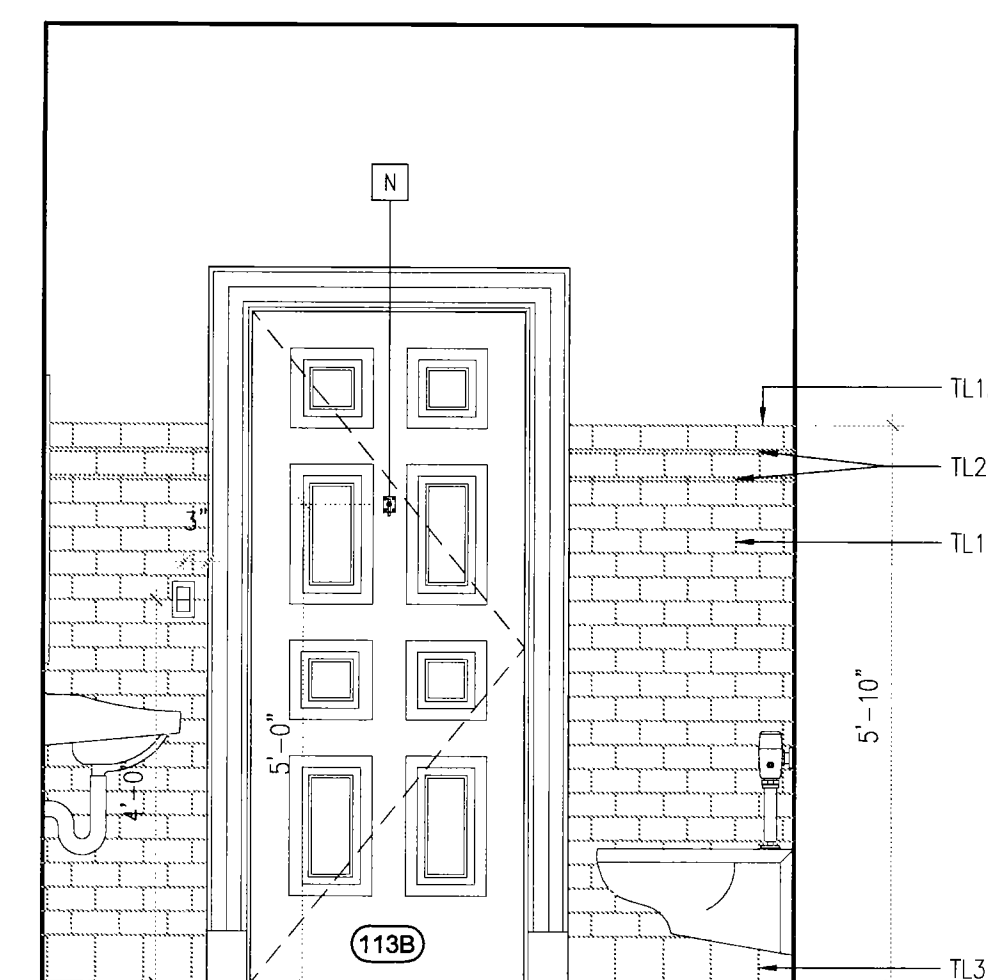


5 113C Toilet - West Elevation
 A421 1/2" = 1'-0"

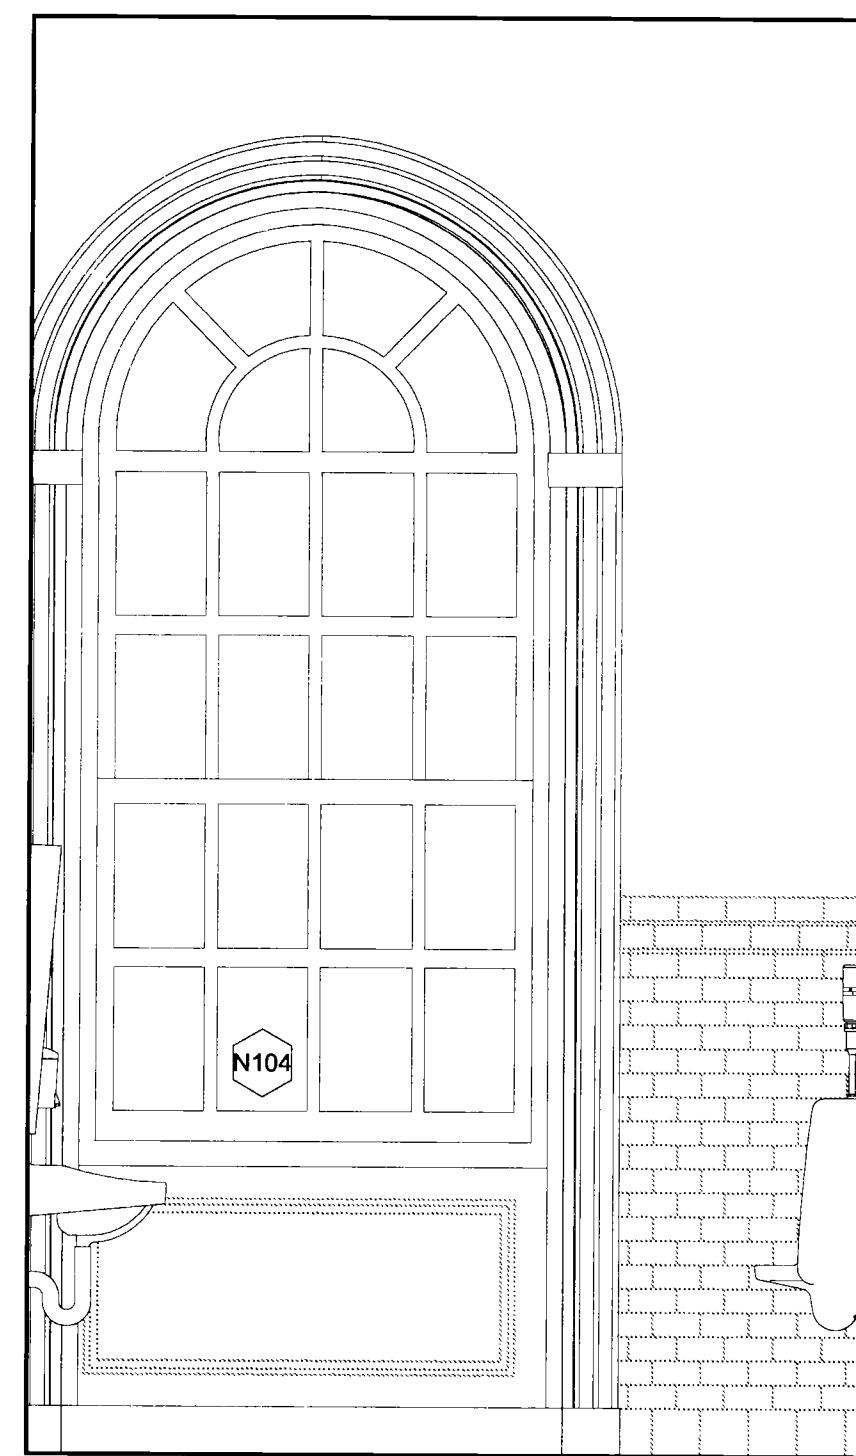


6 113B Toilet - North Elevation
 A421 1/2" = 1'-0"

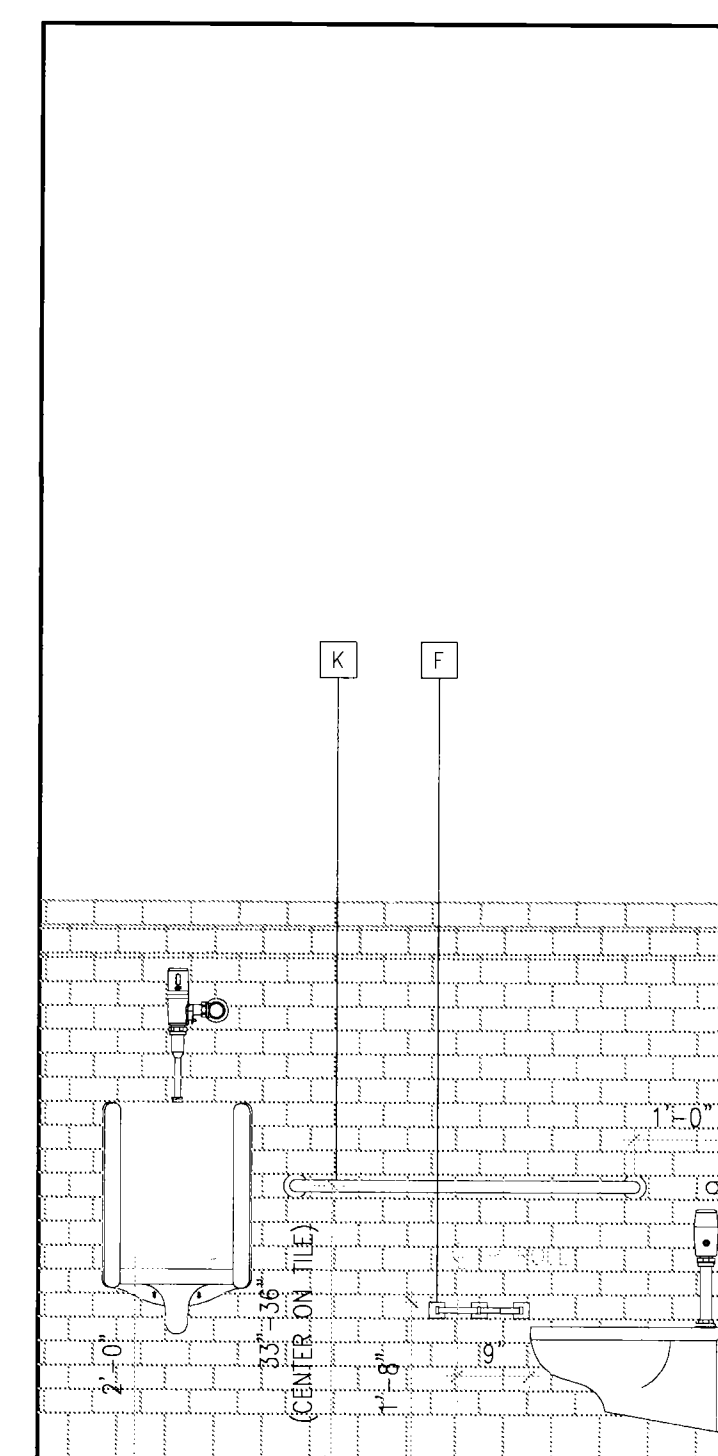


7 113B Toilet - East Elevation
 A421 1/2" = 1'-0"

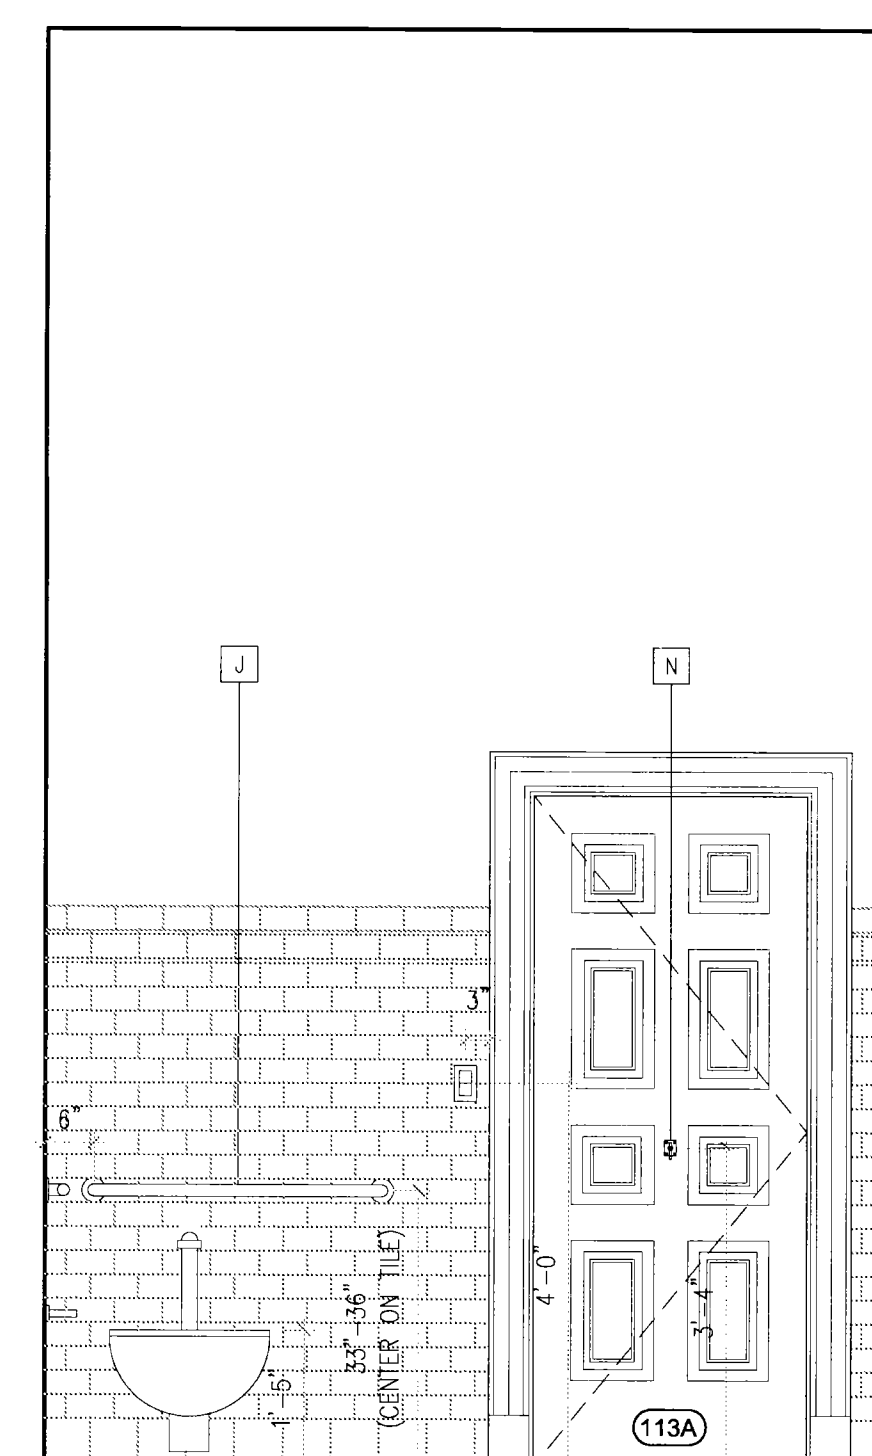


8 113B Toilet - South Elevation
 A421 1/2" = 1'-0"

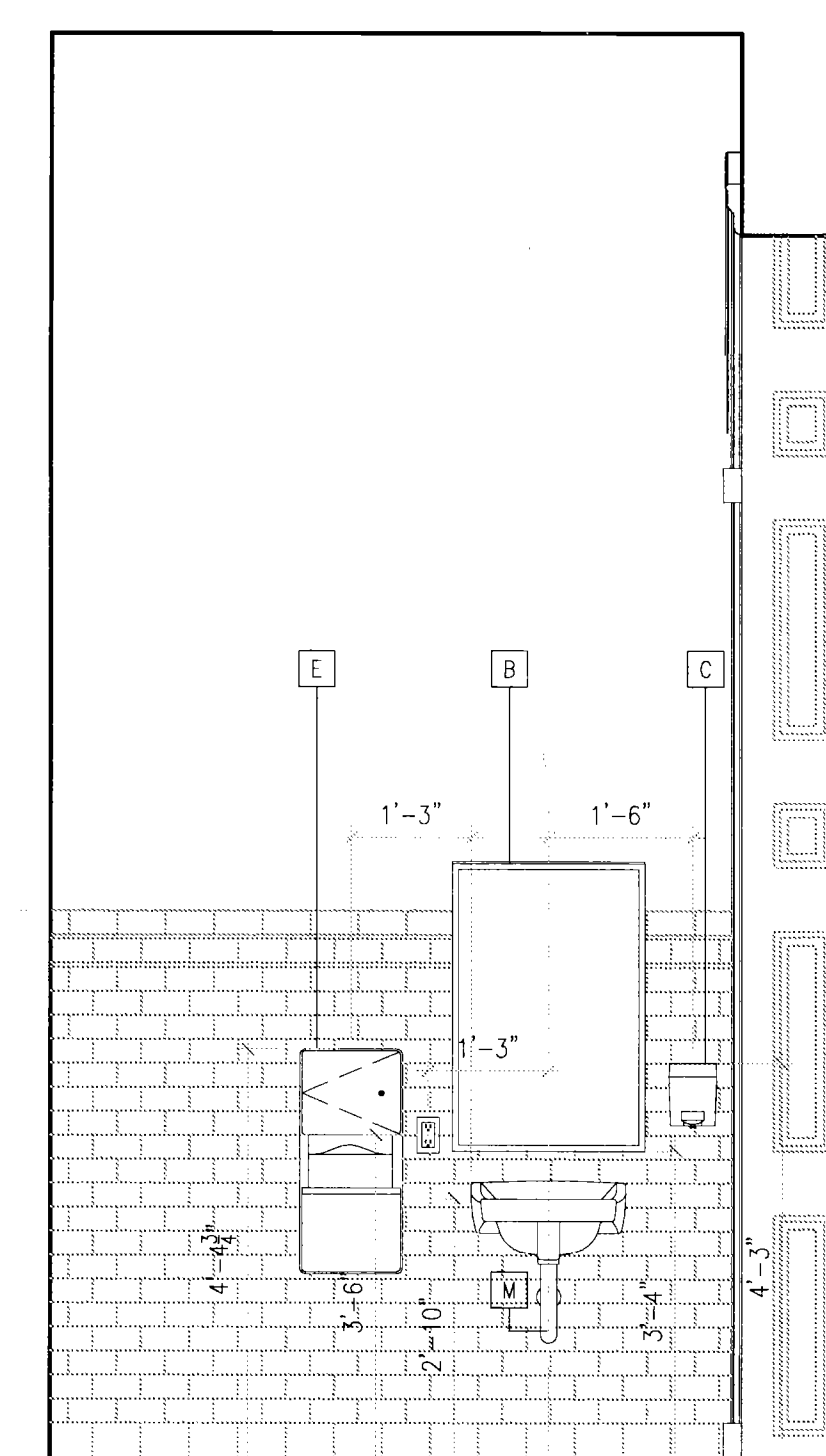


9 113B Toilet - West Elevation
 A421 1/2" = 1'-0"

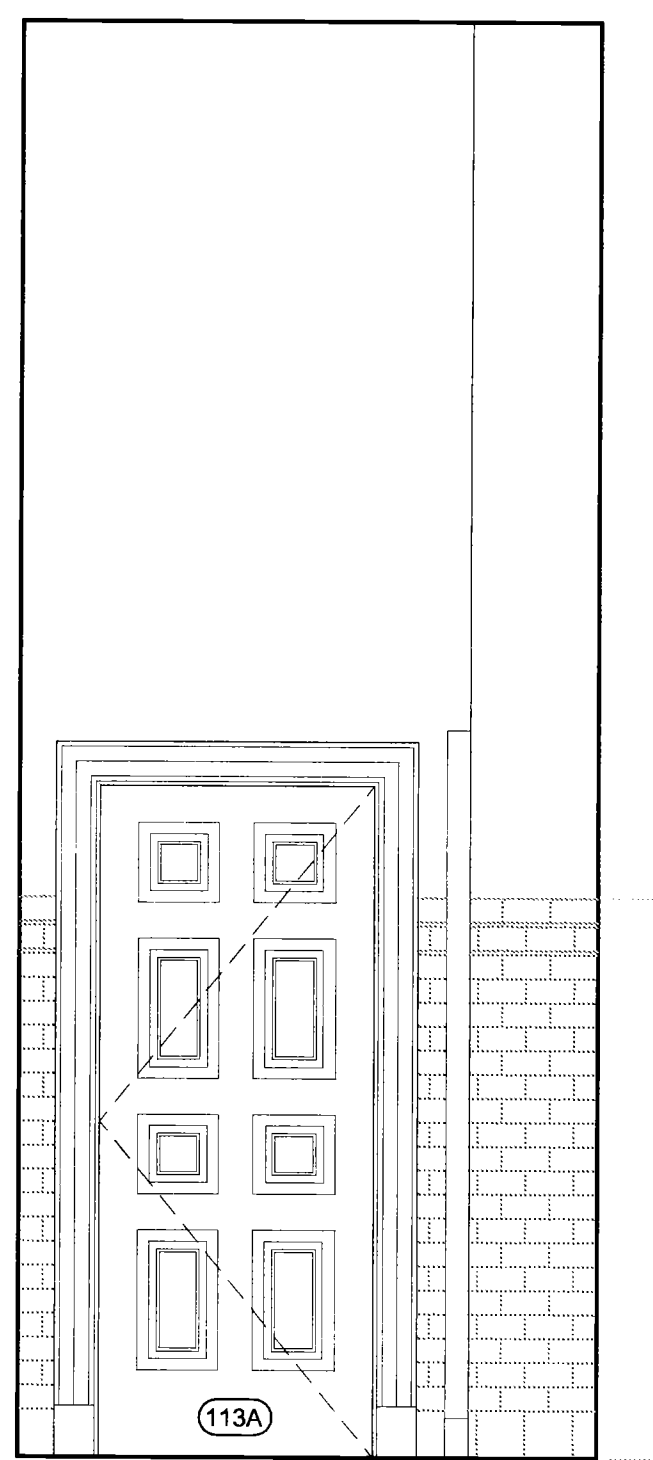


10 113 Vest - North Elevation
 A421 1/2" = 1'-0"

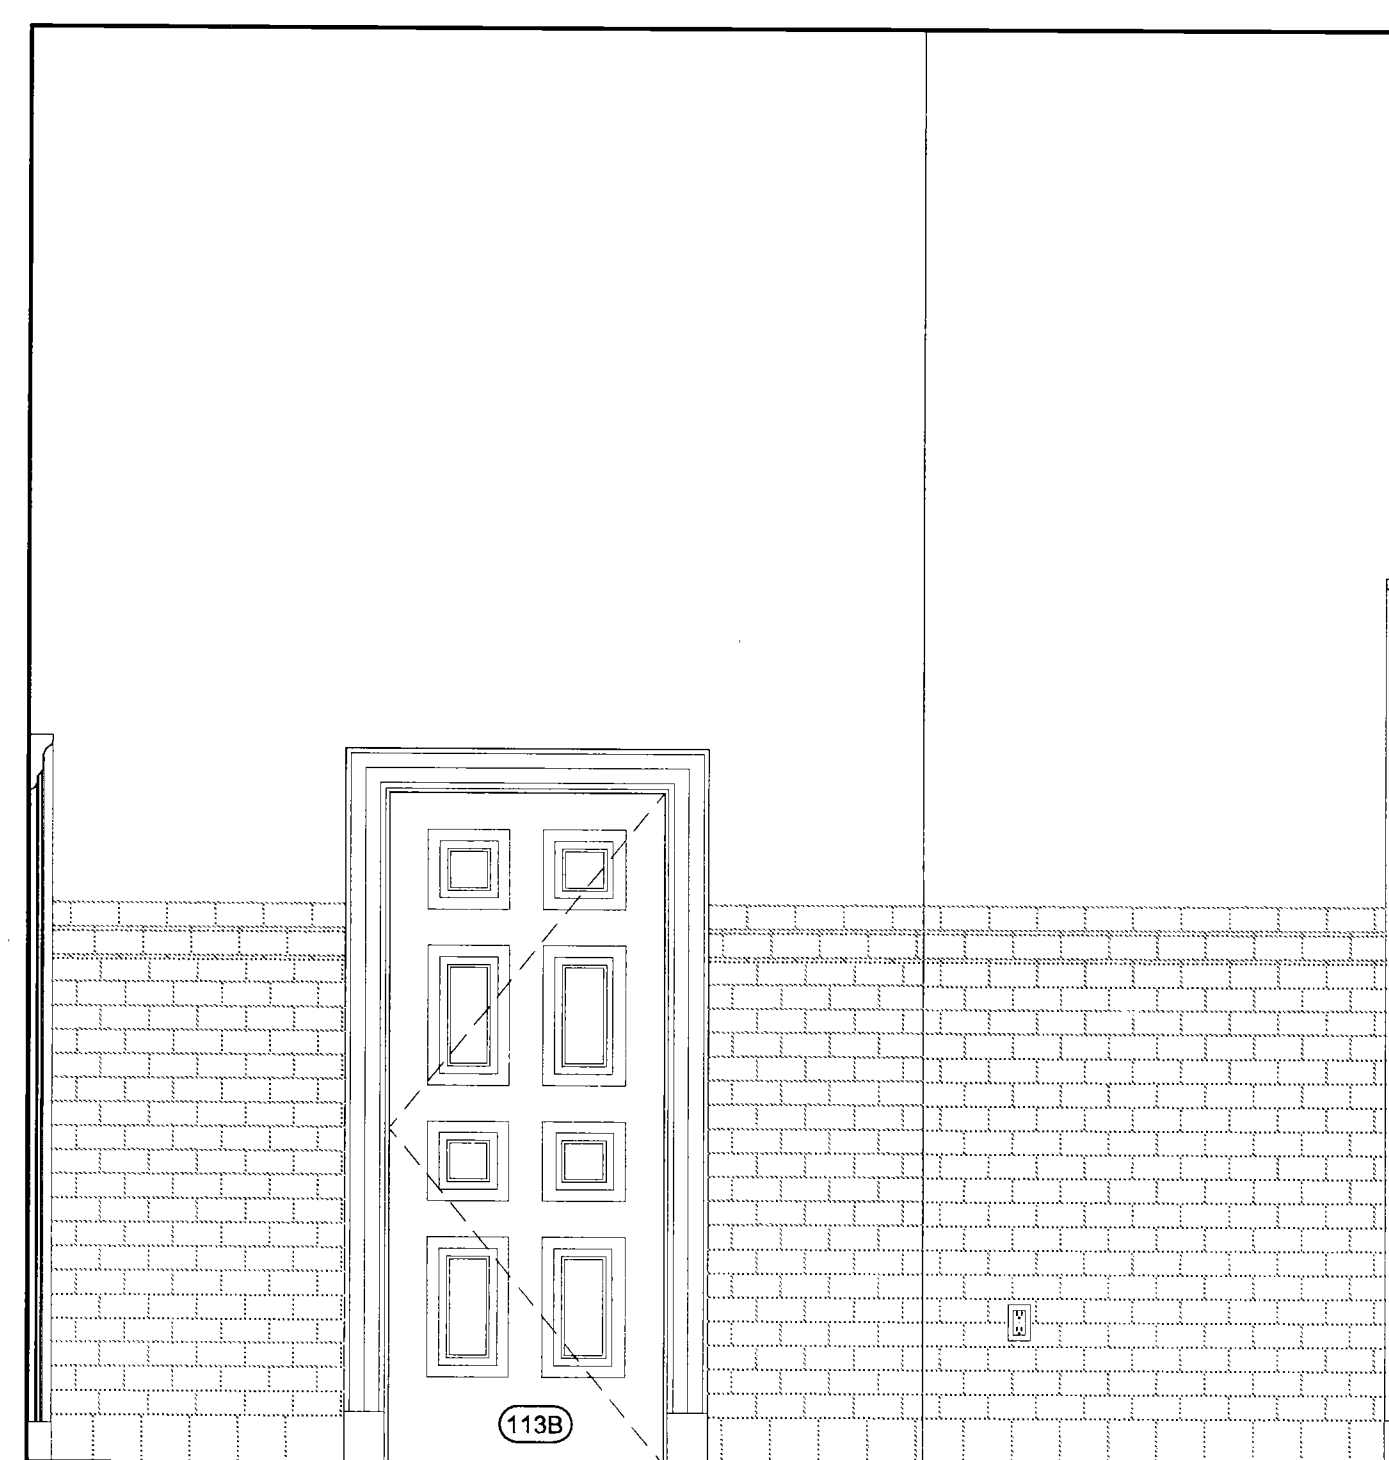

11 113 Vest - East Elevation
 A421 1/2" = 1'-0"

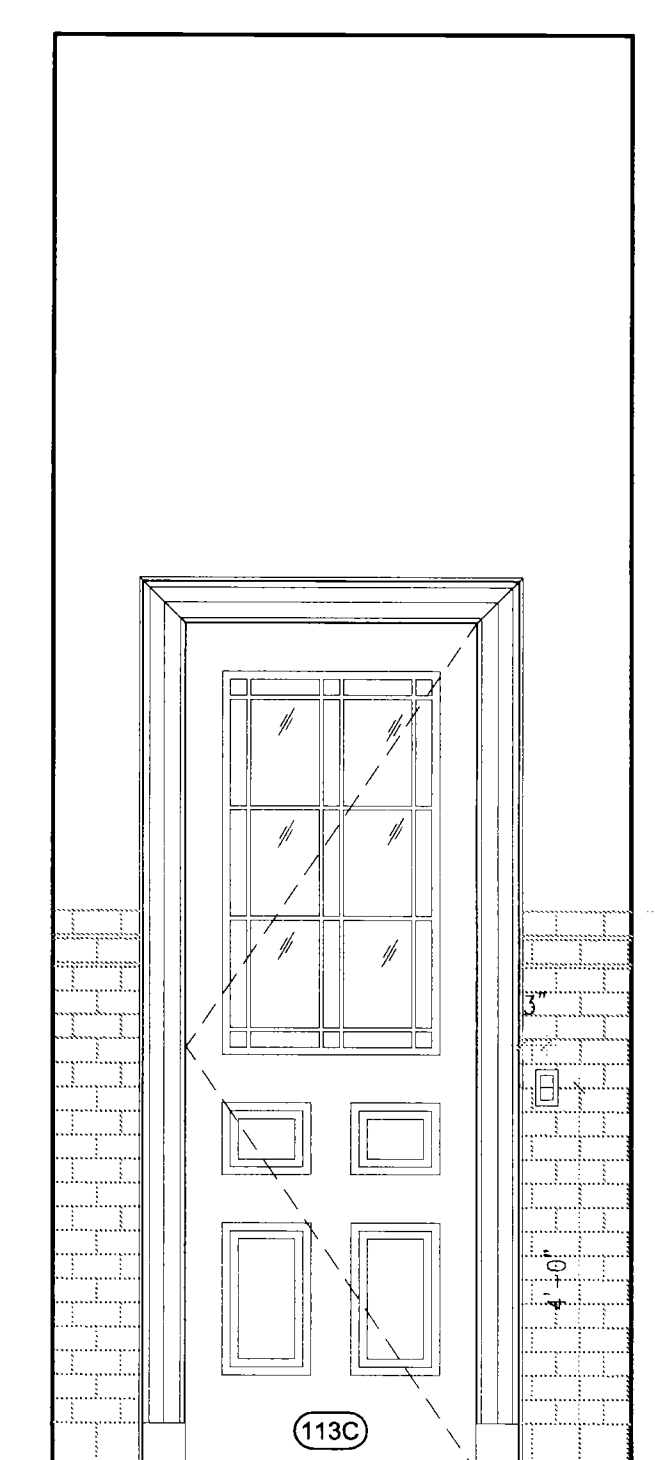

12 113 Vest - South Elevation
 A421 1/2" = 1'-0"

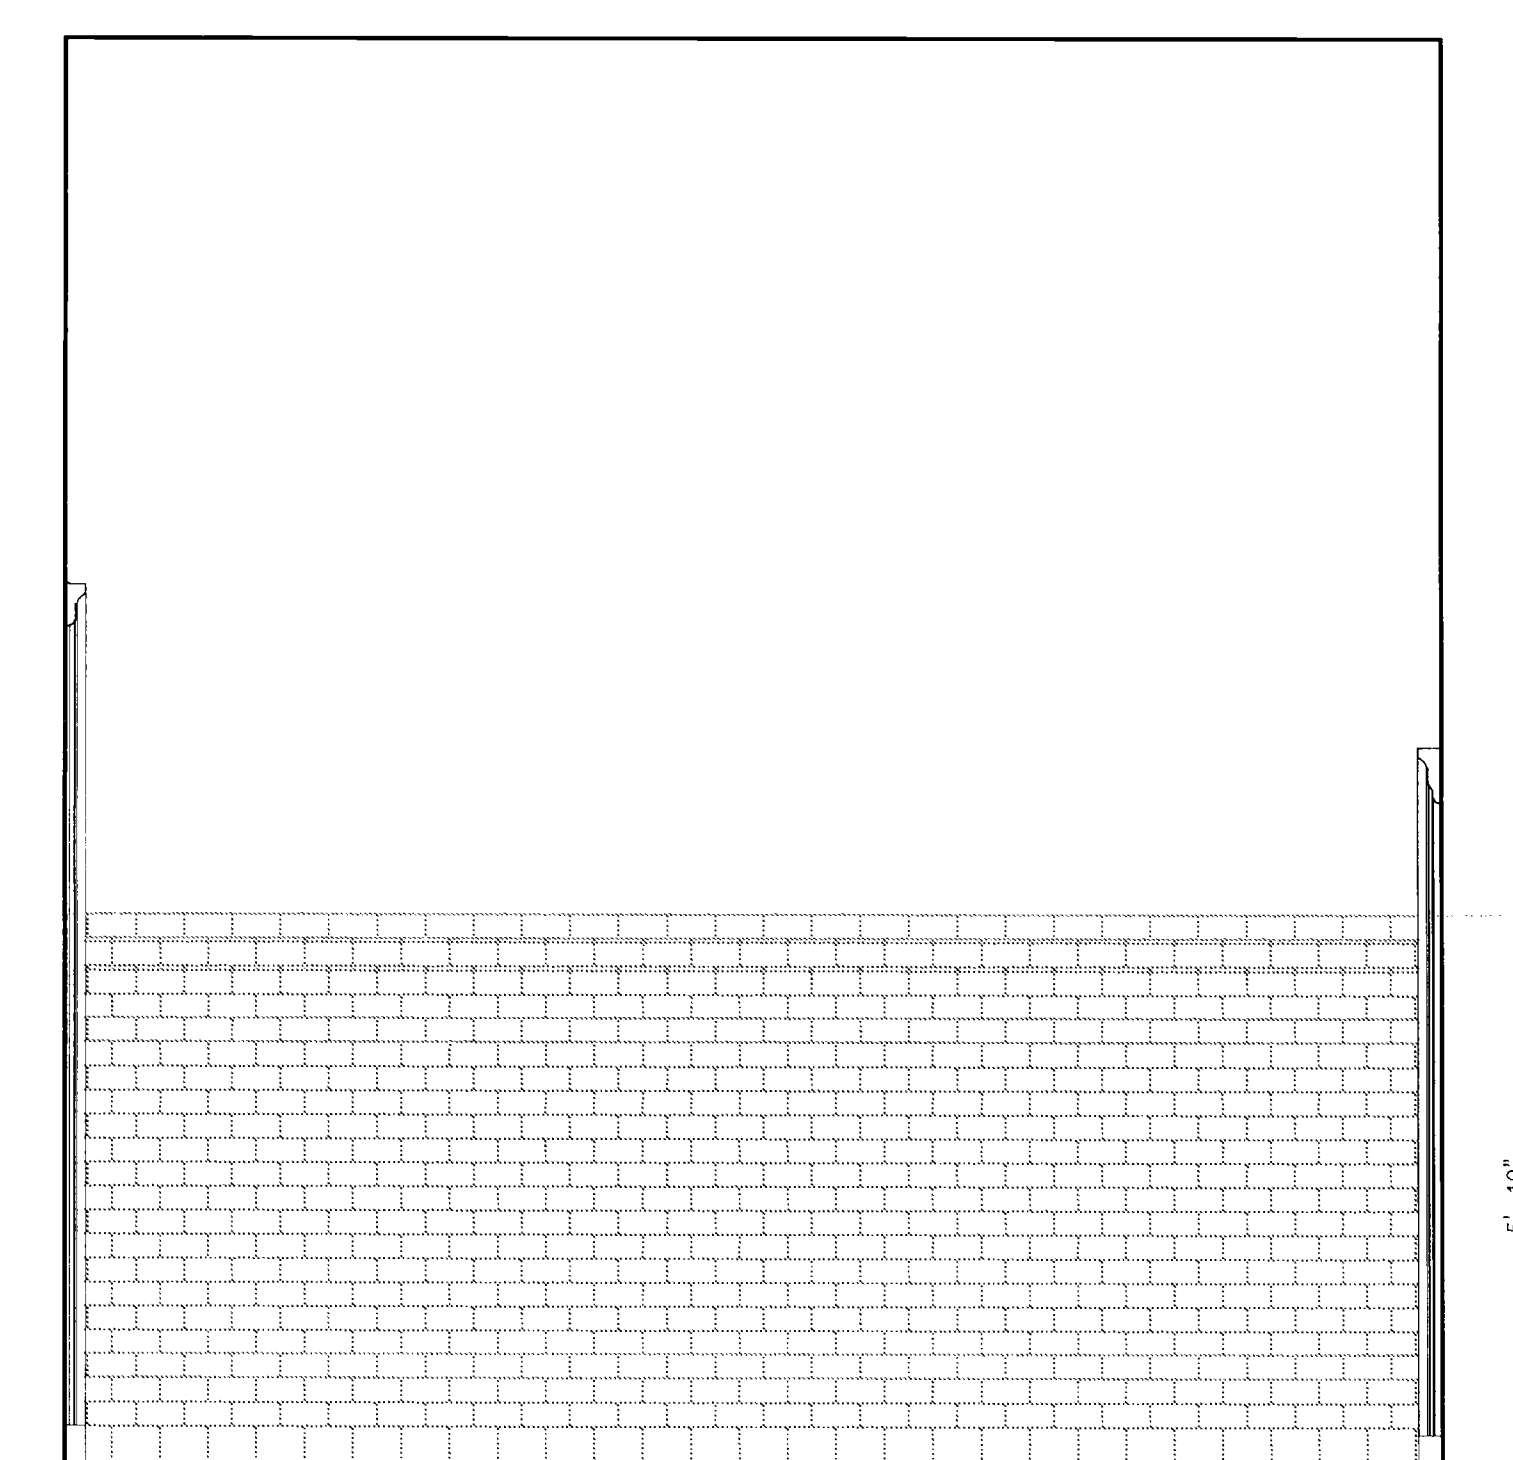

13 113 Vest - West Elevation
 A421 1/2" = 1'-0"

- ITEM DESCRIPTION
- A CHANNEL-FRAMED MIRROR
 - B TILT MIRROR
 - C SURFACE-MOUNTED SOAP DISPENSER
 - D SURFACE-MOUNTED PAPER TOWEL DISPENSER/WASTE RECEPTACLE (larger)
 - E SURFACE-MOUNTED PAPER TOWEL DISPENSER/WASTE RECEPTACLE (smaller)
 - F DOUBLE-ROLL STAINLESS STEEL TOILET TISSUE DISPENSER
 - G SURFACE-MOUNTED NAPKIN/TAMPON VENDOR
 - H SURFACE-MOUNTED NAPKIN/TAMPON DISPOSAL
 - J 1 1/2" DIAMETER STAINLESS STEEL GRAB BAR WITH SNAP FLANGE (36" long)
 - K 1 1/2" DIAMETER STAINLESS STEEL GRAB BAR WITH SNAP FLANGE (42" long)
 - L TOWEL HOOK
 - M UNDERLAVATORY GUARD
 - N COAT HOOK

SEAL:

REVISIONS:

NUMBER	DESCRIPTION	DATE



DIVISION OF STRUCTURES
 BUREAU OF ARCHITECTURE &
 ENGINEERING

CAPITAL PROJECT NUMBER:

PROJECT NAME:
 Renovation of City Hall
 Bid Package 2

FOR THE:

DRAWING TITLE:

**Enlarged Toilet
 Plans and
 Elevations - 1**

DRAWN BY: KL SCALE: 1/2"=1'-0"

CHECKED BY: NA DATE: 10.08.10













DRAWING NUMBER:

A-421.00

SHEET NUMBER:
 21 OF 42



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SEAL:

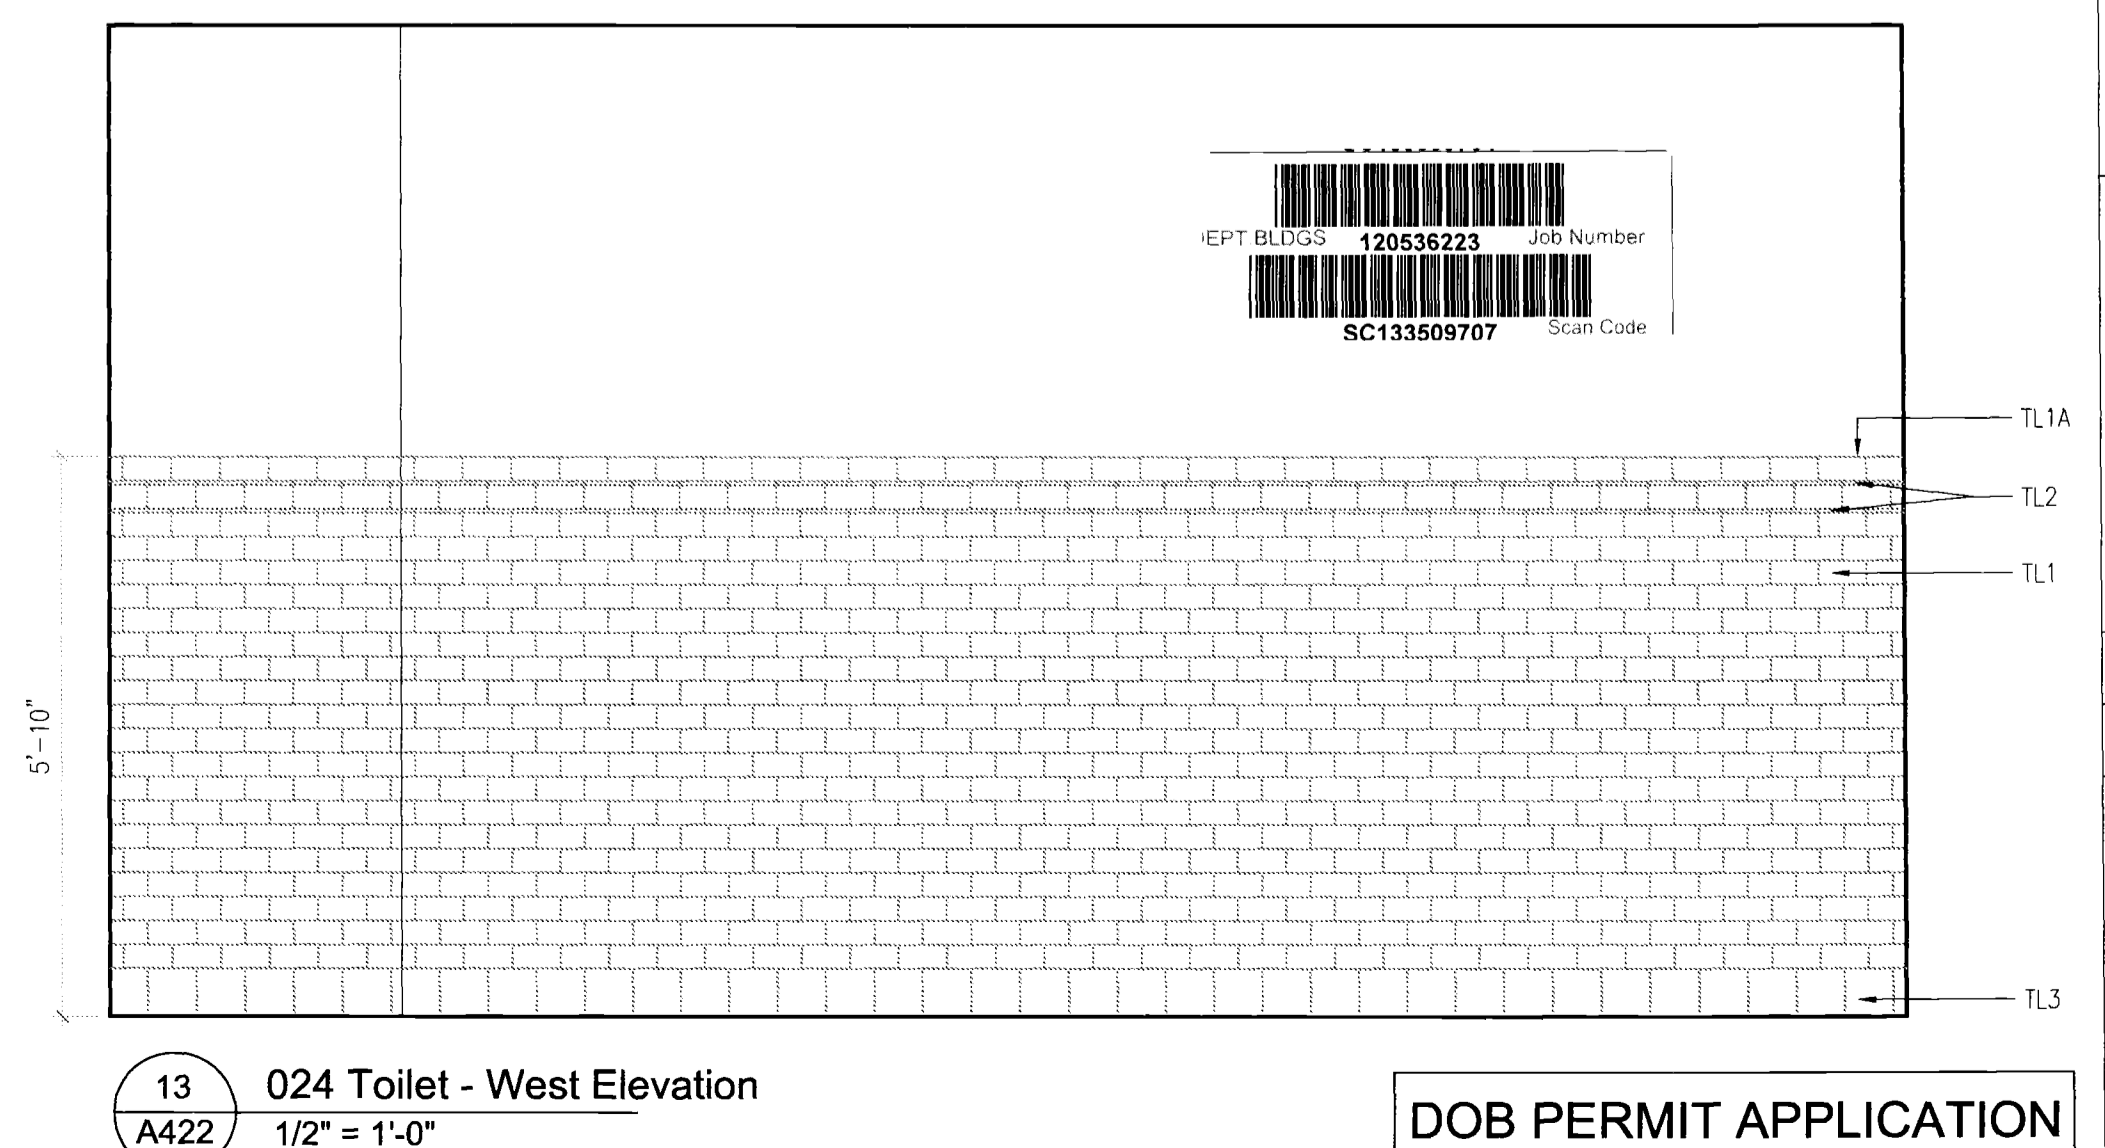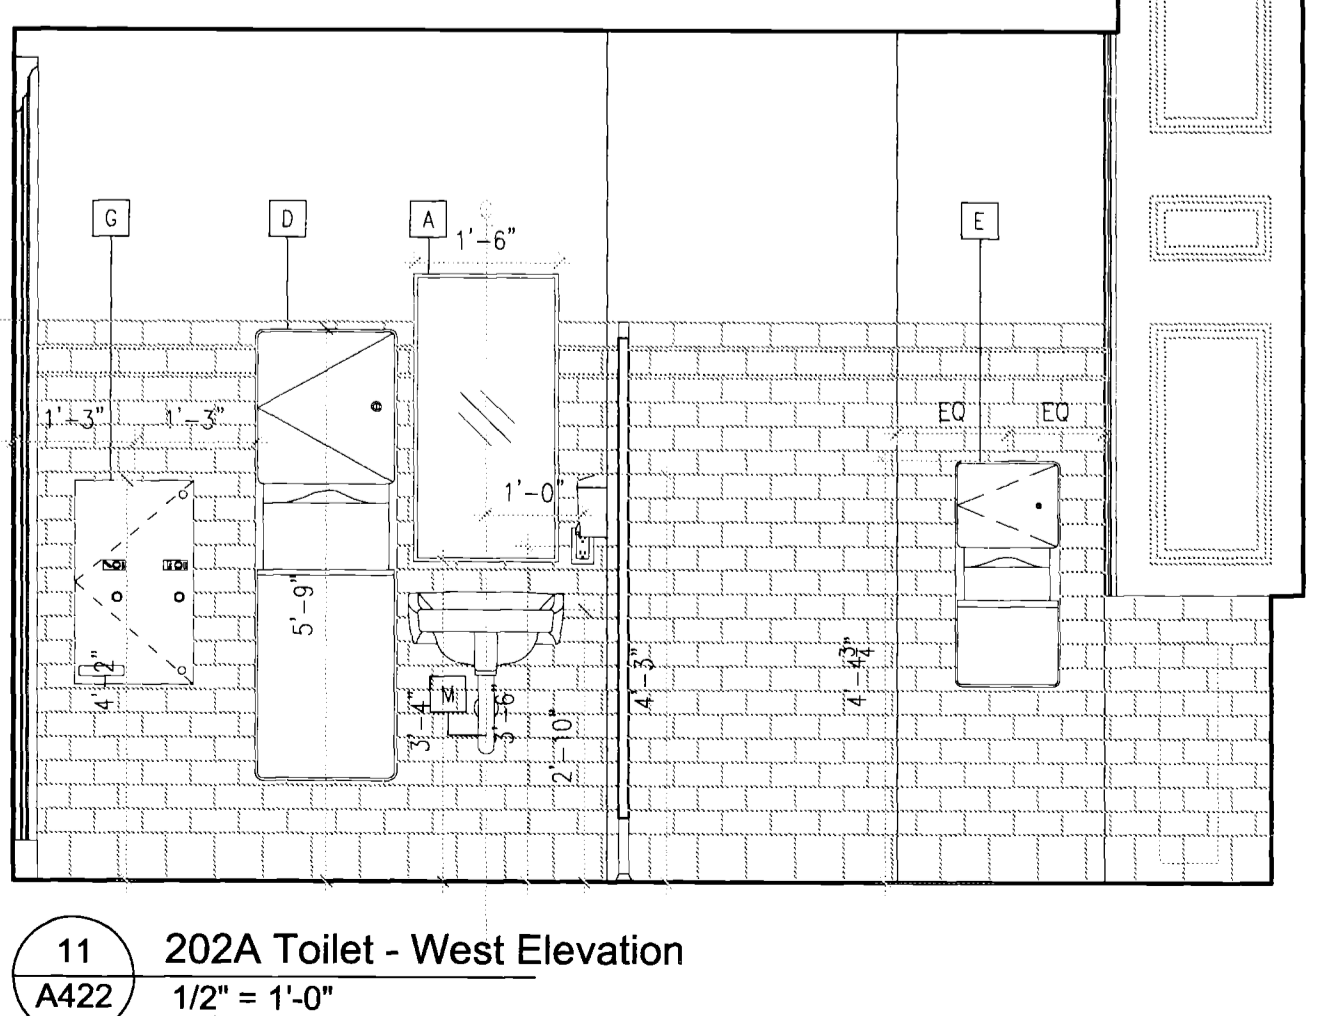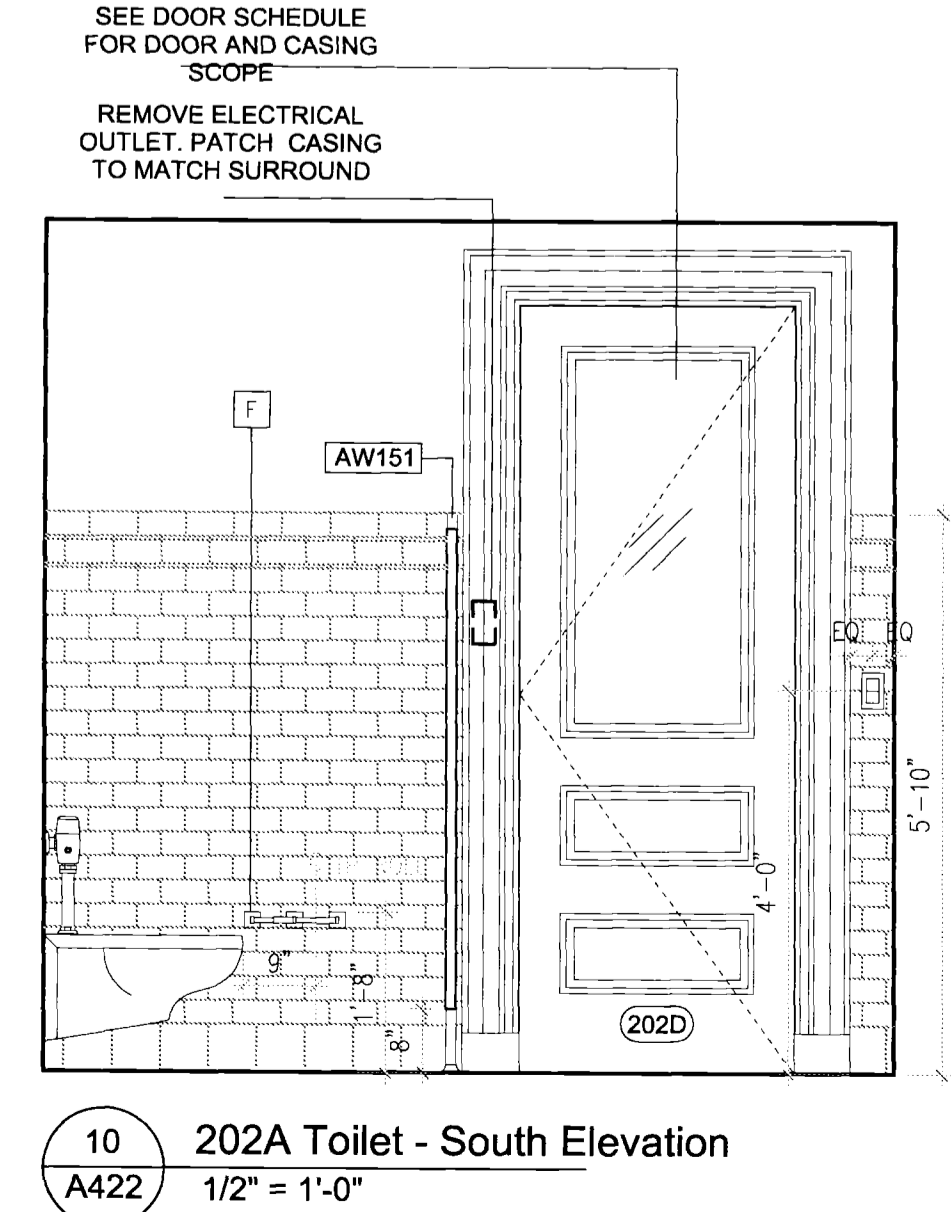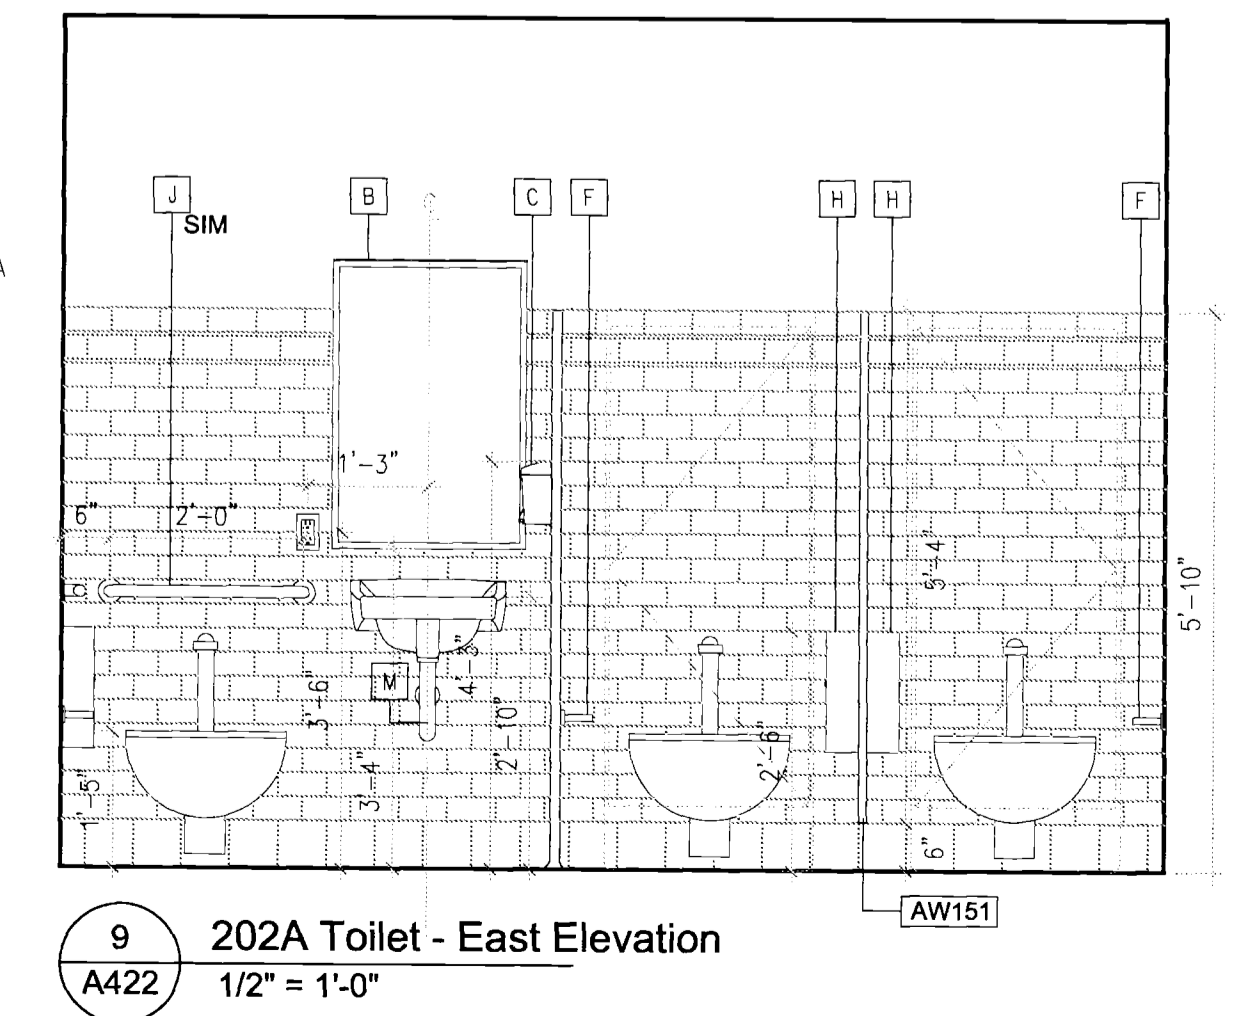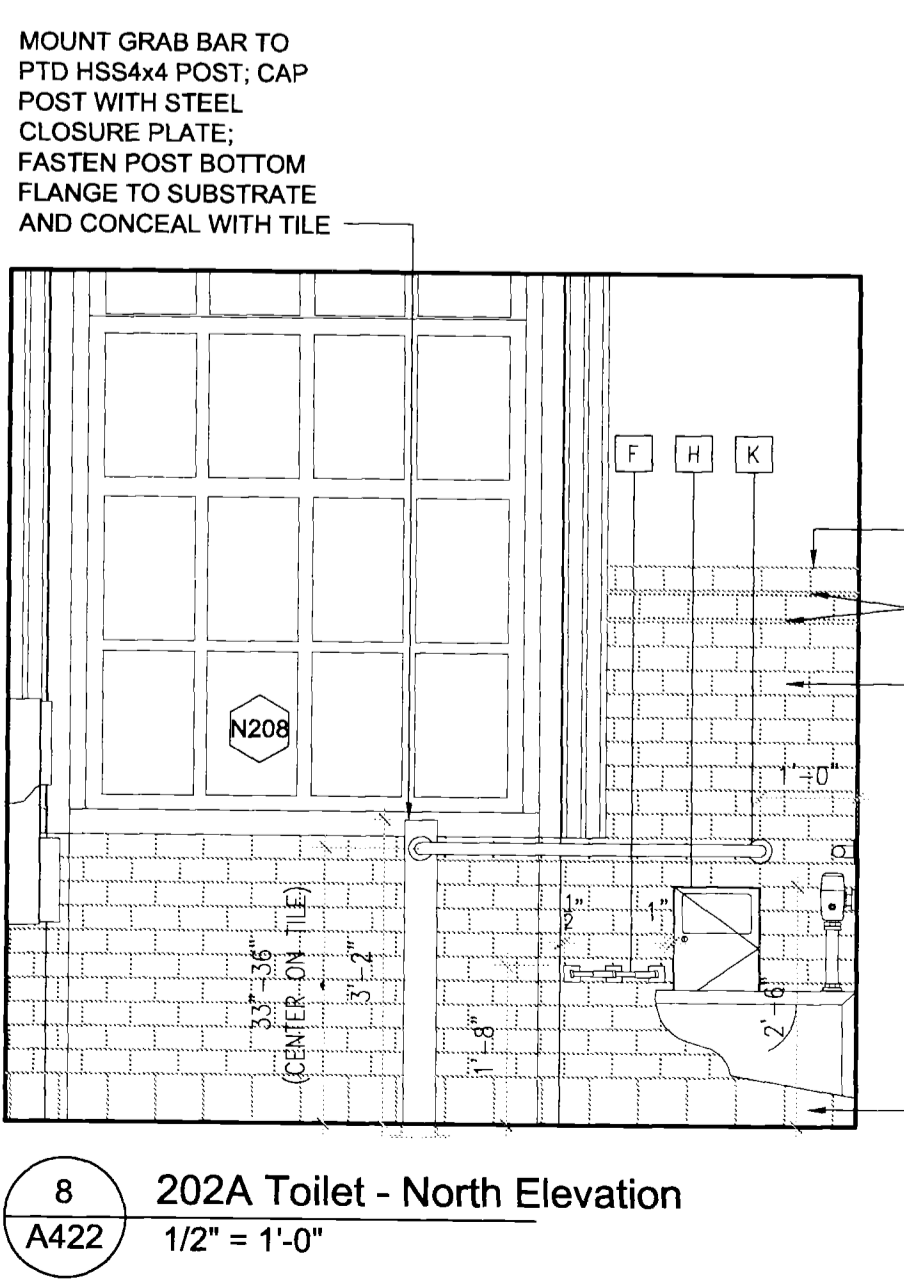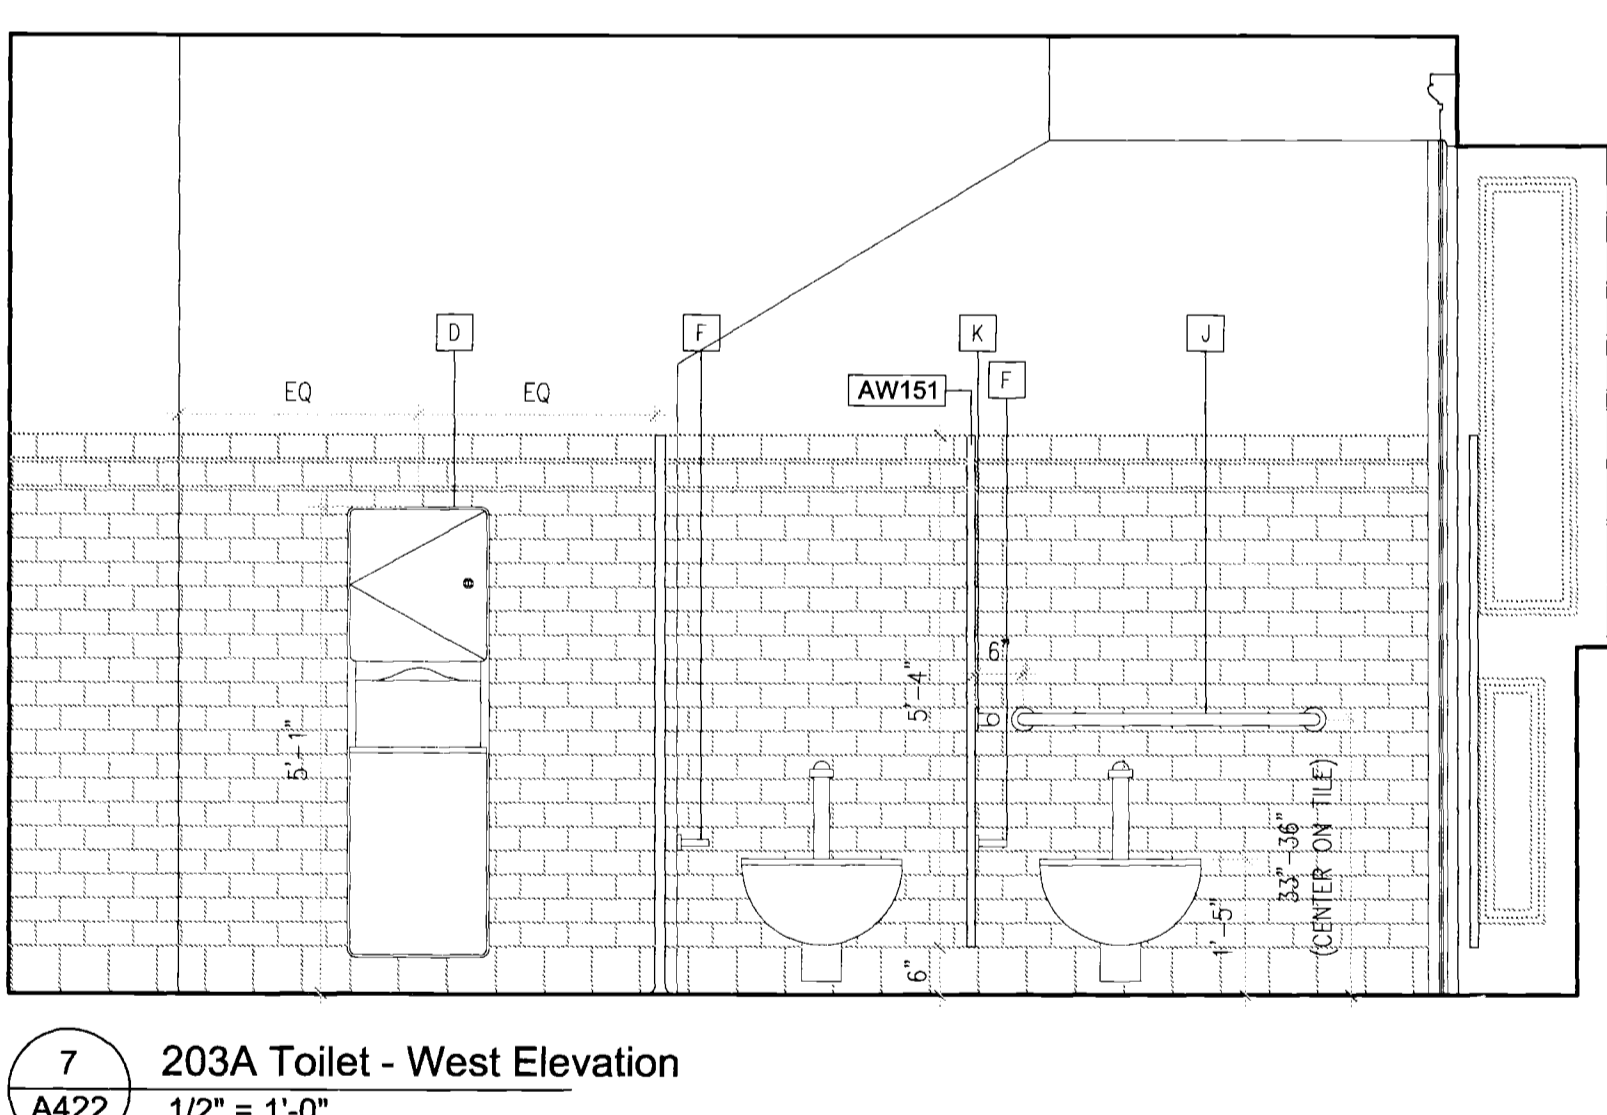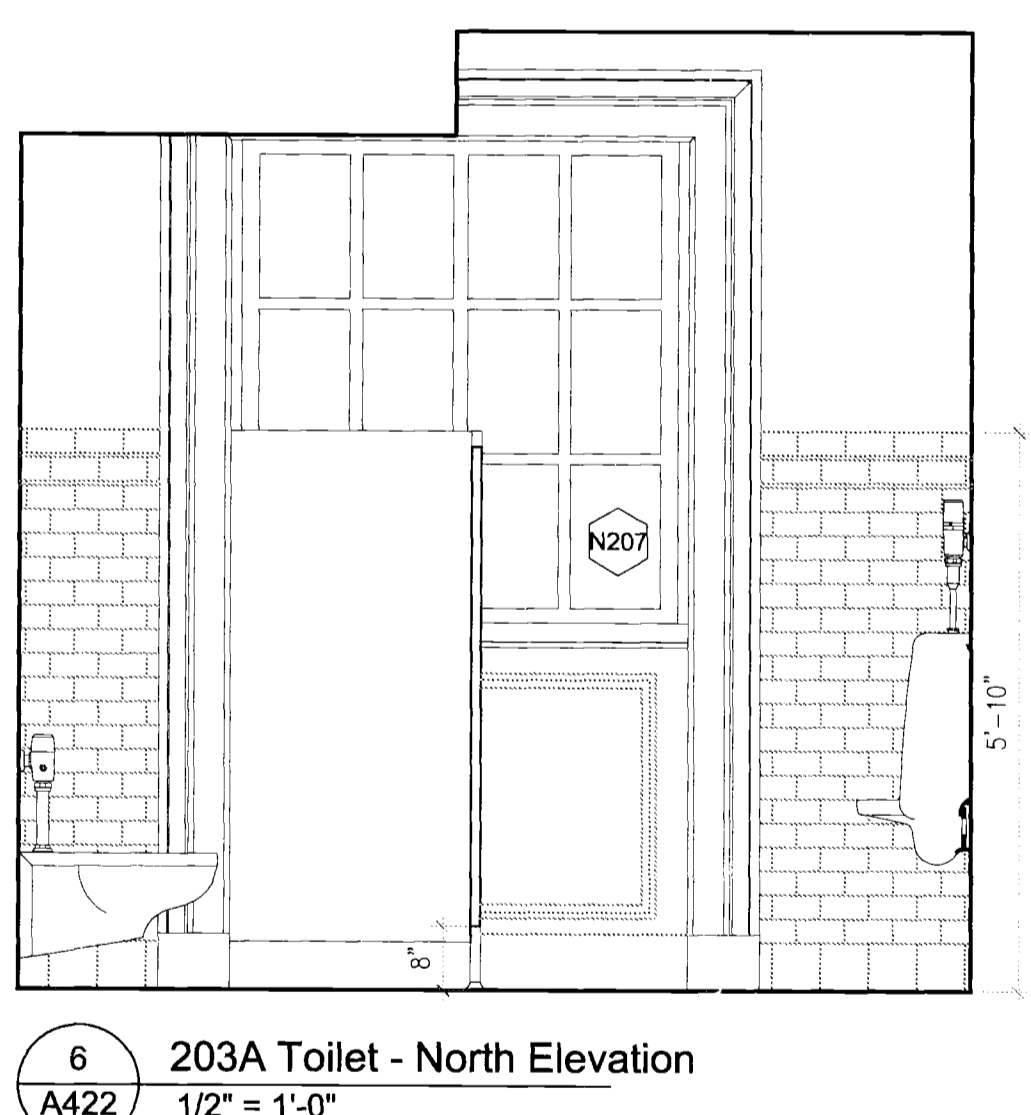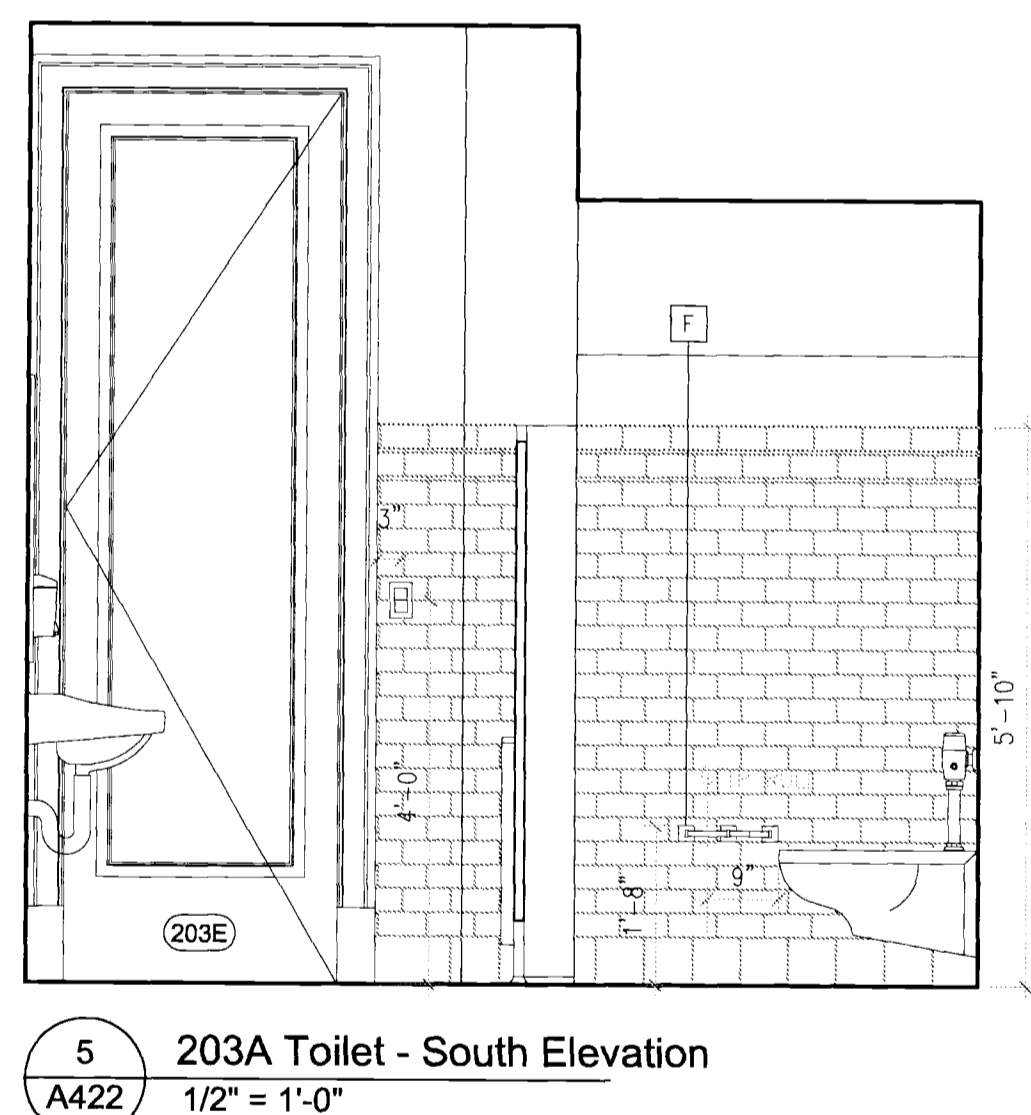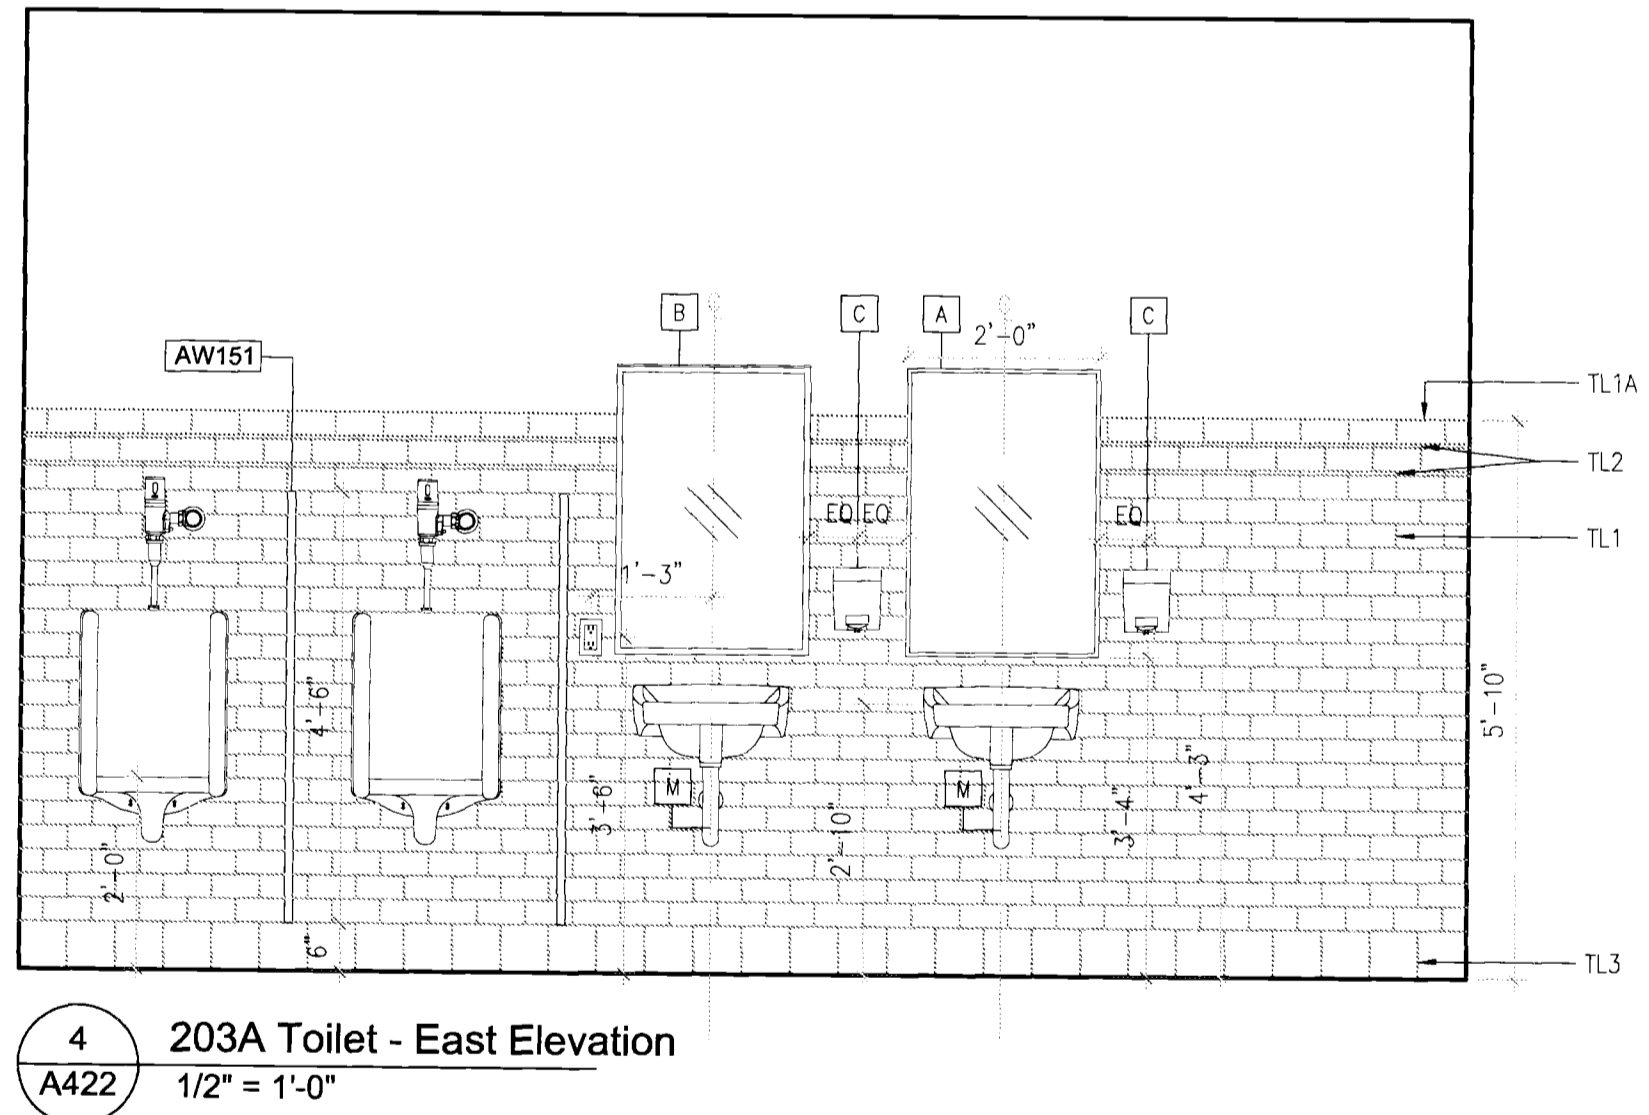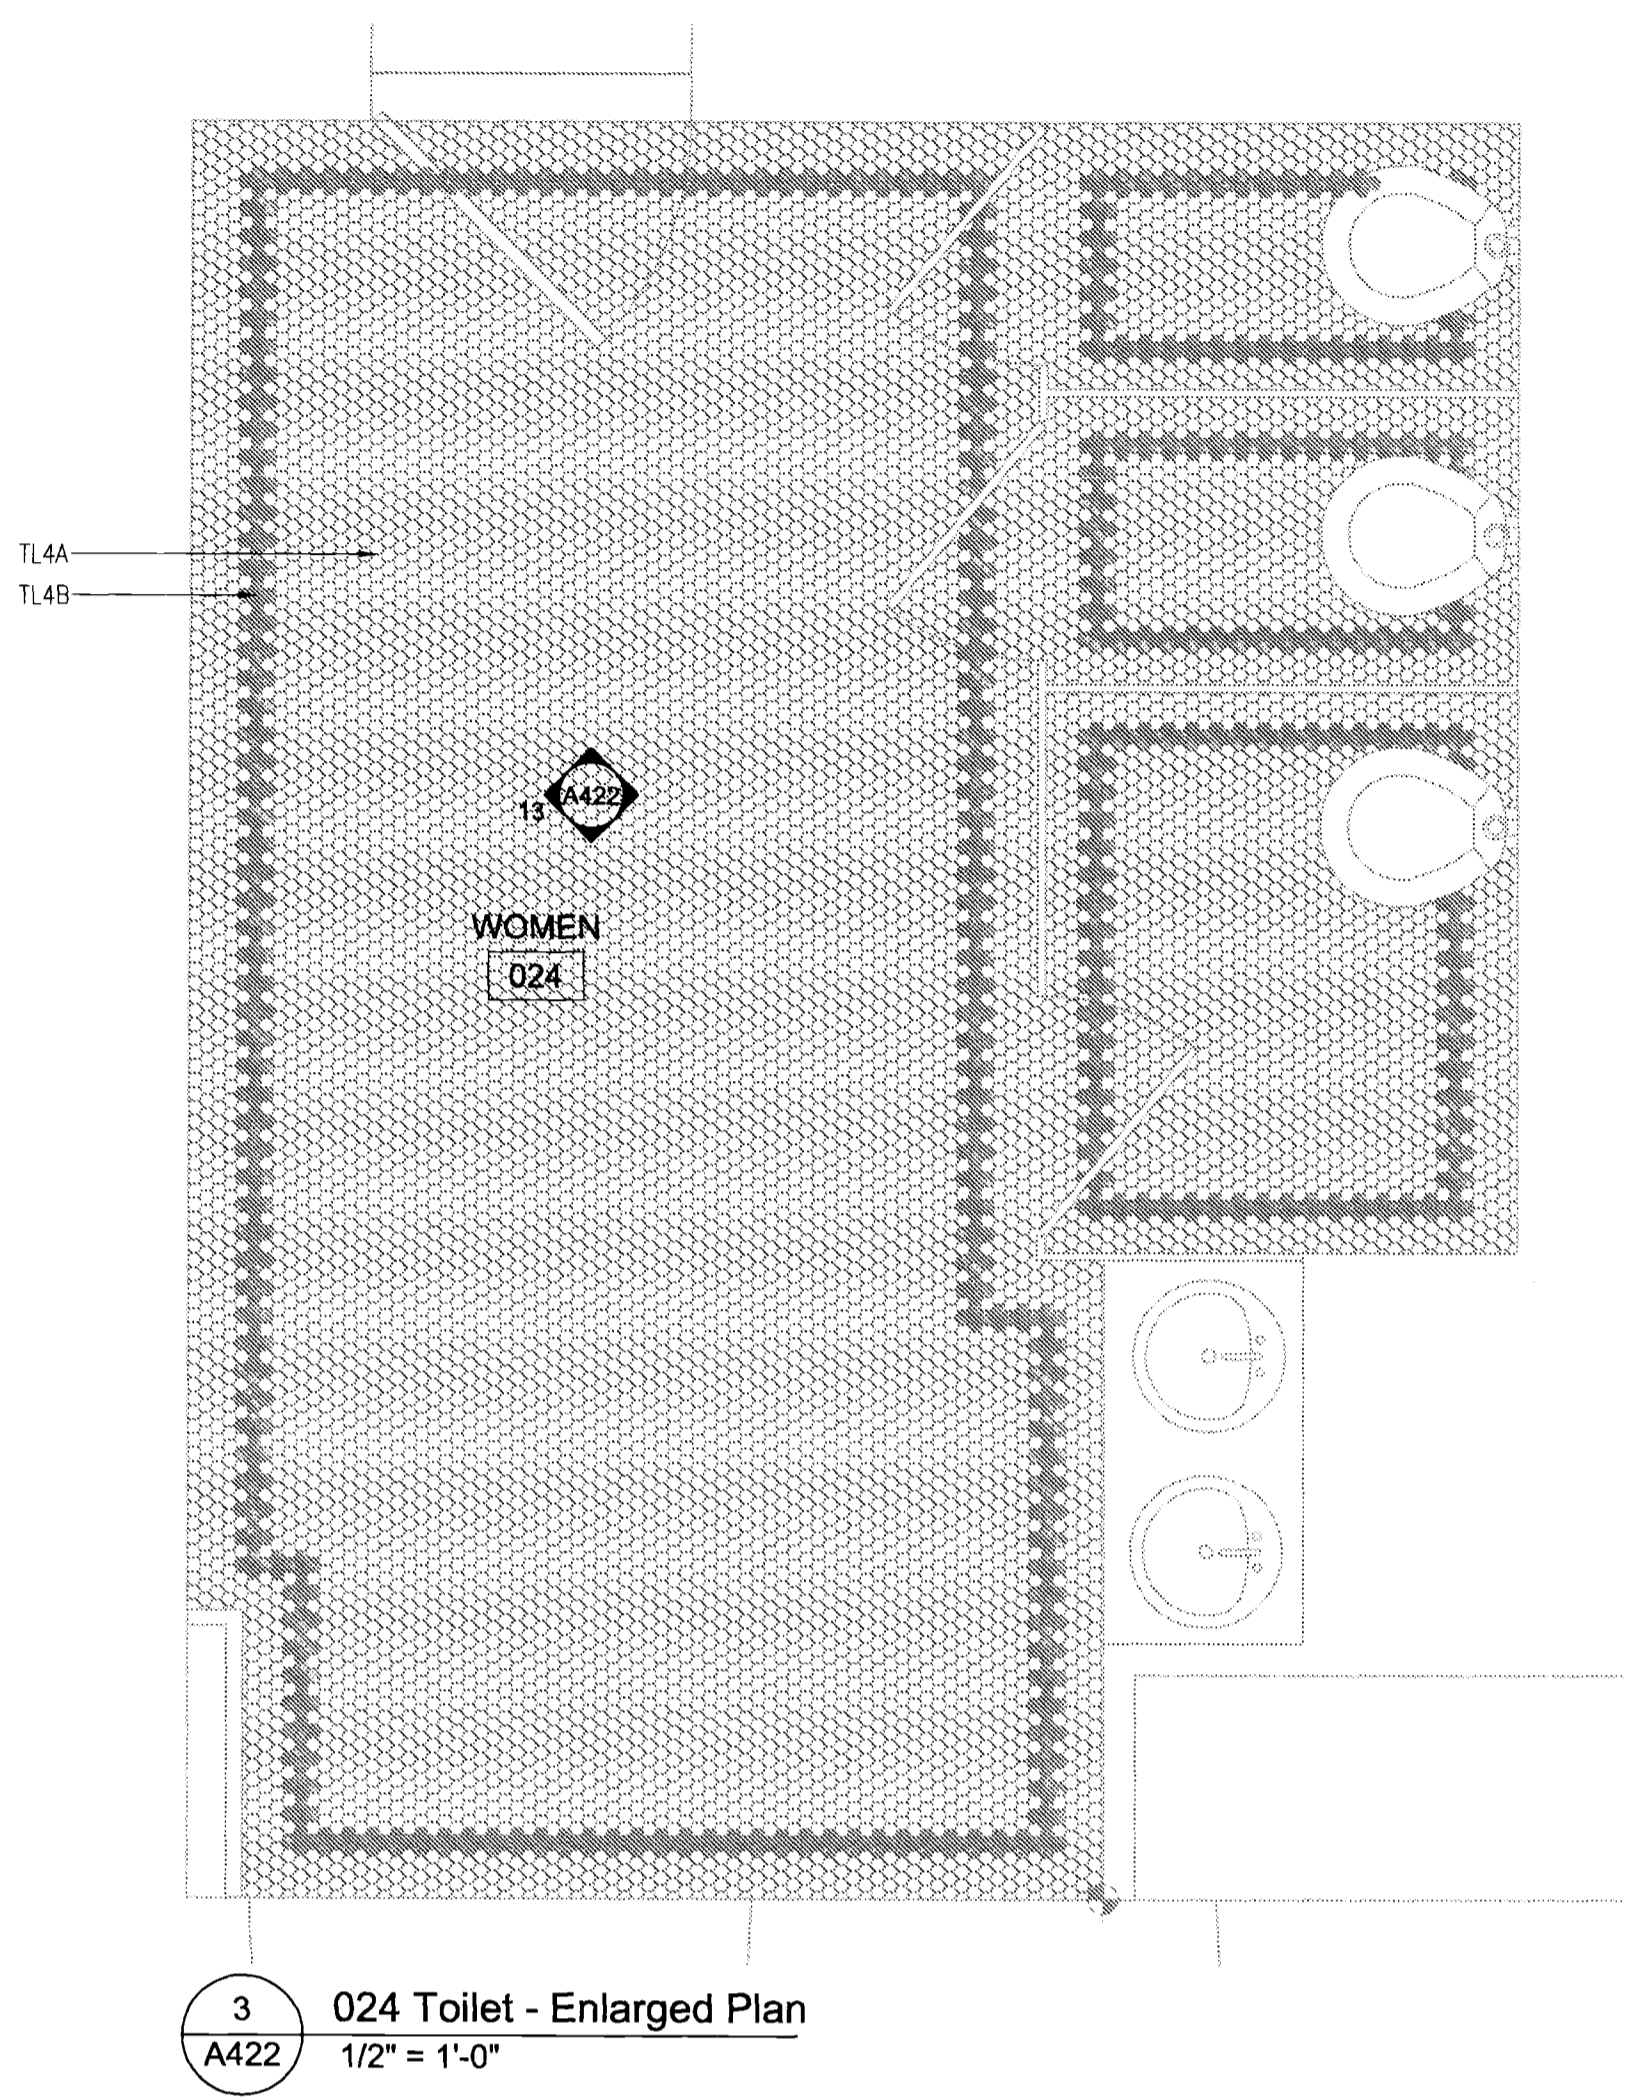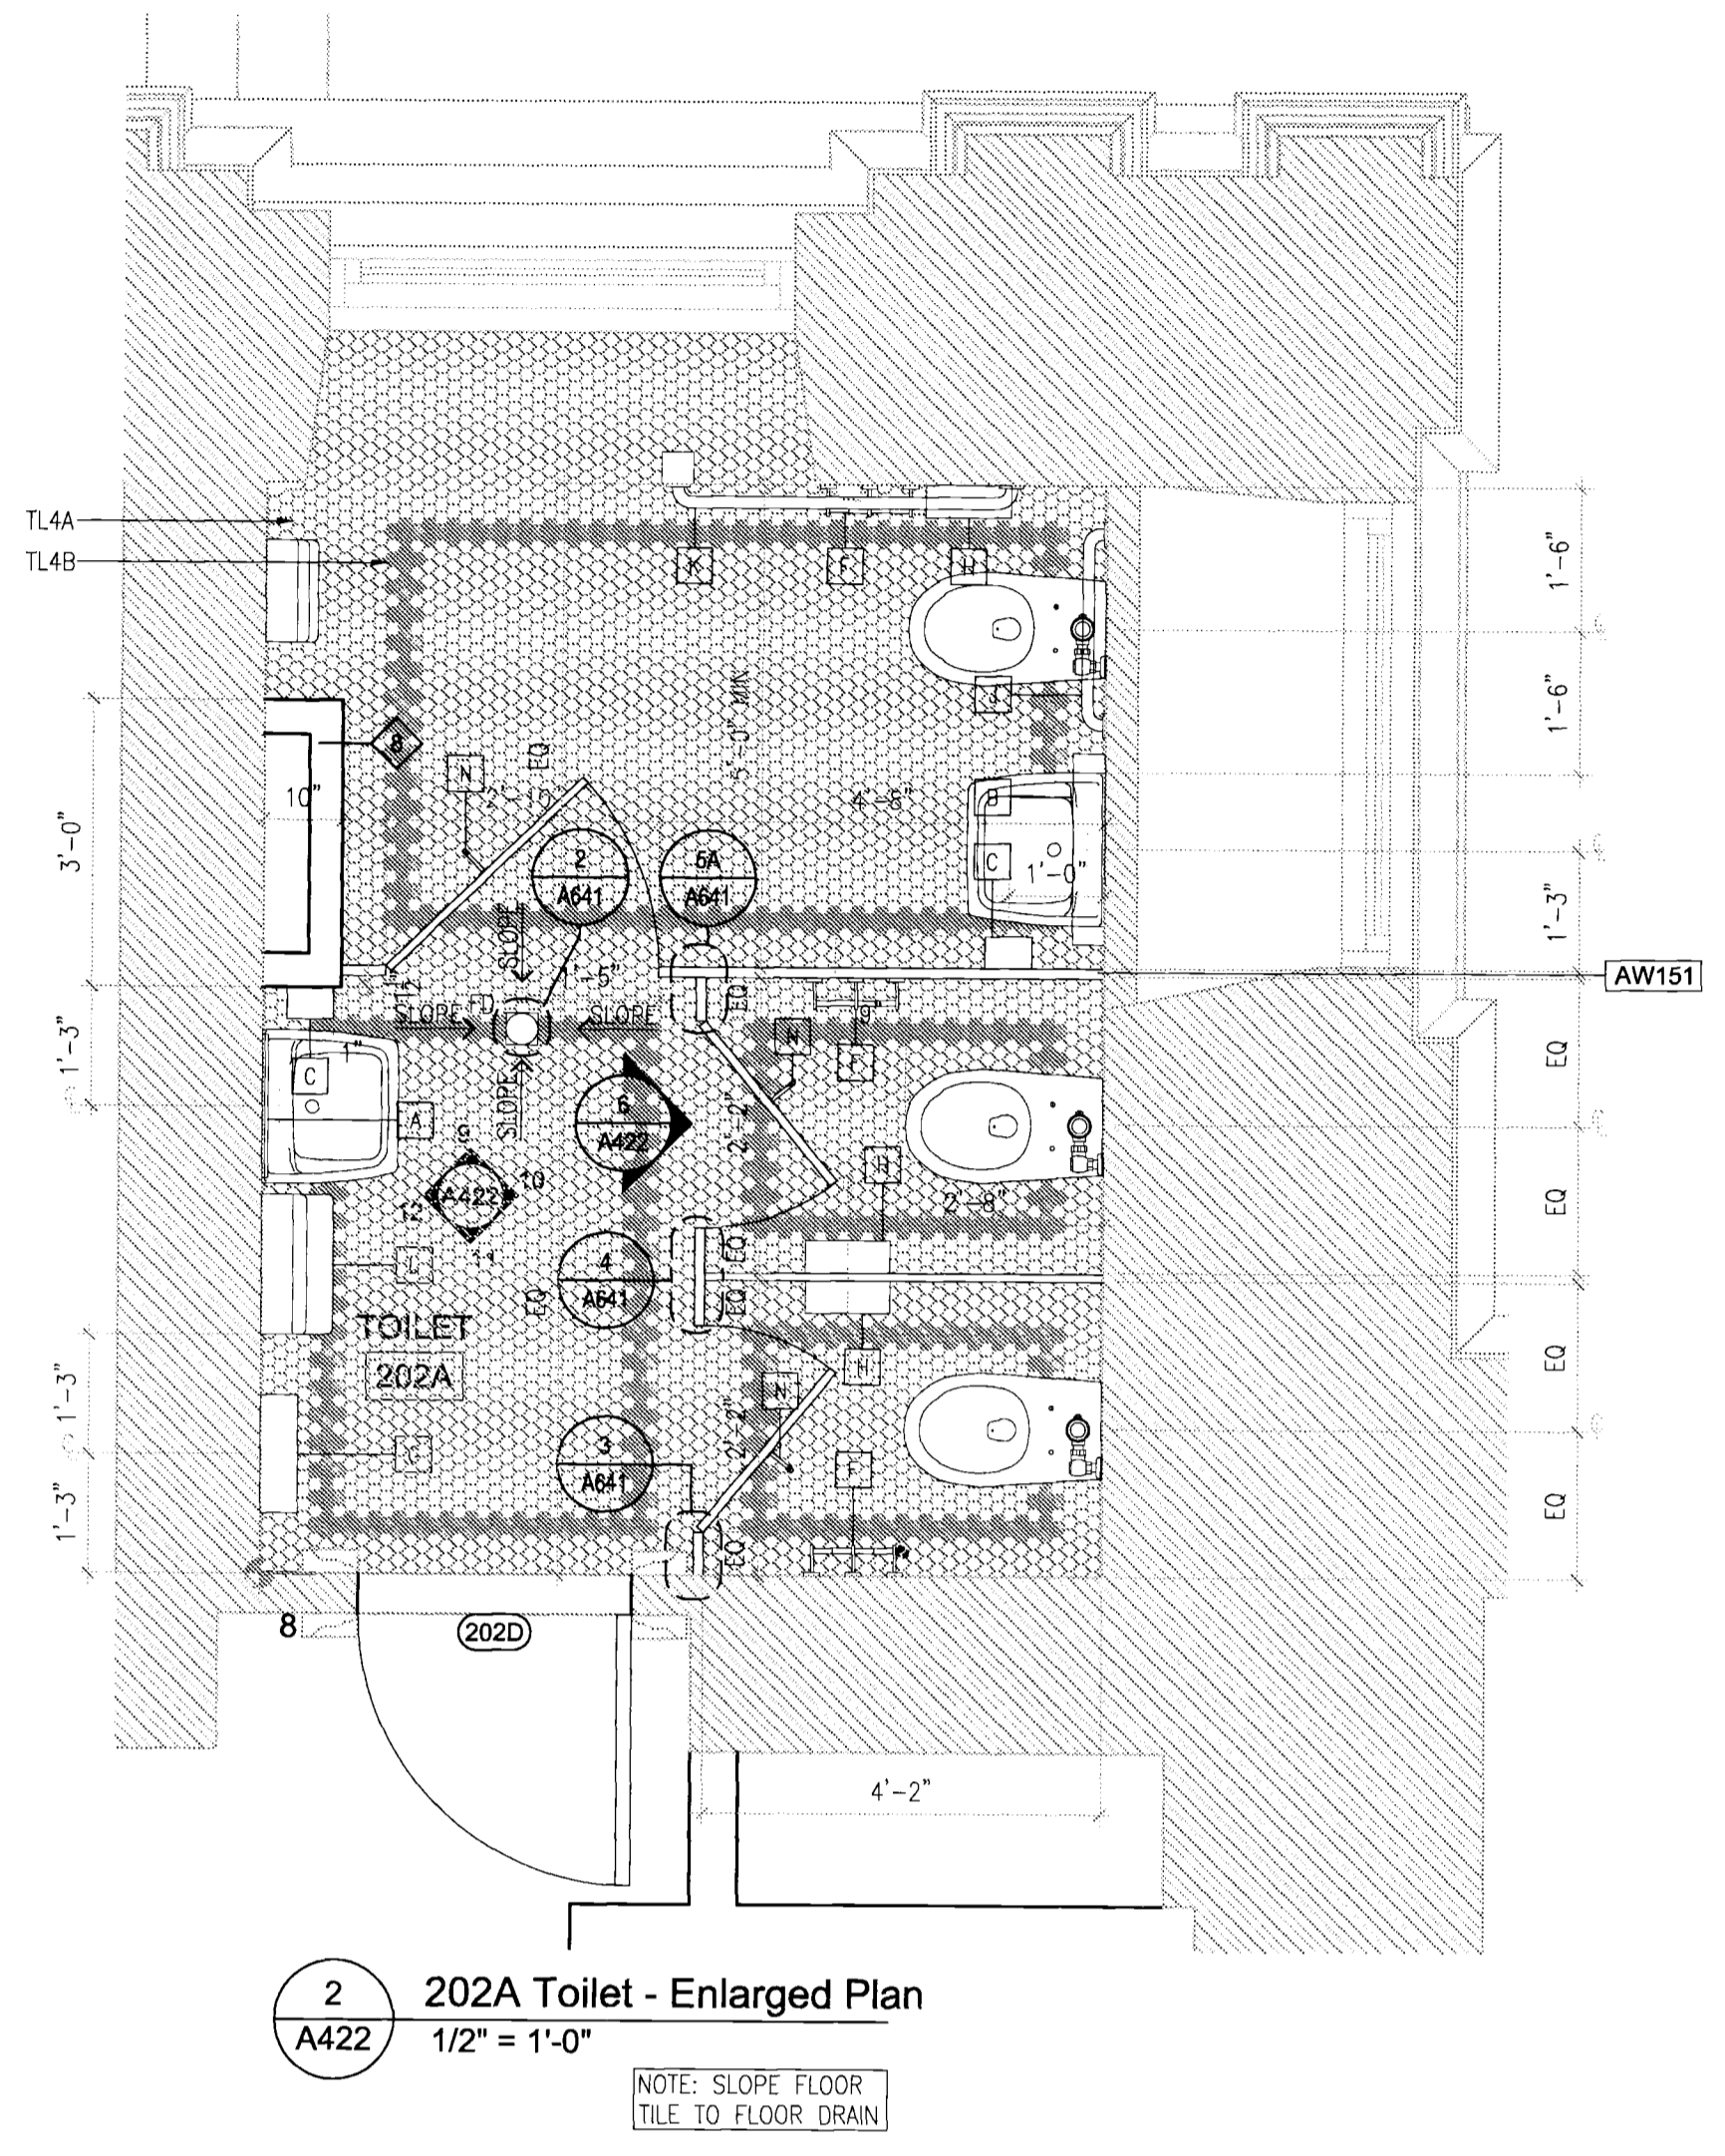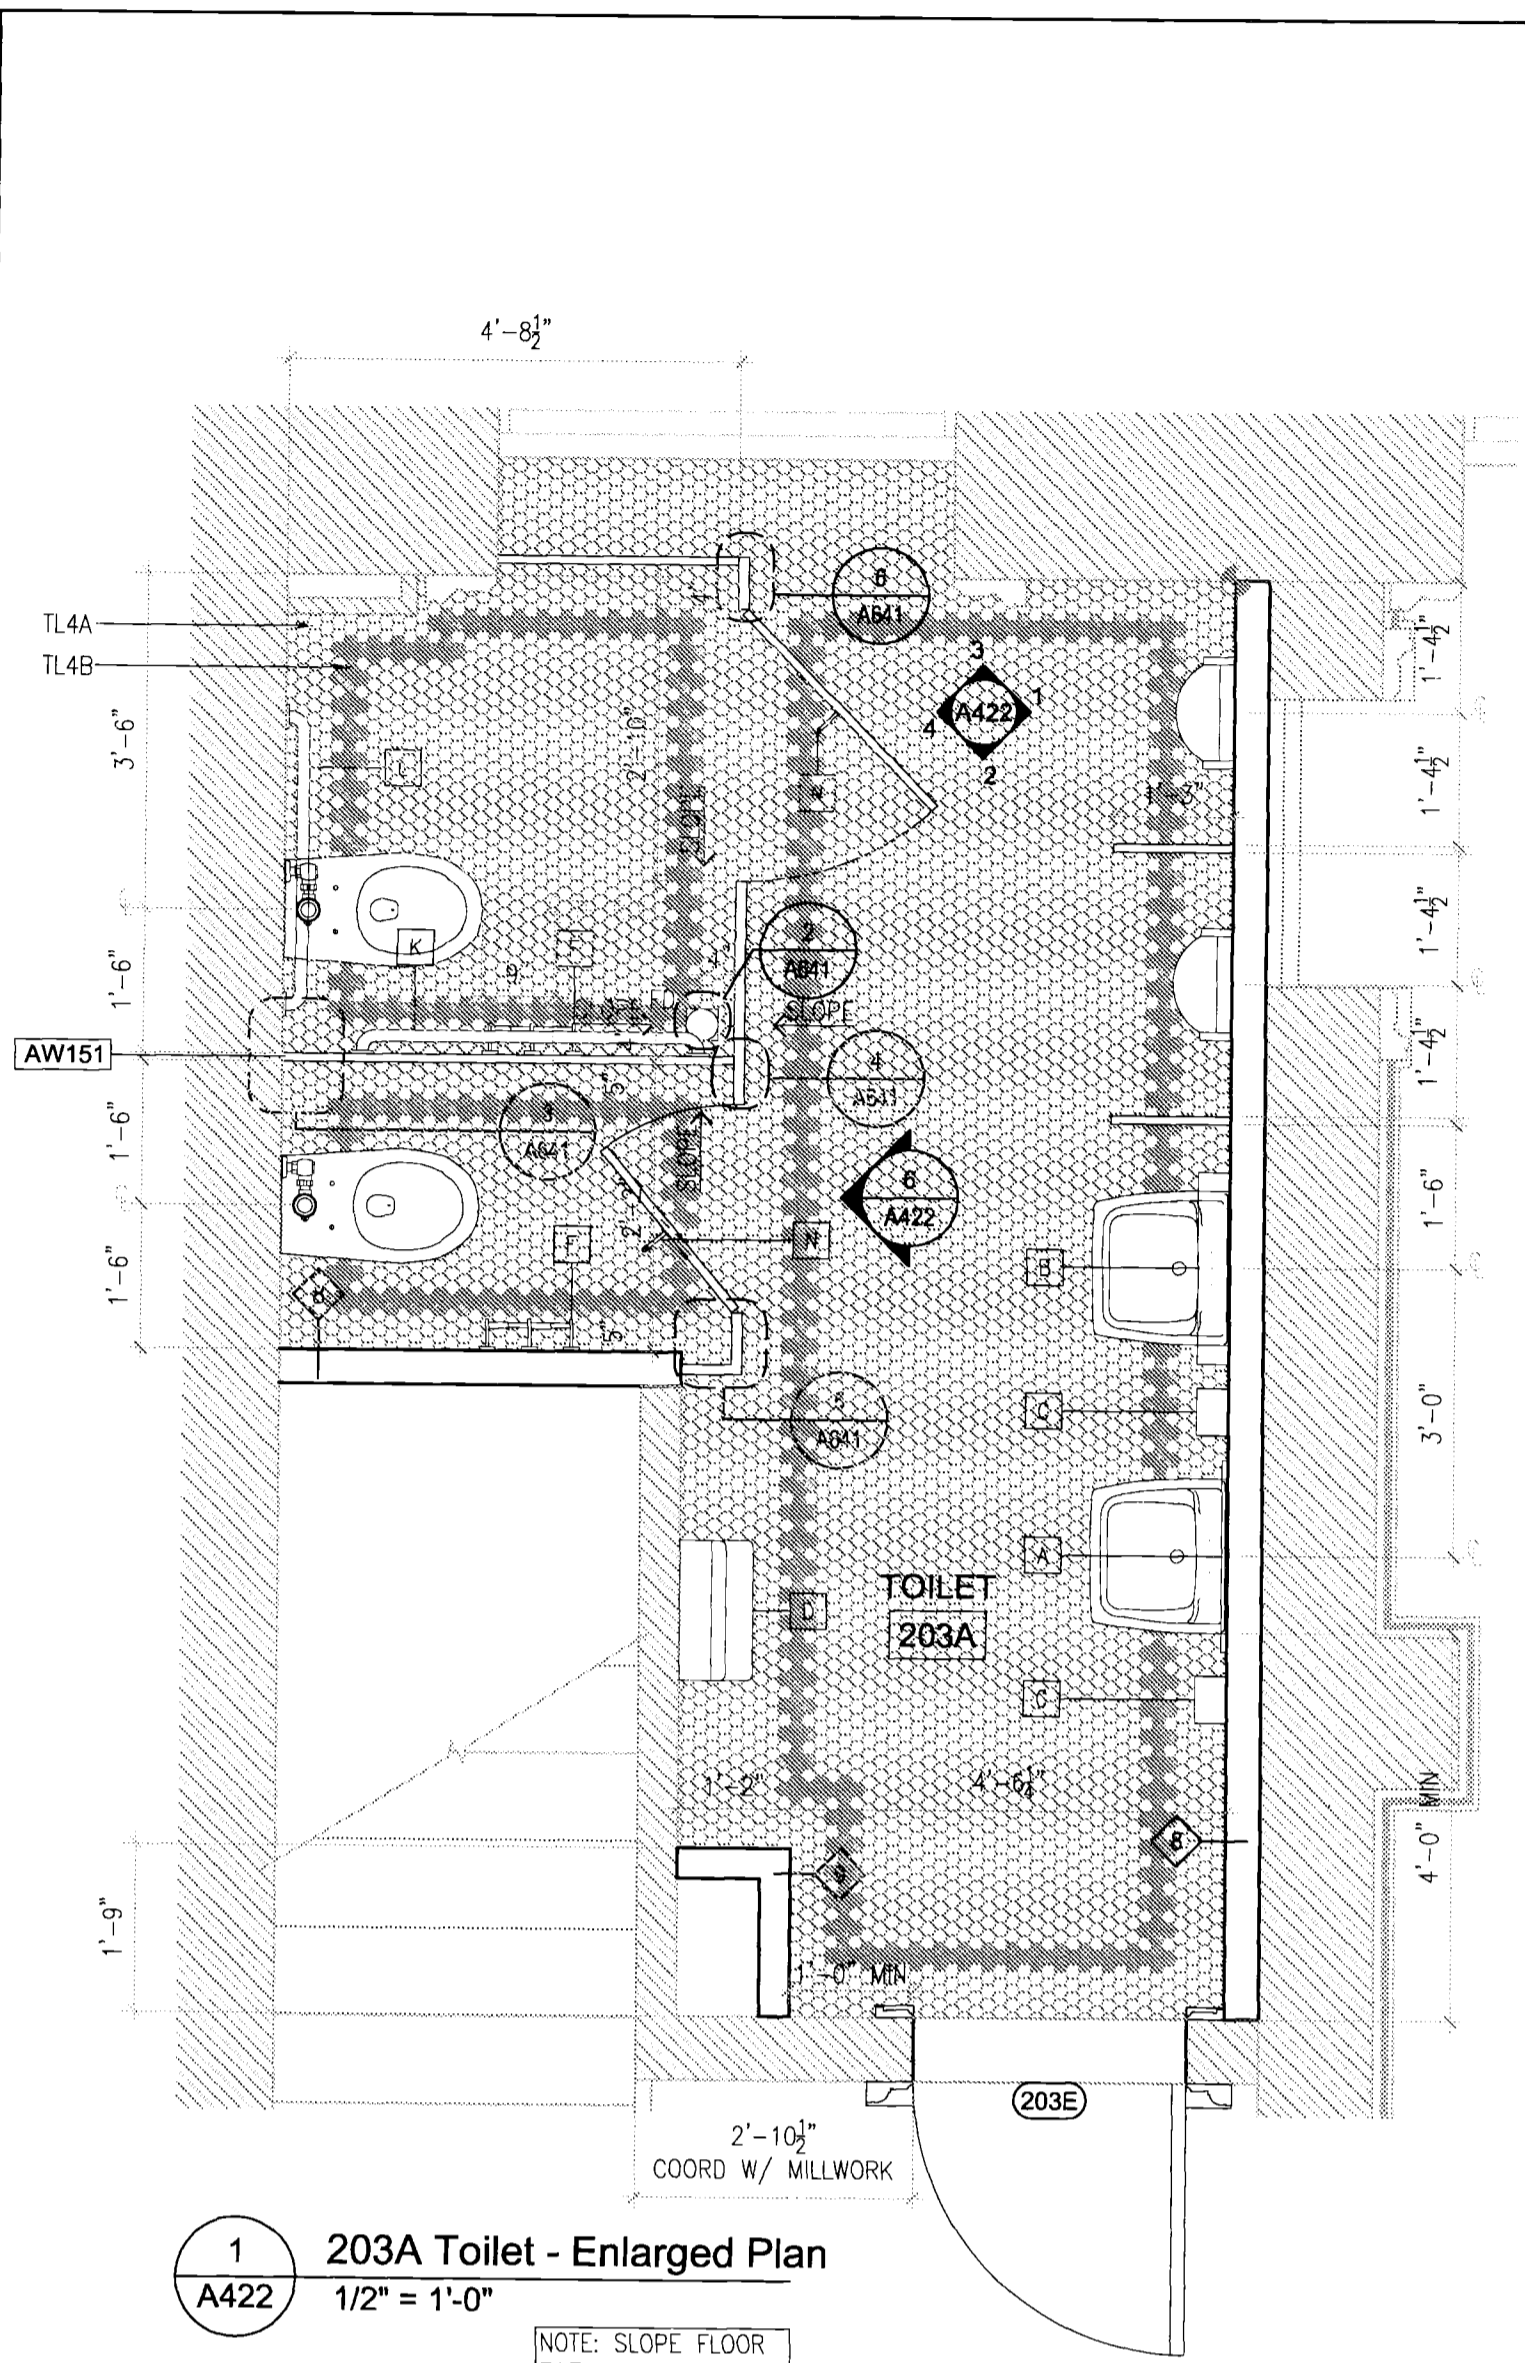REVISIONS:

NUMBER	DESCRIPTION	DATE



DIVISION OF STRUCTURES
 BUREAU OF ARCHITECTURE & ENGINEERING

CAPITAL PROJECT NUMBER:
 CITYHALL2
 PROJECT NAME:
 Renovation of City Hall
 Bid Package 2


FOR THE:

DRAWING TITLE:
Enlarged Plans and Elevations - 2

DRAWN BY: CG, KL SCALE: 1/2" = 1'-0"
 CHECKED BY: NA DATE: 10.08.10

DRAWING NUMBER:
A-422.00

DOB PERMIT APPLICATION

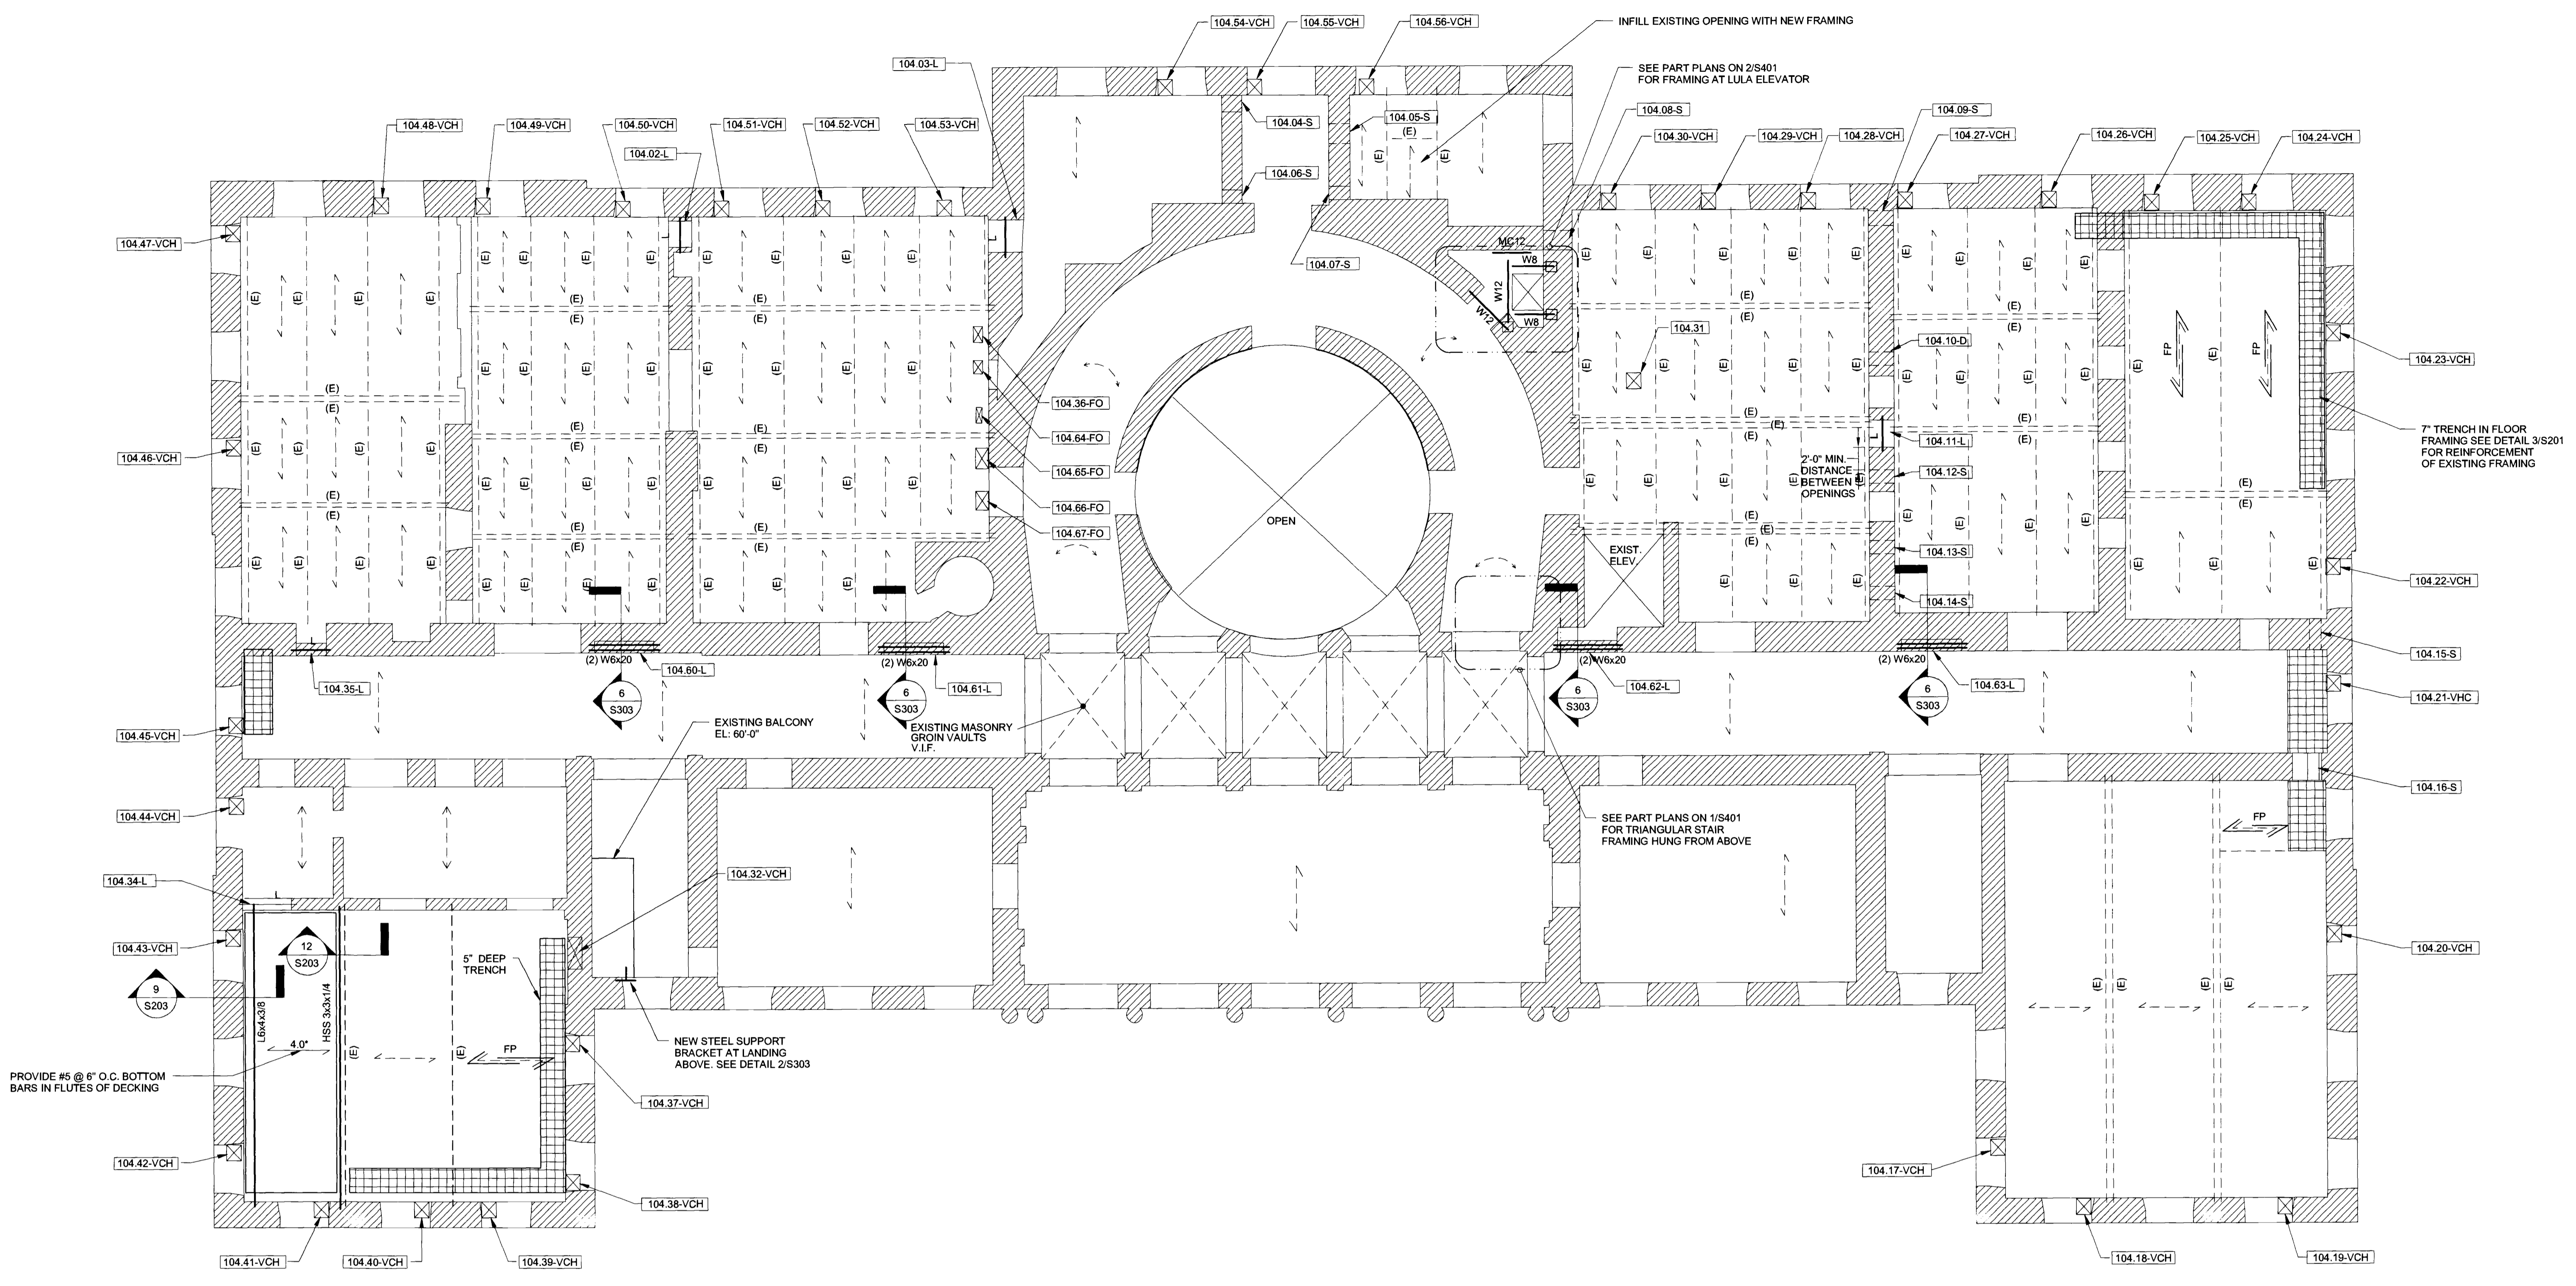

1 Second floor framing plan
1/8" = 1'-0"

LEGEND:

- INDICATES DIRECTION OF EXISTING 3"x12" WOOD JOISTS (TYP) ACTUAL SIZE MAY VARY. VERIFY ALL EXISTING FRAMING DIMENSIONS IN FIELD. NOTIFY ENGINEER AND ARCHITECT OF ANY DISCREPANCIES FOUND
- INDICATES EXISTING MASONRY WALL TO REMAIN
- W --- INDICATES NEW STEEL BEAM. SEE PLAN FOR SIZE
- (E)--- INDICATES EXISTING STEEL BEAM TO REMAIN
- (E)--- INDICATES NEW (2) 1 3/4" X 11 7/8" LVL U.O.N.
- (E)--- INDICATES EXISTING WOOD FRAMING
- INDICATES CHANGE IN ELEVATION
- INDICATES EXISTING MASONRY BARREL VAULT TO REMAIN
- L --- INDICATES NEW STEEL ANGLE LINTEL SEE TYPICAL DETAIL 7/S203 AND NOTES ON S201 FOR SIZE. LINTELS ARE BELOW FLOOR LEVEL SHOWN
- ○ INDICATES COLUMN UP, COLUMN DOWN
- FP --- INDICATES NOTCHED JOISTS TO BE REINF WITH 1/8" STEEL FLITCH PLATES BOTH SIDES FOR FULL LENGTH OF MEMBER INTO POCKET IN THIS AREA. SEE TYPICAL DETAIL 3/S201 FOR FLITCH PLATE.
- INDICATES NEW TRENCH IN FLOOR FOR MECHANICAL PIPING. SEE TYPICAL DETAIL 3/S201 FOR NOTCH IN EXISTING WOOD FLOOR FRAMING. PIPING TO RUN BETWEEN EXISTING JOISTS WHERE POSSIBLE. ALL REINFORCEMENT REQUIRED TO EXTEND FULL LENGTH OF EXISTING MEMBER INTO POCKET. SEE ARCHITECTURAL DRAWINGS FOR TRENCH LAYOUT AND LOCATION DIMENSIONS.
- INDICATES NEW 1 3/4" X EXISTING JOIST DEPTH LVL AT 16" O.C. U.O.N.
- INDICATES SPAN OF EXISTING TERRA COTTA FLAT ARCH
- XXX-XXX INDICATES MECHANICAL PENETRATION IN WALL OR FLOOR. SEE S305 AND THIS SHEET FOR SCHEDULE, LEGEND AND DETAILS.
- 4.0' INDICATES 2 1/2" LW CONC. SLAB ON 1 1/2" 16GA COMPOSITE METAL DECK. REINF WITH MACRO FIBERS AND #6 @ 6" O.C. BOTTOM OVER SPAN. TOTAL THICKNESS = 4"
- MASONRY REMOVAL
- BP-X INDICATES NEW STEEL BEARING PLATE. SEE DETAIL 2/S203 FOR SCHEDULE. BP-1 U.O.N.
- INDICATES NEW TRENCH IN FLOOR FOR MECHANICAL PIPING. SEE TYPICAL DETAIL 3/S201 FOR NOTCH IN EXISTING WOOD FLOOR FRAMING. PIPING TO RUN BETWEEN EXISTING JOISTS WHERE POSSIBLE. ALL REINFORCEMENT REQUIRED TO EXTEND FULL LENGTH OF EXISTING MEMBER INTO POCKET. SEE ARCHITECTURAL DRAWINGS FOR TRENCH LAYOUT AND LOCATION DIMENSIONS.


WALL PENETRATION LEGEND:

- XXX-XHC INDICATES HORIZONTAL CORE
- XXX-XXVC INDICATES VERTICAL CORE
- XXX-XXVCH INDICATES VERTICAL CHASE
- XXX-XXS INDICATES SLEEVE (SQUARE OR CIRCULAR)
- XXX-XX-L INDICATES LINTEL (WIDE FLANGE OR ANGLE, SEE PLAN)
- XXX-XX-FO INDICATES FLOOR OPENING
- XXX-XX-MR INDICATES MASONRY REMOVAL

NOTES:

1. TOP OF EXISTING FINISHED FLOOR = +68'-0 1/2", UNLESS OTHERWISE NOTED THIS: T.O. FLOOR EL. +X'-X"
2. PLAN INDICATES SECOND FLOOR FRAMING WITH WALLS OF FIRST FLOOR BELOW. PENETRATIONS SHOW ARE BELOW SECOND FLOOR.
3. SEE S200 SERIES FOR ALL TYPICAL DETAILS.
4. ALL EXISTING FRAMING SHOWN IS BASED ON VERY LIMITED FIELD SURVEY INFORMATION AND IS SHOWN SCHEMATICALLY. ALL EXISTING FRAMING IS TO BE VERIFIED IN FIELD.
5. NO FIELD WELDING IS PERMITTED EXCEPT WHERE APPROVED BY DDC.
6. SEE PENETRATION SCHEDULE ON S305 AND LEGEND ON THIS SHEET FOR INFORMATION AND DESCRIPTIONS OF ALL PENETRATIONS INDICATED ON PLAN. PENETRATIONS NOTED THIS: SHEET NUMBER, PENETRATION NUMBER - TYPE [XXX-XXX-X]. COORDINATE WITH ARCHITECTURAL DRAWINGS.
7. AT LOCATIONS SHOWN INSTALL STEEL SLEEVE AND PIPE PENETRATION FOR MECHANICAL ACCESS INSTALLED IN RUBBLE WALL CONSTRUCTION. CONTRACTOR TO PROVIDE WRITTEN PROCEDURE FOR APPROVAL BY ENGINEER OF RECORD PRIOR TO INSTALLATION. COORDINATE LOCATION WITH MECHANICAL AND ARCHITECTURAL DRAWINGS. SEE S203 ON FOR SLEEVE PENETRATION IN EXISTING WALLS WITH OPENINGS LESS THAN 24" WIDE.

SEAL:

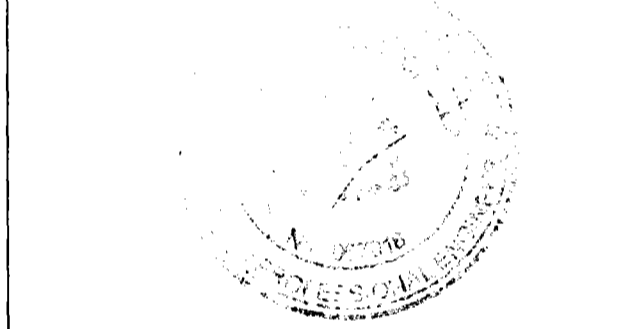

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DIVISION OF STRUCTURES
BUREAU OF ARCHITECTURE & ENGINEERING

CAPITAL PROJECT NUMBER:
CITY HALL 2
PROJECT NAME:
Renovation of City Hall
Bid Package 2

FOR THE:


DRAWING TITLE:
Second Floor Framing Shown On First Floor Walls

DRAWN BY: SL SCALE:
CHECKED BY: JUM DA*
DRAWING NUMBER:

S10



D.O.B. PERMIT APPLICATION

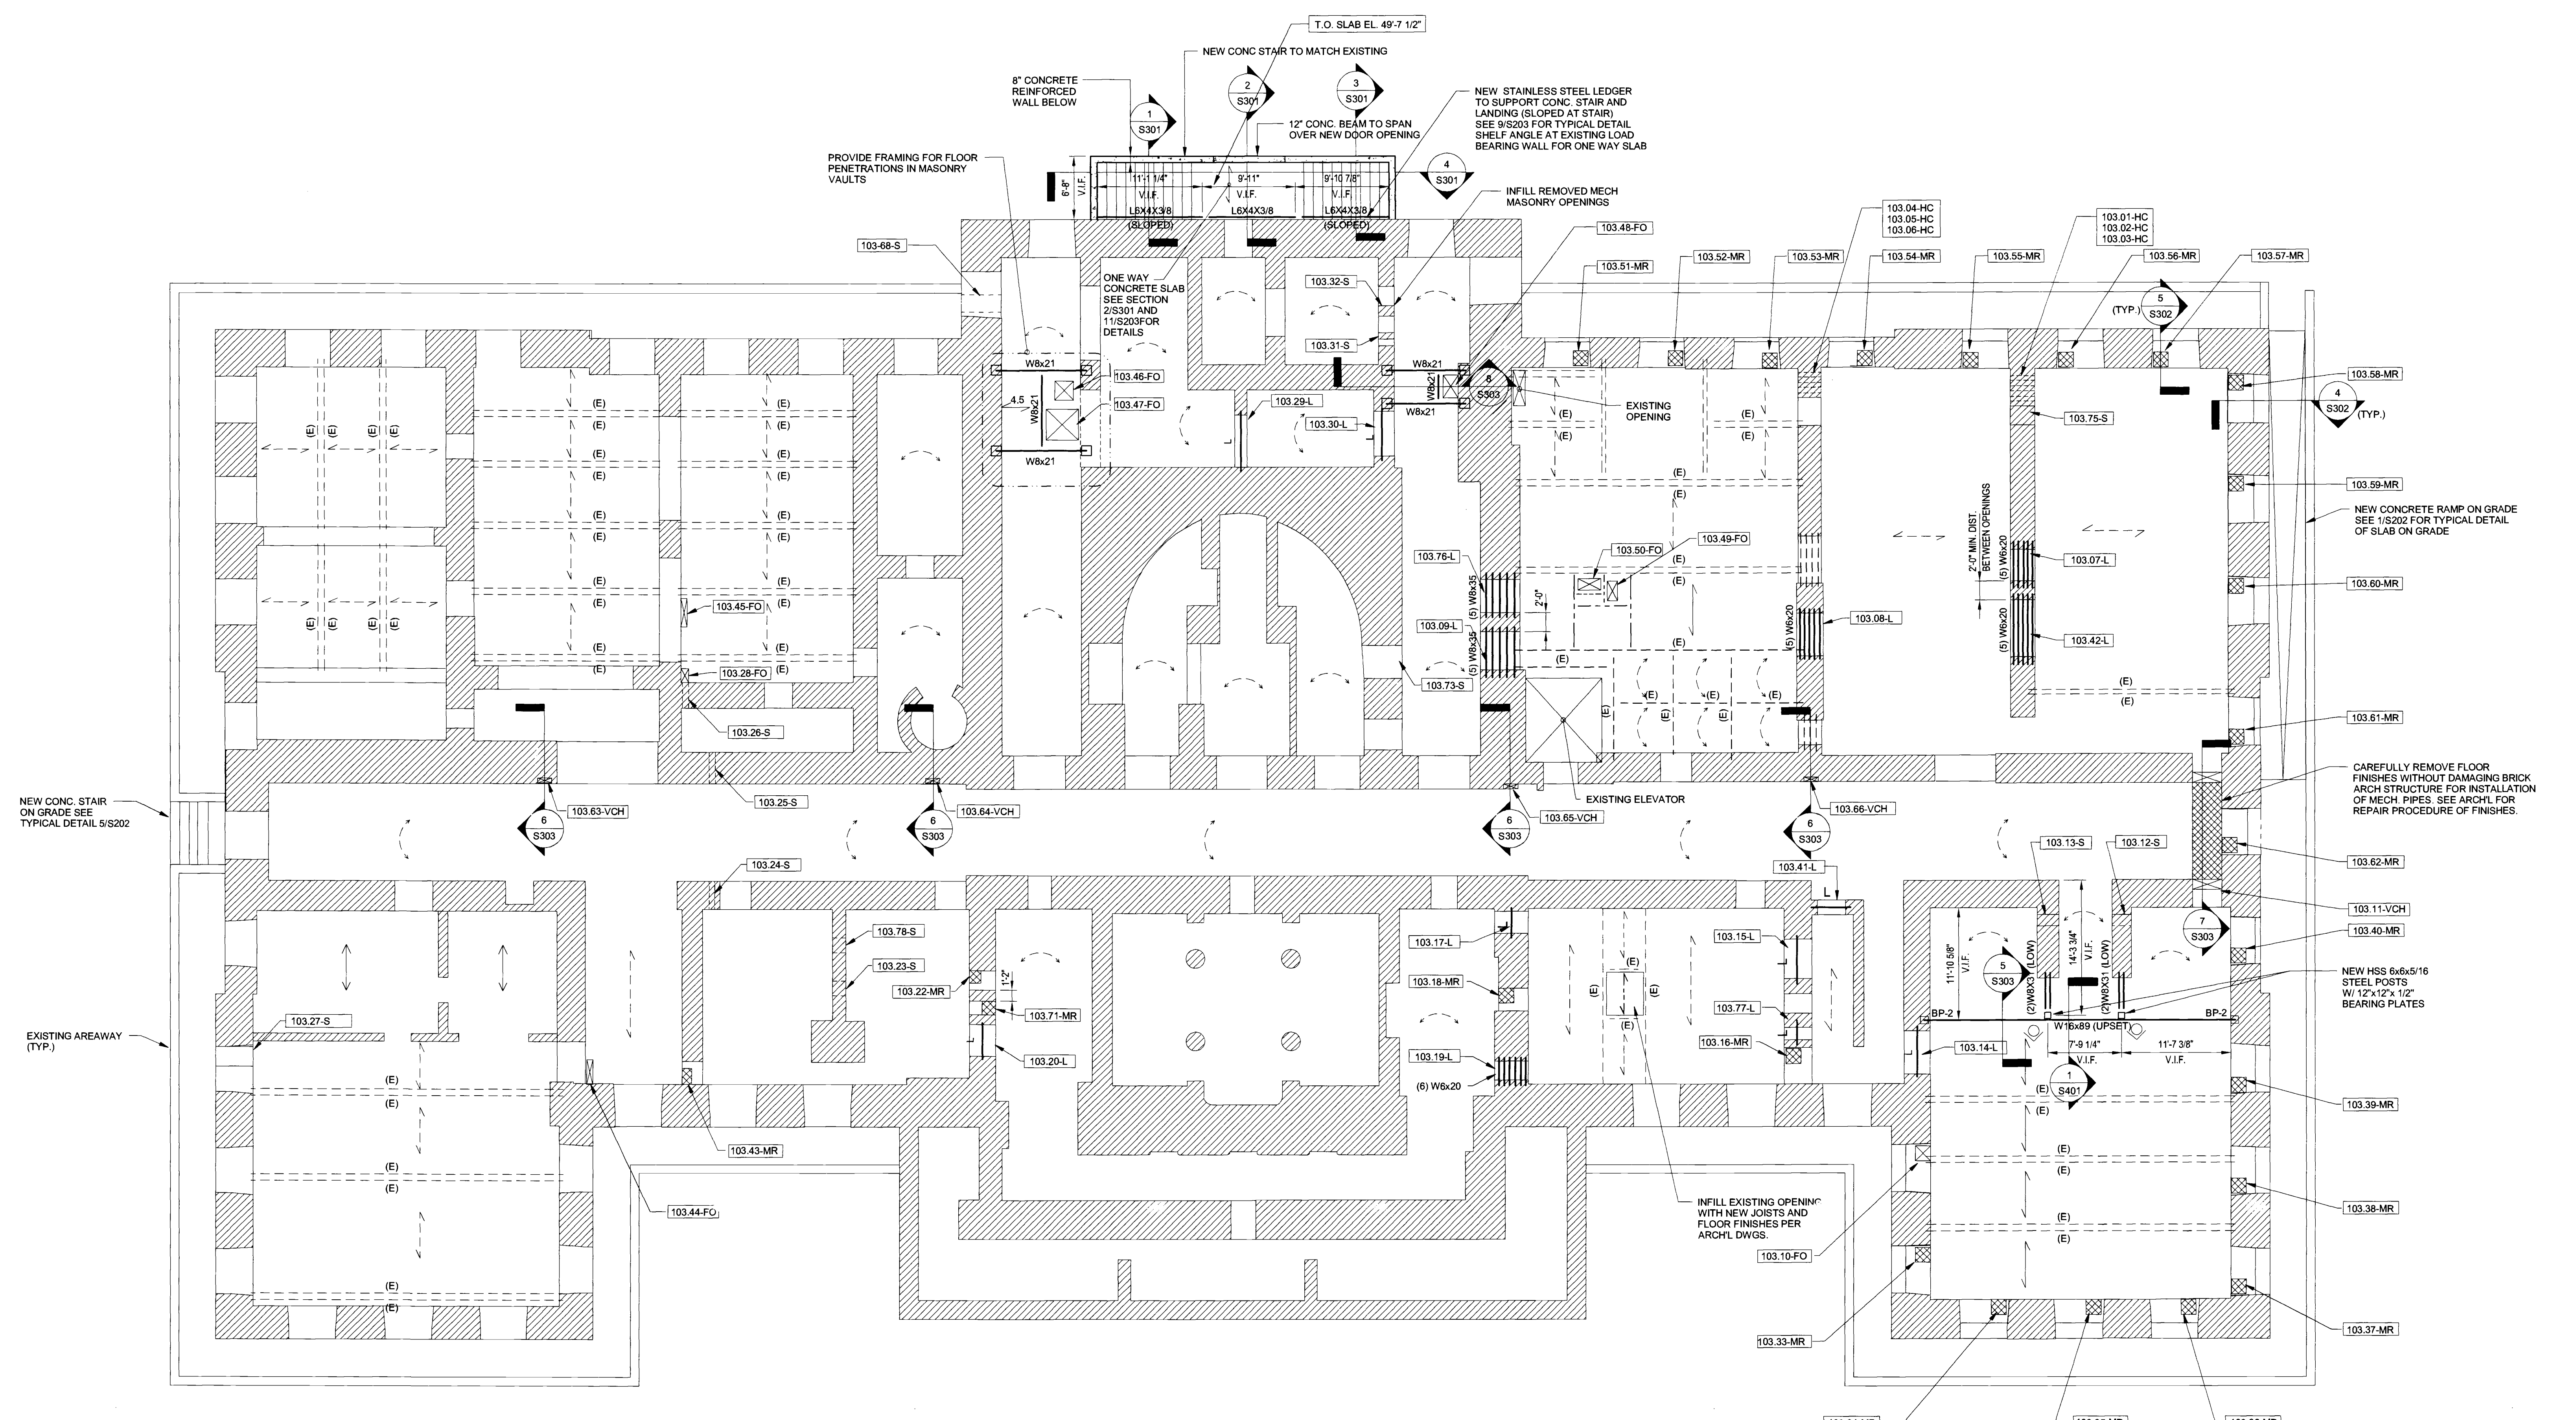

1 First Floor Framing Plan
1/8" = 1'-0"

LEGEND:

- INDICATES DIRECTION OF EXISTING 3x12" WOOD JOISTS (TYP) ACTUAL SIZE MAY VARY. VERIFY ALL EXISTING FRAMING DIMENSIONS IN FIELD. NOTIFY ENGINEER AND ARCHITECT OF ANY DISCREPANCIES FOUND.
- INDICATES NEW CAST-IN-PLACE REINFORCED CONCRETE WALL.
- INDICATES EXISTING MASONRY WALL TO REMAIN.
- INDICATES NEW STEEL BEAM. SEE PLAN FOR SIZE.
- INDICATES EXISTING STEEL BEAM TO REMAIN.
- INDICATES NEW (2) 1 3/4" x 11 7/8" LVL, U.O.N.
- INDICATES EXISTING WOOD FRAMING.
- INDICATES CHANGE IN ELEVATION.
- INDICATES EXISTING MASONRY BARREL VAULT TO REMAIN.
- INDICATES NEW STEEL ANGLE LINTEL SEE TYPICAL DETAIL 7/S203 AND NOTES ON S201 FOR SIZE. LINTELS ARE BELOW FLOOR LEVEL SHOWN.
- INDICATES COLUMN UP, COLUMN DOWN.
- INDICATES NOTCHED JOISTS TO BE REINF WITH 1/8" STEEL FLITCH PLATES BOTH SIDES FOR FULL LENGTH OF MEMBER INTO POCKET IN THIS AREA. SEE TYPICAL DETAIL 3/S201 FOR FLITCH PLATE.
- INDICATES NEW TRENCH IN FLOOR FOR MECHANICAL PIPING. SEE TYPICAL DETAIL 3/S201 FOR NOTCH IN EXISTING WOOD FLOOR FRAMING. PIPING TO RUN BETWEEN EXISTING JOISTS WHERE POSSIBLE. ALL REINFORCEMENT REQUIRED TO EXTEND FULL LENGTH OF EXISTING MEMBER INTO POCKET. SEE ARCHITECTURAL DRAWINGS FOR TRENCH LAYOUT AND LOCATIONS DIMENSIONS.
- INDICATES LOCATION OF MASONRY BELOW EXISTING WINDOWS TO BE REMOVED TO ACCOMMODATE FAN COIL UNIT AND RELATED PIPING. SEE TYPICAL DETAILS ON S302 AND ON S201 FOR MASONRY REPAIRS IN BRICK MASONRY SEE A511 FOR ADDITIONAL COORDINATE WITH MECH AND ARCH DRAWINGS.
- INDICATES 2 1/2" LW CONC. SLAB ON 2'-18" GA. COMPOSITE METAL DECK. REINF. WITH MACRO FIBERS TOTAL THICKNESS = 4 1/2".
- INDICATES NEW 1 3/4" x EXISTING JOIST DEPTH LVL'S AT 16" O.C. (U.O.N.)
- INDICATES 8" CAST-IN-PLACE ONE WAY CONCRETE SLAB, REINFORCE WITH #4@12" O.C. BOTTOM BARS SEE DETAIL 2/S301 FOR ADDITIONAL INFORMATION.
- INDICATES SPAN OF EXISTING TERRA COTTA FLAT ARCH.
- INDICATES MECHANICAL PENETRATION IN WALL OR FLOOR. SEE S305 FOR SCHEDULE LEGEND THIS SHEET AND DETAILS.
- INDICATES NEW STEEL BEARING PLATE. SEE DETAIL 2/S203 FOR SCHEDULE. BP-1 U.O.N.

WALL PENETRATION LEGEND:

- INDICATES HORIZONTAL CORE
- INDICATES VERTICAL CORE
- INDICATES VERTICAL CHASE
- INDICATES SLEEVE (SQUARE OR CIRCULAR)
- INDICATES LINTEL (WIDE FLANGE OR ANGLE. SEE PLAN)
- INDICATES FLOOR OPENING
- INDICATES MASONRY REMOVAL

NOTES:

1. TOP OF EXISTING FINISHED FIRST FLOOR = +49'-10 1/2", UNLESS OTHERWISE NOTED THUS: T.O. FLOOR EL. -X'-X"
2. PLAN INDICATES FIRST FLOOR FRAMING WITH WALLS OF BASEMENT BELOW. PENETRATIONS SHOWN ARE BELOW FIRST FLOOR.
3. SEE S200 SERIES FOR ALL TYPICAL DETAILS.
4. ALL EXISTING FRAMING SHOWN IS BASED ON LIMITED FIELD SURVEY INFORMATION AND IS SHOWN SCHEMATICALLY. ALL EXISTING FRAMING IS TO BE VERIFIED IN FIELD.
5. NO FIELD WELDING IS PERMITTED EXCEPT WHERE APPROVED BY DDC.
6. SEE PENETRATION SCHEDULE ON S305 AND LEGEND THIS SHEET FOR INFORMATION AND DESCRIPTIONS OF ALL PENETRATIONS ALL SHEETS INDICATED ON PLAN. PENETRATIONS NOTED THUS: SHEET NUMBER, PENETRATION NUMBER - TYPE [EX: 102-XX-X] COORDINATE WITH ARCHITECTURAL DRAWINGS.
7. AT LOCATIONS SHOWN INSTALL STEEL SLEEVE AND PIPE PENETRATION FOR MECHANICAL ACCESS INSTALLED IN RUBBLE WALL CONSTRUCTION. CONTRACTOR TO PROVIDE WRITTEN PROCEDURE FOR APPROVAL BY ENGINEER OF RECORD PRIOR TO INSTALLATION. COORDINATE LOCATION WITH MECHANICAL AND ARCHITECTURAL DRAWINGS. SEE 8/S203 FOR SLEEVE PENETRATION IN EXISTING WALLS AT OPENINGS LESS THAN 24" WIDE.
8. REPAIR ALL MASONRY WALLS WHERE EXISTING MECH PENETRATIONS ARE NOT BEING USED.

SEAL:



REVISIONS:

NUMBER	DESCRIPTION	DATE



DIVISION OF STRUCTURES
BUREAU OF ARCHITECTURE & ENGINEERING

CAPITAL PROJECT NUMBER:
CITY HALL 2

PROJECT NAME:
Renovation of City Hall
Bid Package 2

FOR THE:


DRAWING TITLE:
First Floor Framing Shown on Basement Wall Plan

DRAWN BY: SL SCALE: 1/8" = 1'-0"
CHECKED BY: JJM DATE: 10.08.10

DRAWING NUMBER:

S103.00

SHEET NUMBER:
30 OF 42

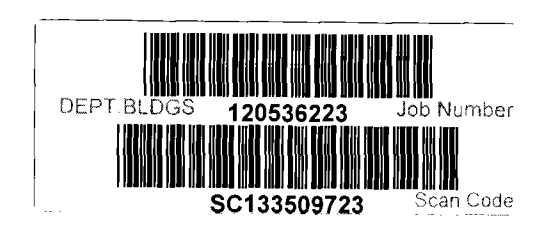

D.O.B. PERMIT APPLICATION

GENERAL NOTES

- ALL STRUCTURAL WORK SHALL BE COORDINATED WITH ARCHITECTURAL AND MECHANICAL DRAWINGS AND SHALL CONFORM TO THE PROJECT SPECIFICATIONS, INCLUDING THE CITY OF NEW YORK BUILDING CODE, 2008 EDITION.
- CONTRACTOR SHALL PROVIDE TEMPORARY SHORING, BRACING, SHEETING AND MAKE SAFE ALL FLOORS, ROOFS, WALLS AND ADJACENT PROPERTY AS PROJECT CONDITIONS REQUIRE. SHORING AND SHEETING SHALL BE DESIGNED BY A STATE OF NEW YORK LICENSED PROFESSIONAL ENGINEER HIRED BY THE CONTRACTOR, WHO SHALL SUBMIT SHOP DRAWINGS AND CALCULATIONS FOR THE OWNER'S REVIEW.
- DIMENSIONS AND ELEVATIONS OF EXISTING CONSTRUCTION GIVEN IN STRUCTURAL DRAWINGS ARE BASED ON INFORMATION CONTAINED IN VARIOUS ORIGINAL DESIGN AND CONSTRUCTION DOCUMENTS PROVIDED BY THE OWNER, AND LIMITED FIELD OBSERVATIONS AND MEASUREMENTS. THE CONTRACTOR SHALL VERIFY ALL INFORMATION PERTAINING TO EXISTING CONDITIONS BY ACTUAL MEASUREMENT AND OBSERVATION AT THE SITE. ALL DISCREPANCIES BETWEEN ACTUAL CONDITIONS AND THOSE SHOWN IN THE CONTRACT DOCUMENTS SHALL BE REPORTED TO THE ENGINEER OF RECORD FOR HIS EVALUATION BEFORE THE AFFECTED CONSTRUCTION IS IN PLACE.

FOUNDATIONS

- BUILDING FOUNDATIONS SHALL BEAR ON UNDISTURBED SOIL HAVING MINIMUM BEARING CAPACITY OF 5500 PSF, AS SPECIFIED BY THE GEOTECHNICAL CONSULTANT. ADEQUACY OF BEARING STRATUM SHALL BE VERIFIED IN FIELD PRIOR TO PLACING CONCRETE. ADJUST BOTTOM OF FOOTING ELEVATION AS REQUIRED.
- DO NOT PLACE BACKFILL AGAINST BASEMENT WALLS UNTIL ALL FLOORS BRACING THESE WALLS ARE IN PLACE AND HAVE ATTAINED THEIR 28 DAY STRENGTH.
- ALL EXTERIOR FOOTINGS SHALL BE PLACED A MINIMUM OF 4'-0" BELOW FINAL GRADE.

CONCRETE

- ALL CONCRETE WORK SHALL CONFORM TO THE ACI "BUILDING CODE REQUIREMENTS FOR STRUCTURAL CONCRETE" (ACI 318), LATEST EDITION.
- ALL CONCRETE COMPOSITE ON METAL DECK SHALL BE LIGHT WEIGHT CONCRETE WITH A MINIMUM COMPRESSIVE STRENGTH OF 3,000 PSI AT 28 DAYS, UNLESS OTHERWISE NOTED.
- ALL OTHER CONCRETE SHALL BE NORMAL WEIGHT CONCRETE WITH A MINIMUM COMPRESSIVE STRENGTH OF 4,000 PSI AT 28 DAYS, UNLESS OTHERWISE NOTED.
- REINFORCING STEEL SHALL BE DEFORMED BARS CONFORMING TO ASTM A615, GRADE 60 OR A775 EPOXY COATED WHEN CALLED OUT ON PLAN. REINFORCING STEEL SHALL BE DETAILED ACCORDING TO THE ACI "DETAILS AND DETAILING OF REINFORCEMENT", (ACI 315), LATEST EDITION.
- WELDED WIRE FABRIC SHALL CONFORM TO ASTM A185, WITH A MINIMUM YIELD STRENGTH OF 70,000 PSI.
- COORDINATE SIZE AND LOCATION OF ALL OPENINGS AND PIPE SLEEVES WITH ARCHITECTURAL AND MECHANICAL DRAWINGS. MINIMUM CONCRETE BETWEEN SLEEVES SHALL BE 6".
- ALL GROUT SHALL BE NONSHRINK WITH A MINIMUM COMPRESSIVE STRENGTH OF 5,000 PSI.
- PROVIDE CLEARANCE FROM FACE OF CONCRETE TO REINFORCEMENT AS FOLLOWS:
SLABS: 3/4"
BEAMS, COLUMNS: 1 1/2"
FOOTINGS: 3"
EXTERIOR WALLS: 2" FOR #6 OR LARGER, 1 1/2" FOR #6 OR SMALLER
INTERIOR WALLS: 3/4"
- SHOP DRAWINGS SHALL BE SUBMITTED TO THE STRUCTURAL ENGINEER FOR REVIEW AND APPROVAL. NO CONCRETE WORK SHALL COMMENCE WITHOUT APPROVED SHOP DRAWINGS.
- CLEAN AND ROUGHEN TO 1/4" AMPLITUDE ALL EXISTING CONCRETE SURFACES TO RECEIVE NEW CONCRETE PRIOR TO PLACEMENT.

STRUCTURAL STEEL

- ALL STRUCTURAL STEEL WORK SHALL CONFORM TO THE FOLLOWING GOVERNING STANDARDS:
A. AISC "SPECIFICATION FOR THE DESIGN, FABRICATION AND ERECTION OF STRUCTURAL STEEL FOR BUILDINGS," LATEST EDITION.
B. THE AMERICAN WELDING SOCIETY (AWS D1.1) "CODE FOR WELDING IN BUILDING CONSTRUCTION," LATEST EDITION.
- ALL STRUCTURAL STEEL SHALL CONFORM TO THE FOLLOWING ASTM SPECIFICATIONS:
A. WIDE FLANGE BEAMS, COLUMNS AND STRUCTURAL TEES: ASTM A992, GRADE 50.
B. HOLLOW STRUCTURAL SECTIONS: ASTM A600, GRADE B.
C. STRUCTURAL PIPE SECTIONS: ASTM A501 OR ASTM A513, GRADE B.
D. CHANNELS, ANGLES AND PLATES: ASTM A36 UNLESS OTHERWISE NOTED.
E. BOLTED CONNECTIONS OF BEAMS OR GIRDERS ARE TO BE MADE WITH ASTM A325-T3 BOLTS (3/4" DIA.)
F. ANCHOR BOLTS: ASTM F1554, GRADE 36.
- STEEL CONNECTIONS SHALL BE STANDARD AISC FRAMED BEAM CONNECTIONS.
A. FOR NON-COMPOSITE MEMBERS, PROVIDE CONNECTIONS BASED ON REACTION AS DETERMINED FROM AISC UNIFORM LOAD TABLE, (UNLESS OTHERWISE NOTED ON PLANS).
B. FOR COMPOSITE MEMBERS, PROVIDE CONNECTIONS BASED ON 1.5 x REACTION FROM AISC UNIFORM LOAD TABLE, (UNLESS OTHERWISE NOTED ON PLANS).
C. REINFORCING IS TO BE PROVIDED AT CONNECTIONS WHERE CUTS REDUCE THE SHEAR OR MOMENT CAPACITY BELOW THAT REQUIRED TO SUSTAIN THE REACTION. FLANGES AND WEB ARE TO BE REINFORCED WHERE THE LOCAL CAPACITY TO SUSTAIN CONNECTION LOAD IS INADEQUATE.
D. CONNECTIONS SHALL BE DESIGNED FOR SHEAR AND ECCENTRICITY, CONSIDERING THAT THE CONNECTION IS AN EXTENSION OF THE BEAM AND GIRDERS.
- ALL BEAMS EXCEPT CANTILEVER BEAMS SHALL BE FABRICATED WITH NATURAL CAMBER UP. CANTILEVER BEAMS SHALL BE FABRICATED SO THAT NATURAL CAMBER BEARS CANTILEVER END.
- WELDING SHALL BE PERFORMED BY CERTIFIED LICENSED WELDERS AND ARE AWS QUALIFIED. WELDING ELECTRODES SHALL BE AWS E1, CLASS E70XX, USE LOW HYDROGEN ELECTRODES FOR A572, GRADE 50 STEEL.
- SHOP PAINT EXPOSED STEEL MEMBERS, STEEL MEMBERS NOT ENCASED IN CONCRETE OR SPRAY FIREPROOFED, AND ALL STEEL MEMBERS AT THE EXTERIOR WALL WITH THEBRED #10-99. FIELD PAINT AS PER ARCHITECTURAL DRAWINGS AND SPECIFICATIONS.
- LINTELS SHALL BE INSTALLED OVER ALL OPENINGS IN MASONRY WALLS AS FOLLOWS:
MASONRY OPENING LINTEL
4'-0" OR LESS 1'-4" x 3'-12" x 5'-10"
4'-1" TO 7'-0" 1'-8" x 3'-12" x 5'-10"
A. 3'-12" LESS ARE HORIZONTAL.
B. PROVIDE ONE ANGLE FOR EACH 4'-0" OF WALL THICKNESS.
C. PROVIDE 1/8" x 5'-10" ANGLES FOR 8" THICK WALLS AND PARTITIONS WITH OPENINGS UP TO 6'-0".
D. PROVIDE MINIMUM 6" BEARING AT EACH END.
E. LINTELS OVER 4'-0" SHALL BE FIREPROOFED.
- MASONRY ANCHORS SHALL BE HILTI "HIT" ADHESIVE ANCHORS AS MANUFACTURED BY HILTI FASTENING SYSTEMS, INC., OR APPROVED EQUAL. THE SIZE AS INDICATED ON THE DRAWINGS. THEY SHALL BE INSTALLED AS PER MANUFACTURER'S INSTRUCTIONS.
- SHOP AND ERECTION DRAWINGS SHALL BE SUBMITTED TO THE STRUCTURAL ENGINEER FOR REVIEW AND APPROVAL. NO FABRICATION OF STEEL SHALL COMMENCE WITHOUT APPROVED SHOP DRAWINGS.

STEEL DECK

- ALL METAL DECK WORK SHALL CONFORM TO THE AISI "SPECIFICATION FOR THE DESIGN OF COLD-FORMED STEEL STRUCTURAL MEMBERS," LATEST EDITION.
- ALL METAL DECK UNITS AND ACCESSORY ITEMS SHALL BE FORMED FROM STEEL SHEETS CONFORMING TO ASTM A811 OR A853 WITH A MINIMUM YIELD STRENGTH OF 33,000 PSI. BEFORE FORMING, THE STEEL SHEET SHALL RECEIVE A PROTECTIVE COATING CONFORMING TO ASTM A853, GRADE 90.
- ALL METAL DECK SHALL BE SHORED AS REQUIRED BY PLANS OR BY SPAN AND LOAD CONDITIONS TO SUPPORT WET WEIGHT OF CONCRETE AND ALL CONSTRUCTION LOADS.
- EXCEPT AS OTHERWISE NOTED, EDGE LAPS SHALL BE CONNECTED WITH 3/4" DIA. FUSION WELDS AT A SPACING TO PROVIDE SUFFICIENT DIAPHRAGM STRENGTH TO MAINTAIN BUILDING ALIGNMENT AND TO SUSTAIN LOCAL CONSTRUCTION LOADS WITHOUT DISTORTION OR SEPARATION. MAXIMUM SPACING SHALL BE 3'-0".
- EXCEPT AS OTHERWISE NOTED, DECK SHALL BE ATTACHED TO STRUCTURAL STEEL BY 3/4" DIA. FUSION WELDS @ 12" O.C. AT END AND INTERIOR SUPPORTS PERPENDICULAR TO THE DECK SPAN AND AT EDGE AND INTERIOR SUPPORTS PARALLEL TO THE DECK SPAN. WELDS MAY BE OMITTED IN RIBS IN WHICH SHEAR CONNECTORS ARE TO BE APPLIED, EXCEPT THAT EACH DECK SECTION SHALL HAVE SUFFICIENT WELDS TO ADEQUATELY SECURE THE DECK, BRING THE DECK INTO DIRECT CONTACT WITH THE SUPPORTING STEEL AND TO PROVIDE SUFFICIENT DIAPHRAGM STRENGTH TO MAINTAIN BUILDING ALIGNMENT.

LIGHT GAUGE STEEL FRAMING

- ALL LIGHTWEIGHT STEEL FRAMING WORK SHALL COMPLY WITH THE AISI "SPECIFICATION FOR THE DESIGN OF COLD-FRAME STEEL STRUCTURAL MEMBERS" AS WELL AS ANSI A62.4 AND THE METAL LATH ASSOCIATION "SPECIFICATIONS FOR METAL LATHING AND FURRING."
- ALL PLYWOOD APPLIED TO METAL JOISTS SHALL BE SCREWED AND GLUED TO THE JOISTS. THE ADHESIVE SHALL BE AN APA APPROVED ELASTOMERIC ADHESIVE (B.F. GOODRICH PL400 OR EQUAL).
- INSTALL METAL FRAMING IN ACCORDANCE WITH MANUFACTURER'S WRITTEN INSTRUCTIONS AND RECOMMENDATIONS, UNLESS OTHERWISE INDICATED. ALL MATERIALS SHALL BE GALVANIZED.

SPECIAL INSPECTIONS

- INSPECTIONS REQUIRED BY THE N.Y. CITY BUILDING CODE SHALL BE PERFORMED BY A TESTING AGENCY PROVIDED BY THE OWNER FOR THE FOLLOWING ITEMS:
A. STRUCTURAL STEEL - WELDING (BC 1704.3.1)
B. STRUCTURAL STEEL - ERECTION AND BOLTING (BC 1704.3.2, 1704.3.3)
C. CONCRETE - CAST-IN-PLACE (BC 1704.4)
D. CONCRETE TEST CYLINDERS (BC 1905.6)
E. CONCRETE DESIGN MIX (BC 1905.3)
F. MASONRY (BC 1704.5)
LEVEL 1 SPECIAL INSPECTIONS (BC 1606.1704.5.1)
G. SOILS - SITE PREPARATION (BC 1704.7.1)
H. SOILS - FILL PLACEMENT & IN-PLACE DENSITY (BC 1704.7.2, 1704.7.3)
I. FOOTINGS AND FOUNDATIONS (BC 109.3.1)
J. STRUCTURAL SAFETY - STRUCTURAL STABILITY (BC 1704.19)
K. FINAL INSPECTION (DEFECTIVE 14 OF 1975)

THE TESTING AGENCY FOR THE INSPECTIONS SHALL FILE ALL APPROPRIATE FORMS WITH THE BUILDING DEPARTMENT.

PROGRESS INSPECTIONS


- FOOTING AND FOUNDATION (BC 109.3.1)

FRAMING LUMBER

- ALL FRAMING LUMBER WORK SHALL CONFORM TO THE FOLLOWING GOVERNING STANDARDS:
A. AMERICAN INSTITUTE OF TIMBER CONSTRUCTION, "TIMBER CONSTRUCTION MANUAL," LATEST EDITION.
B. NATIONAL FOREST PRODUCTS ASSOCIATION "NATIONAL DESIGN SPECIFICATIONS FOR WOOD CONSTRUCTION," LATEST EDITION.
- FRAMING LUMBER SHALL HAVE EACH PIECE GRADE STAMPED, SHALL BE SURFACED DRY (EXCEPT STUDS, WHICH SHALL BE KILN DRIED) AND SHALL CONFORM TO THE FOLLOWING SPECIES AND GRADE:
RAFTERS AND JOISTS: DOUGLAS FIR-LARCH #2
BEAMS, GIRDERS AND HEADERS: DOUGLAS FIR-LARCH #1
STUDS AND PLATES: DOUGLAS FIR-LARCH, STUD GRADE
- TIMBER LUMBER SHALL CONFORM TO THE FOLLOWING SPECIES AND GRADE:
POST AND TIMBER: DOUGLAS FIR-LARCH #1
BEAMS AND STRINGERS: DOUGLAS FIR-LARCH #1
- PRESERVATIVE TREATED WOOD: PROVIDE TREATED LUMBER COMPLYING WITH AWPS-2 AT SILL PLATE AND ALL LUMBER IN CONTACT WITH CONCRETE OR MASONRY.
- ALL WOOD FRAMING INCLUDING DETAILS FOR BRIDGING, BLOCKING, FIRE STOPPING, ETC., SHALL CONFORM TO THE LATEST EDITION OF THE "NATIONAL DESIGN SPECIFICATION FOR WOOD CONSTRUCTION" AND ITS SUPPLEMENTS AND SHALL BE INSTALLED IN ACCORDANCE WITH THE NFPA "MANUAL FOR HOUSE FRAMING."
- FASTENING SHALL BE IN ACCORDANCE WITH THE MOST RESTRICTIVE OF: THE INTERNATIONAL BUILDING CODE, (LATEST EDITION) OR THE MANUFACTURER'S RECOMMENDED FASTENING SCHEDULES.
- ALL FLUSH FRAMED CONNECTIONS SHALL BE MADE WITH APPROVED GALVANIZED STEEL JOIST OR BEAM HANGERS, MINIMUM 18 GAUGE, INSTALLED ACCORDING TO MANUFACTURER'S RECOMMENDATIONS.
- WHERE FRAMING LUMBER IS FLUSH FRAMED TO MICROLATH, STEEL OR FLUTCH-PLATE GIRDER, SET THESE GIRDERS 1/2" CLEAR (MIN.) BELOW TOP OF FRAMING LUMBER, TO ALLOW FOR SHRINKAGE.
- NO NEW OR EXISTING JOISTS SHALL BE CUT OR NOTCHED WITHOUT APPROVAL.

PLYWOOD SHEATHING

- PROVIDE PLYWOOD SHEATHING COMPLYING WITH APA-GRADE STAMPED AND SHALL NOT EXCEED THE SPANS INTENDED FOR USE ON THE STAMP. ALL PLYWOOD SHALL BE MADE WITH EXTERIOR GLUE AND SHALL BE OF THE FOLLOWING THICKNESS:
FLOOR: 3/4"
WALL: 1/2"
ROOF: 5/8"
- ALL PLYWOOD SHALL BE GLUED AND SCREWED TO FLOOR JOISTS USING AN APA APPROVED ADHESIVE (B. F. GOODRICH PL400 OR EQUAL).
- USE PLY CLIPS OR OTHER EDGE SUPPORT AS REQUIRED FOR PLYWOOD SHEATHING.
- LEAVE 1/8" SPACE AT ALL PLYWOOD PANEL END JOINTS AND 1/8" SPACE AT ALL PANEL EDGE JOINTS.

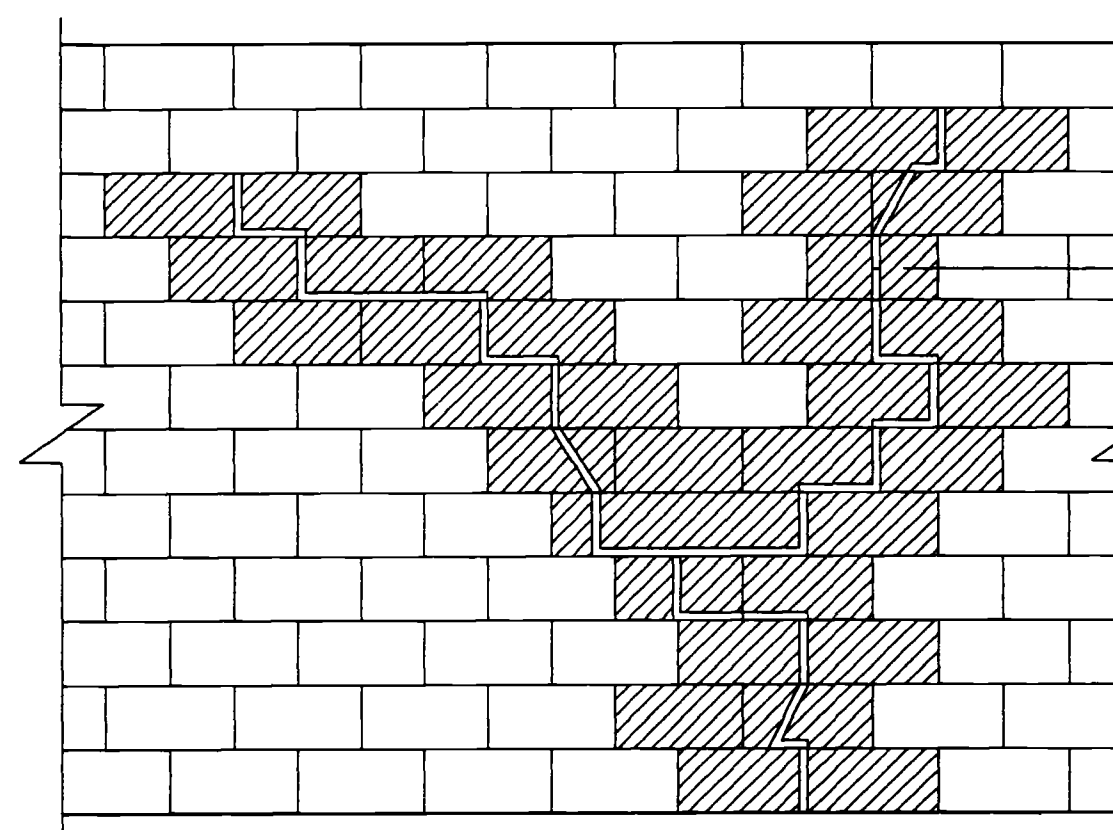


NOTES:


- DENOTES BRICK TO BE REPLACED, WHERE CRACK IS THRU WALL, REPLACE ALL WYTHES OF BRICK ON EACH SIDE OF CRACK TO THE MORTAR JOINT. REPLACE EXISTING HEADERS WITH NEW HEADERS. REPLACE LOOSE AND CRACKED BRICKS, WHERE CRACK IS ONLY IN OUTER WYTHE, REPLACE ONLY OUTER WYTHE.
- WHERE CRACK IS OPEN AND 1/2" OR LESS AND IS PRESENT ONLY IN THE OUTER WYTHE AND ONLY IN JOINTS, RAKE AND REPOINT JOINTS ONLY.

REPAIR IN BRICK MASONRY TYPICAL DETAIL


1 S201

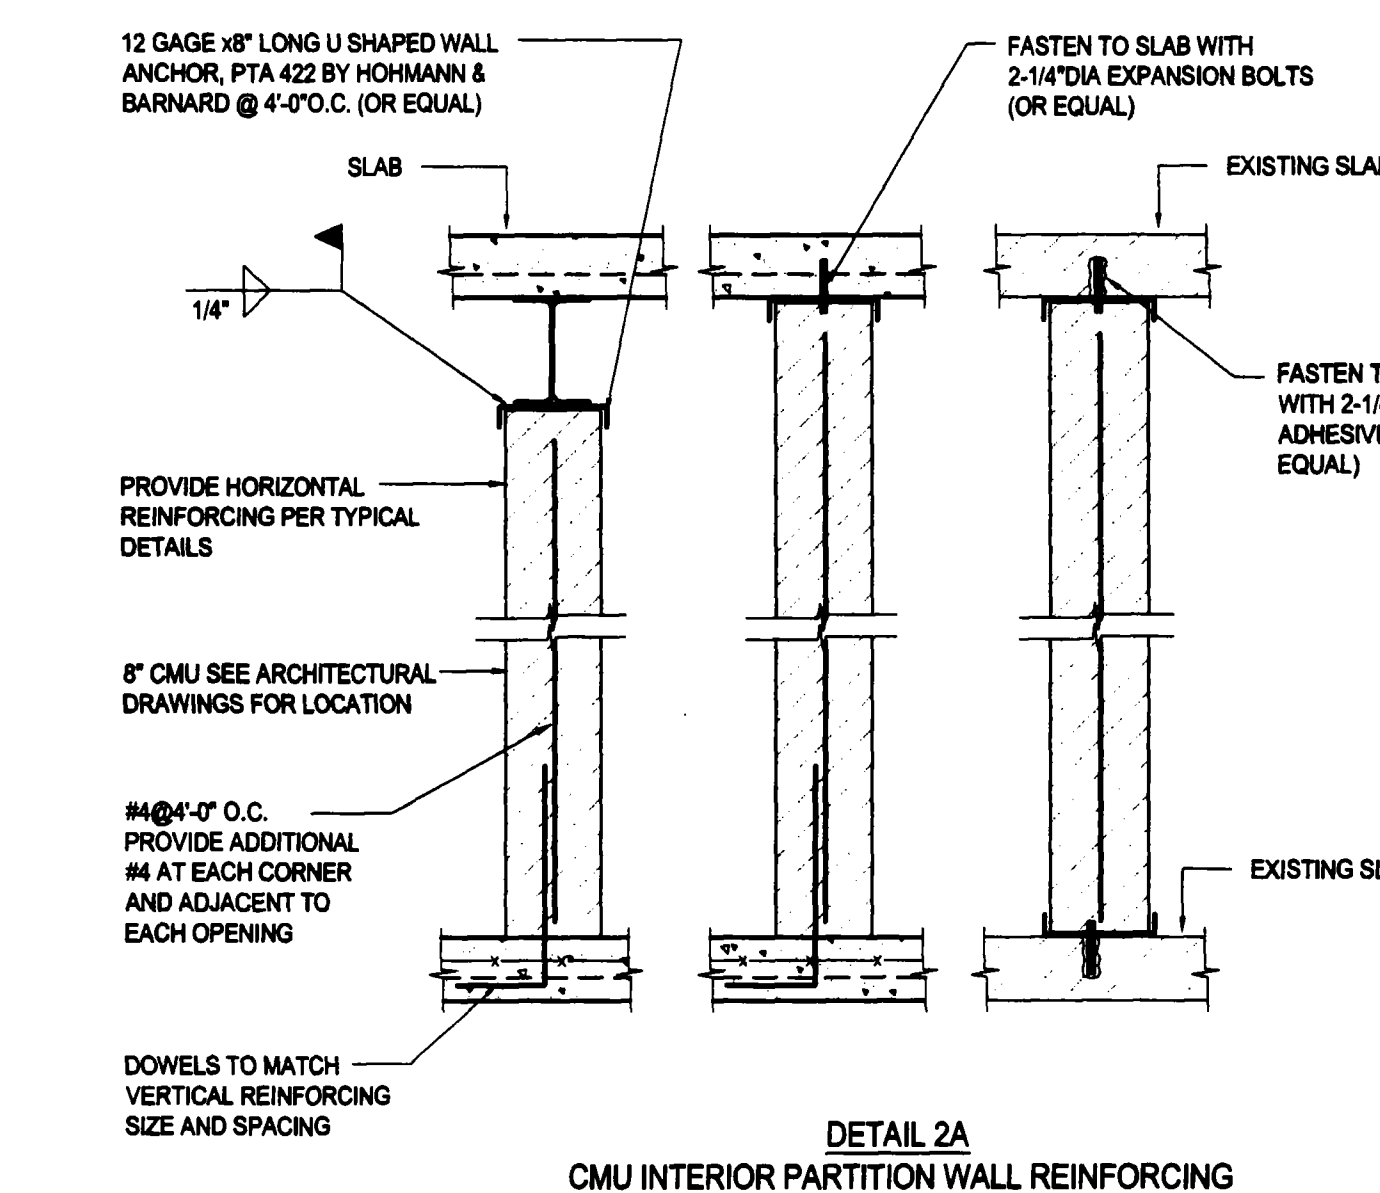


**DETAIL 2A
CMU INTERIOR PARTITION WALL REINFORCING**

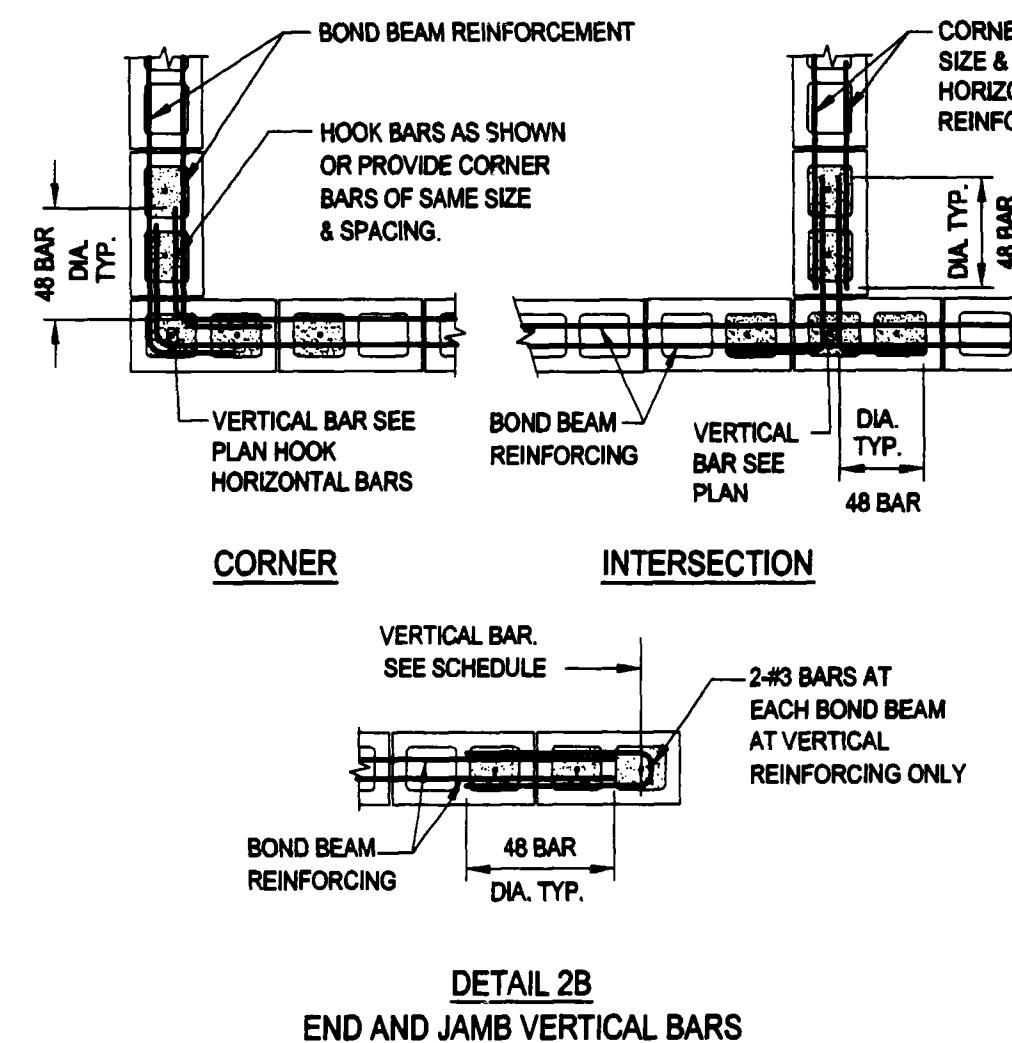

**DETAIL 2B
END AND JAMB VERTICAL BARS AND BOND BEAM DETAILS**

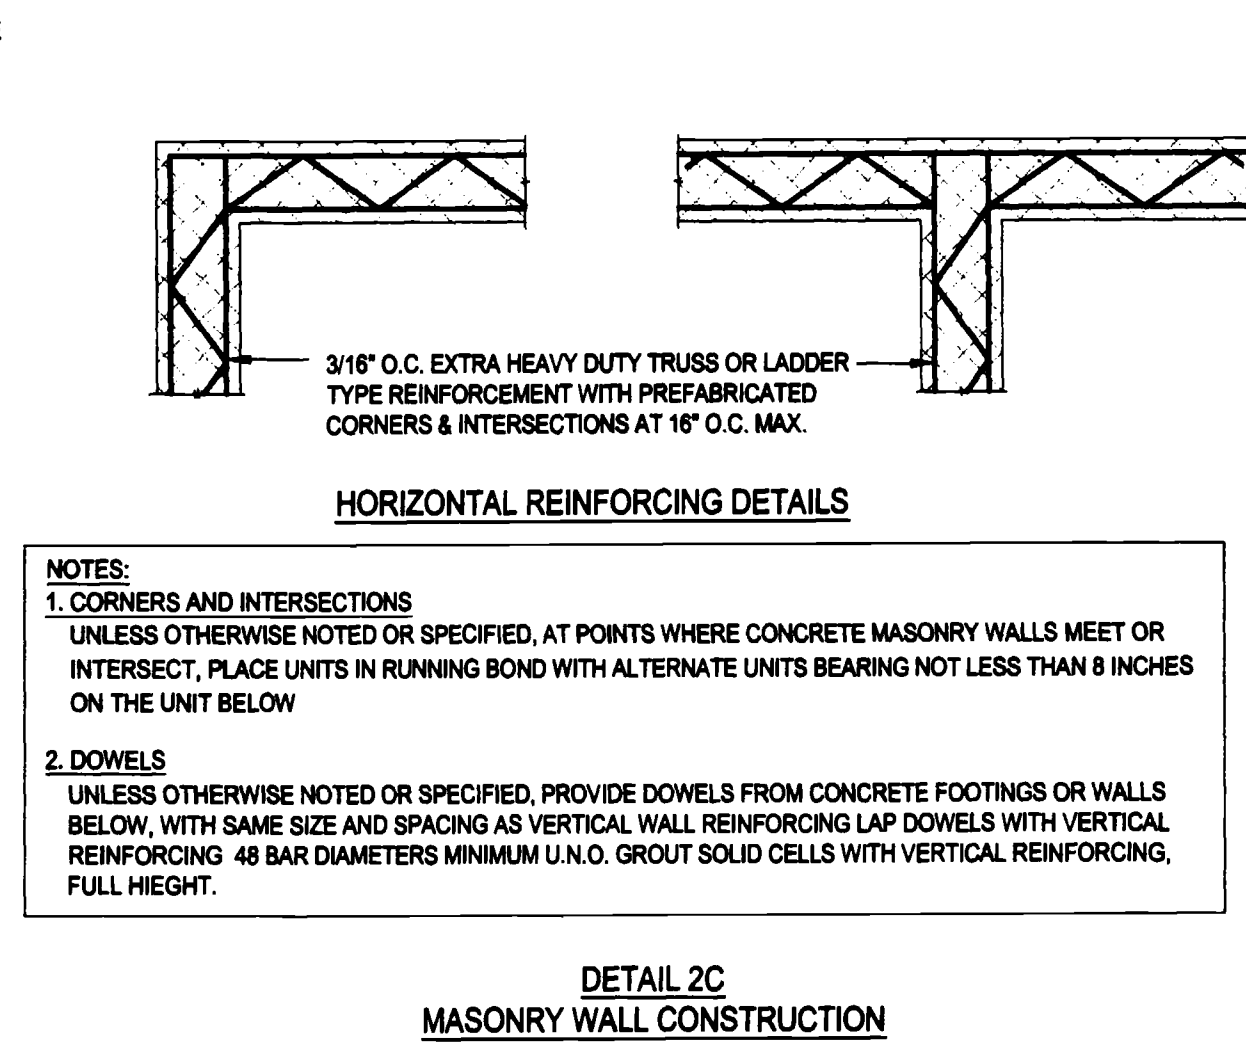


**DETAIL 2C
MASONRY WALL CONSTRUCTION**

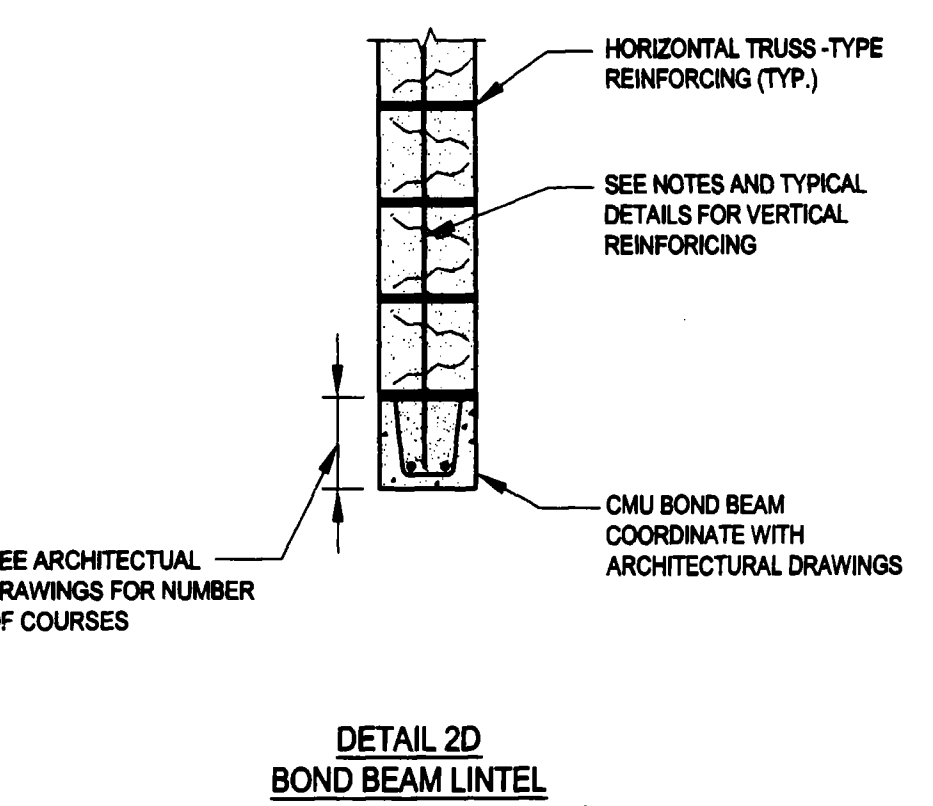


**DETAIL 2D
BOND BEAM LINTEL AT CMU PARTITION WALLS**

CMU PARTITION WALL TYPICAL DETAILS


2 S201

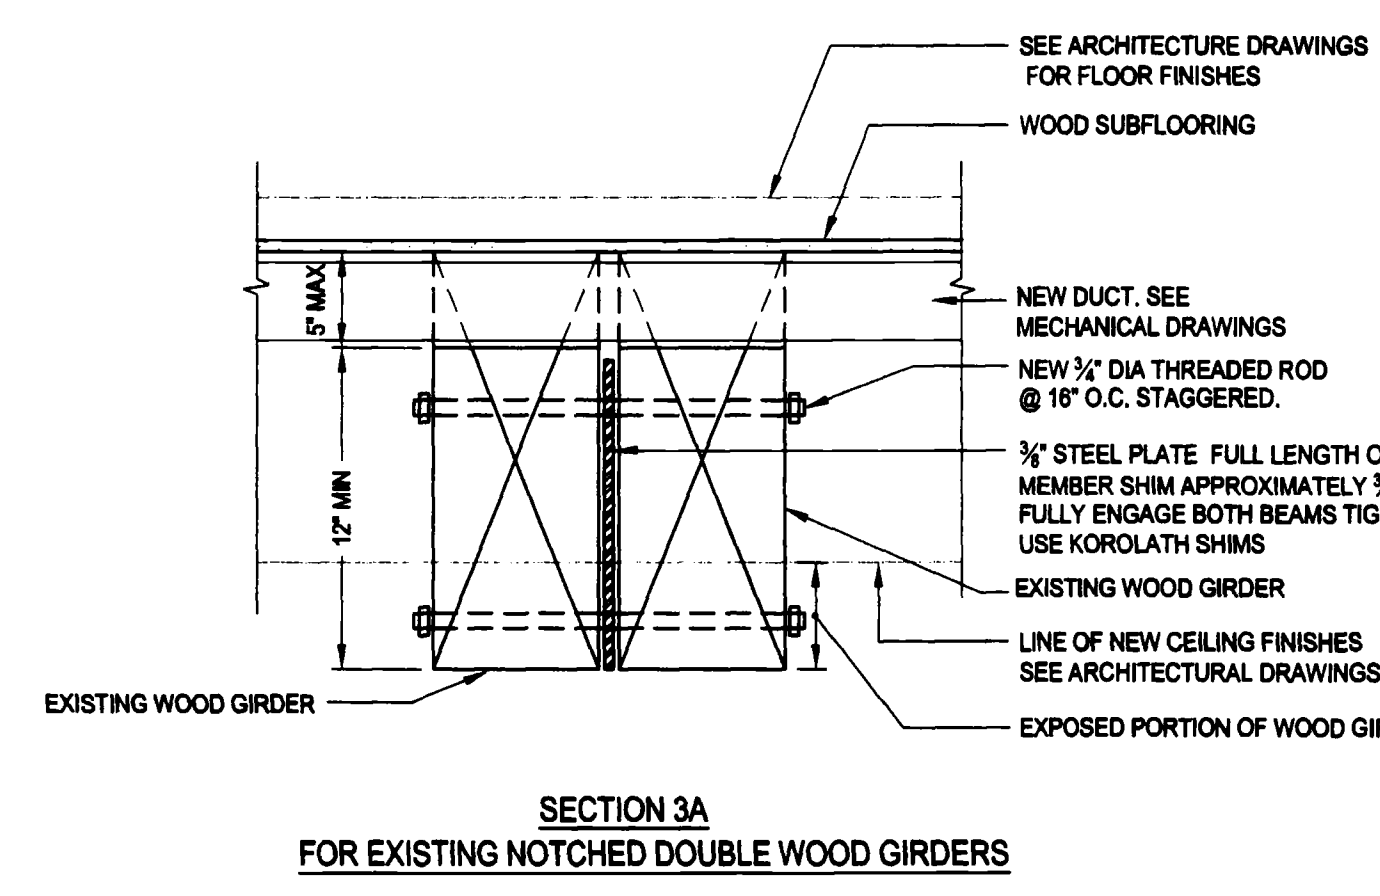


**SECTION 3A
FOR EXISTING NOTCHED DOUBLE WOOD GIRDERS**

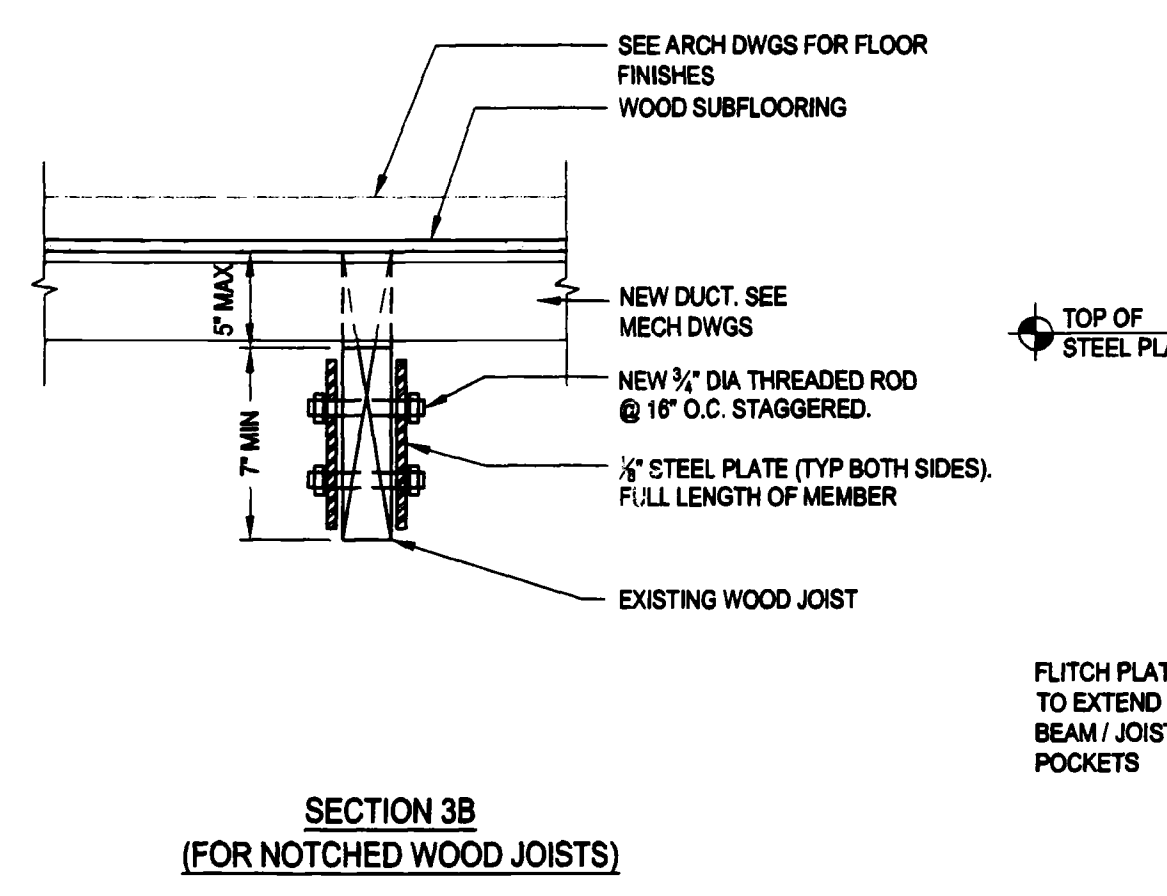

**SECTION 3B
(FOR NOTCHED WOOD JOISTS)**

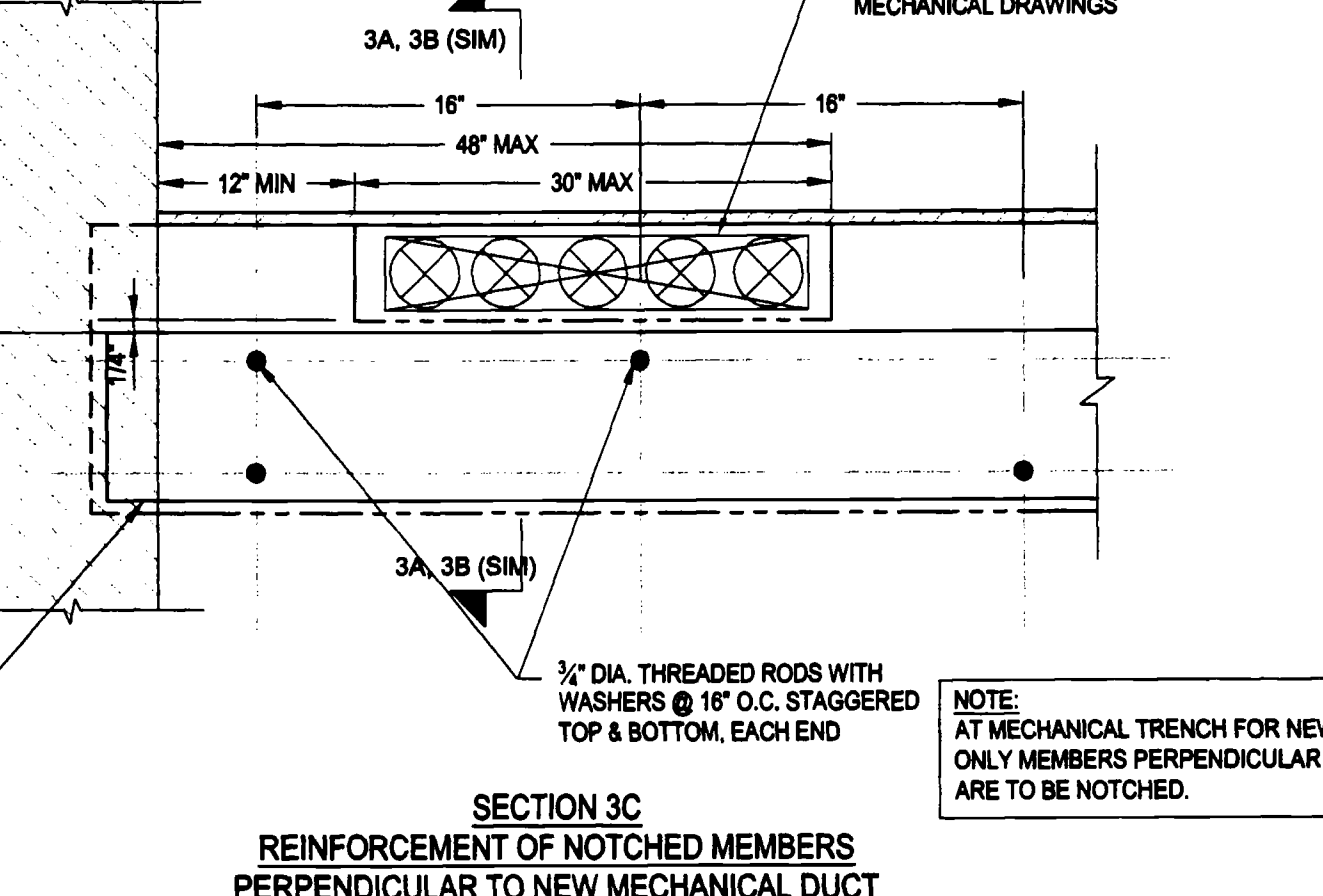


**SECTION 3C
REINFORCEMENT OF NOTCHED MEMBERS PERPENDICULAR TO NEW MECHANICAL DUCT**

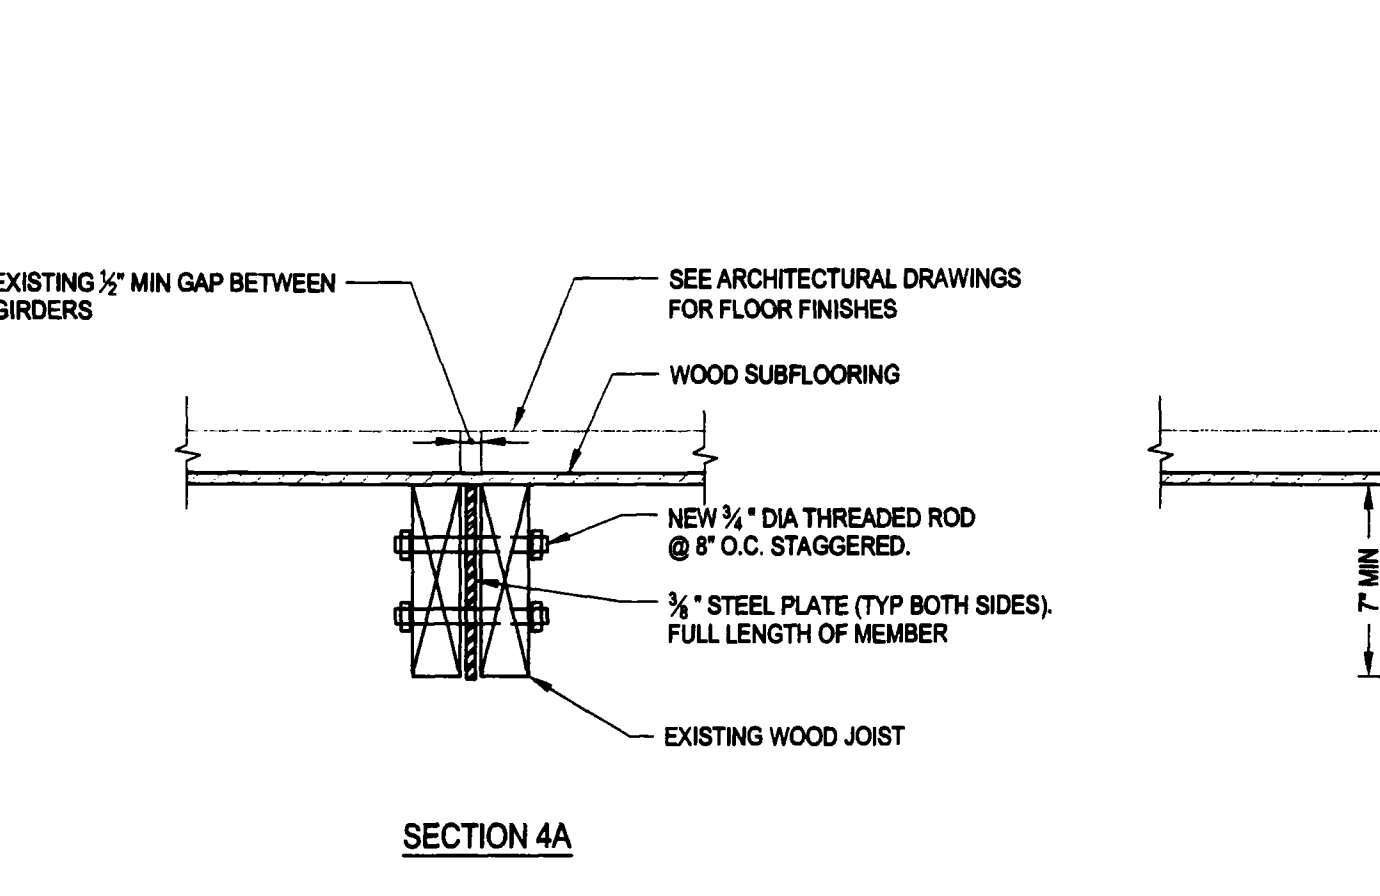


FLITCH PLATE BEAM TYPICAL DETAILS AT REINFORCED MEMBERS

4 S201

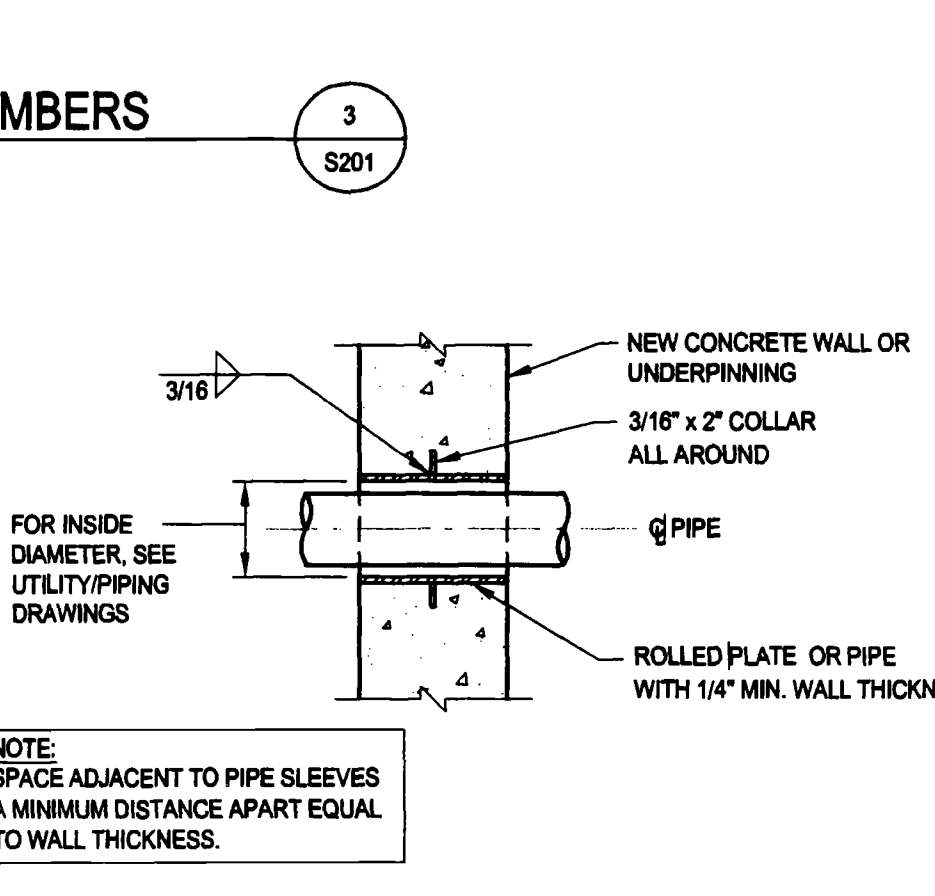


TYPICAL DETAIL PIPE SLEEVE IN EXISTING CONCRETE WALL

5 S201

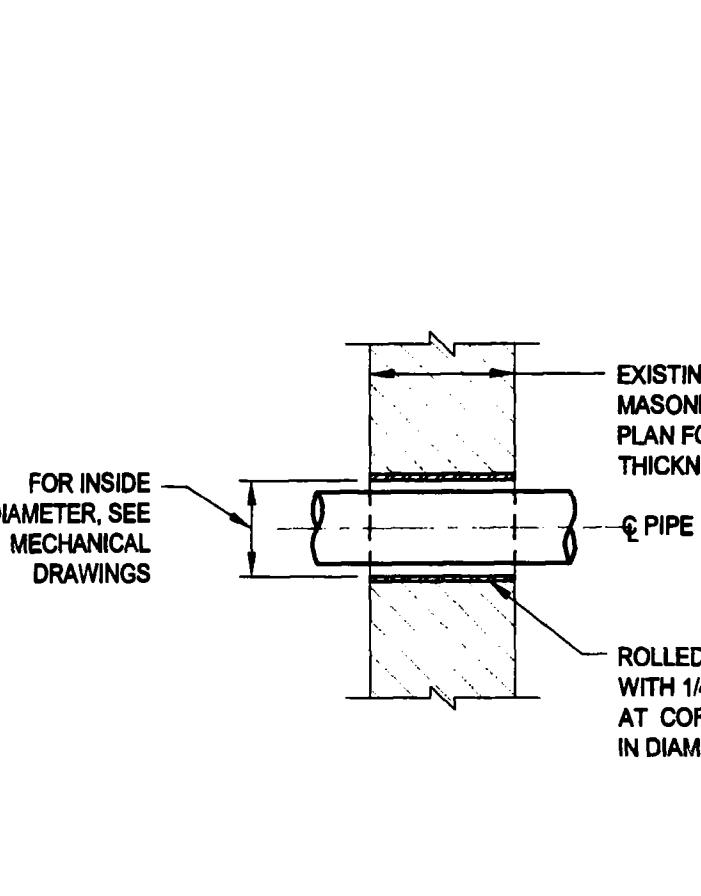

TYPICAL DETAIL PIPE SLEEVE IN EXISTING MASONRY

6 S201

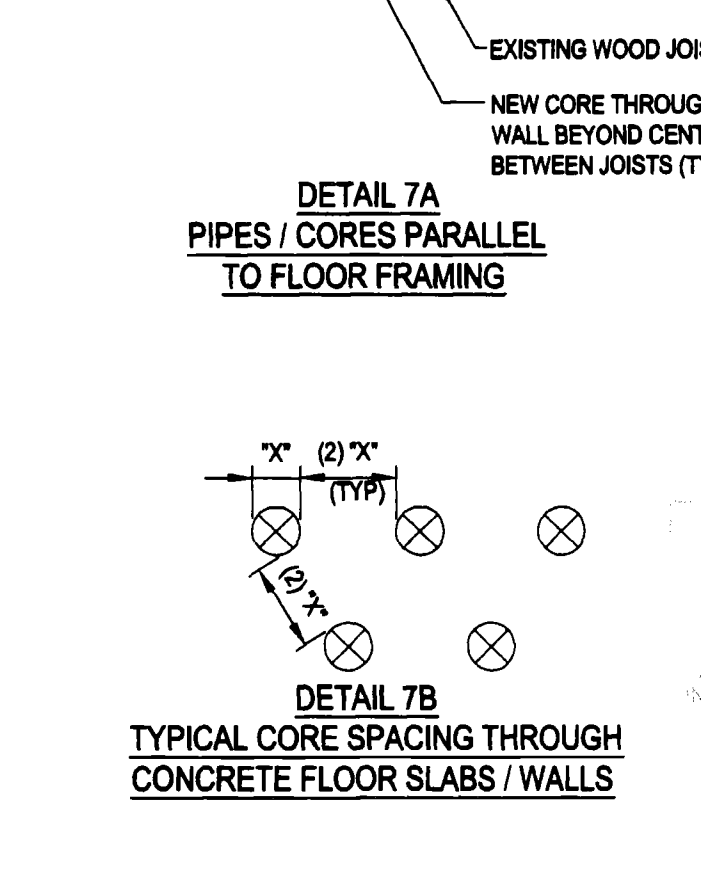

CORES THROUGH SLAB AND WALL TYPICAL DETAILS

7 S201



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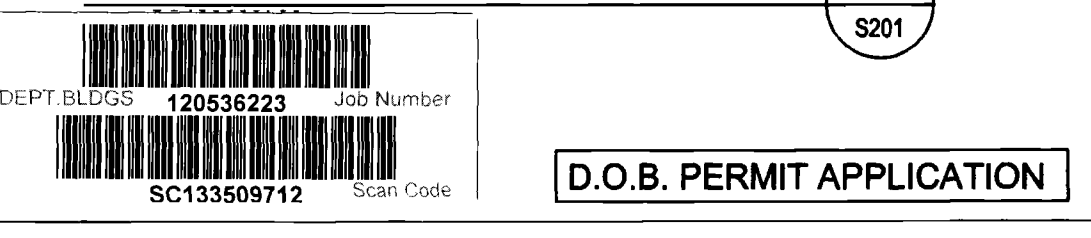
FOR THE:


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General Notes and Typical Details

DRAWN BY: SL SCALE: 1/8" = 1'-0"
CHECKED BY: JUM DATE: 10.08.10


DRAWING NUMBER:
S201.00

SHEET NUMBER:
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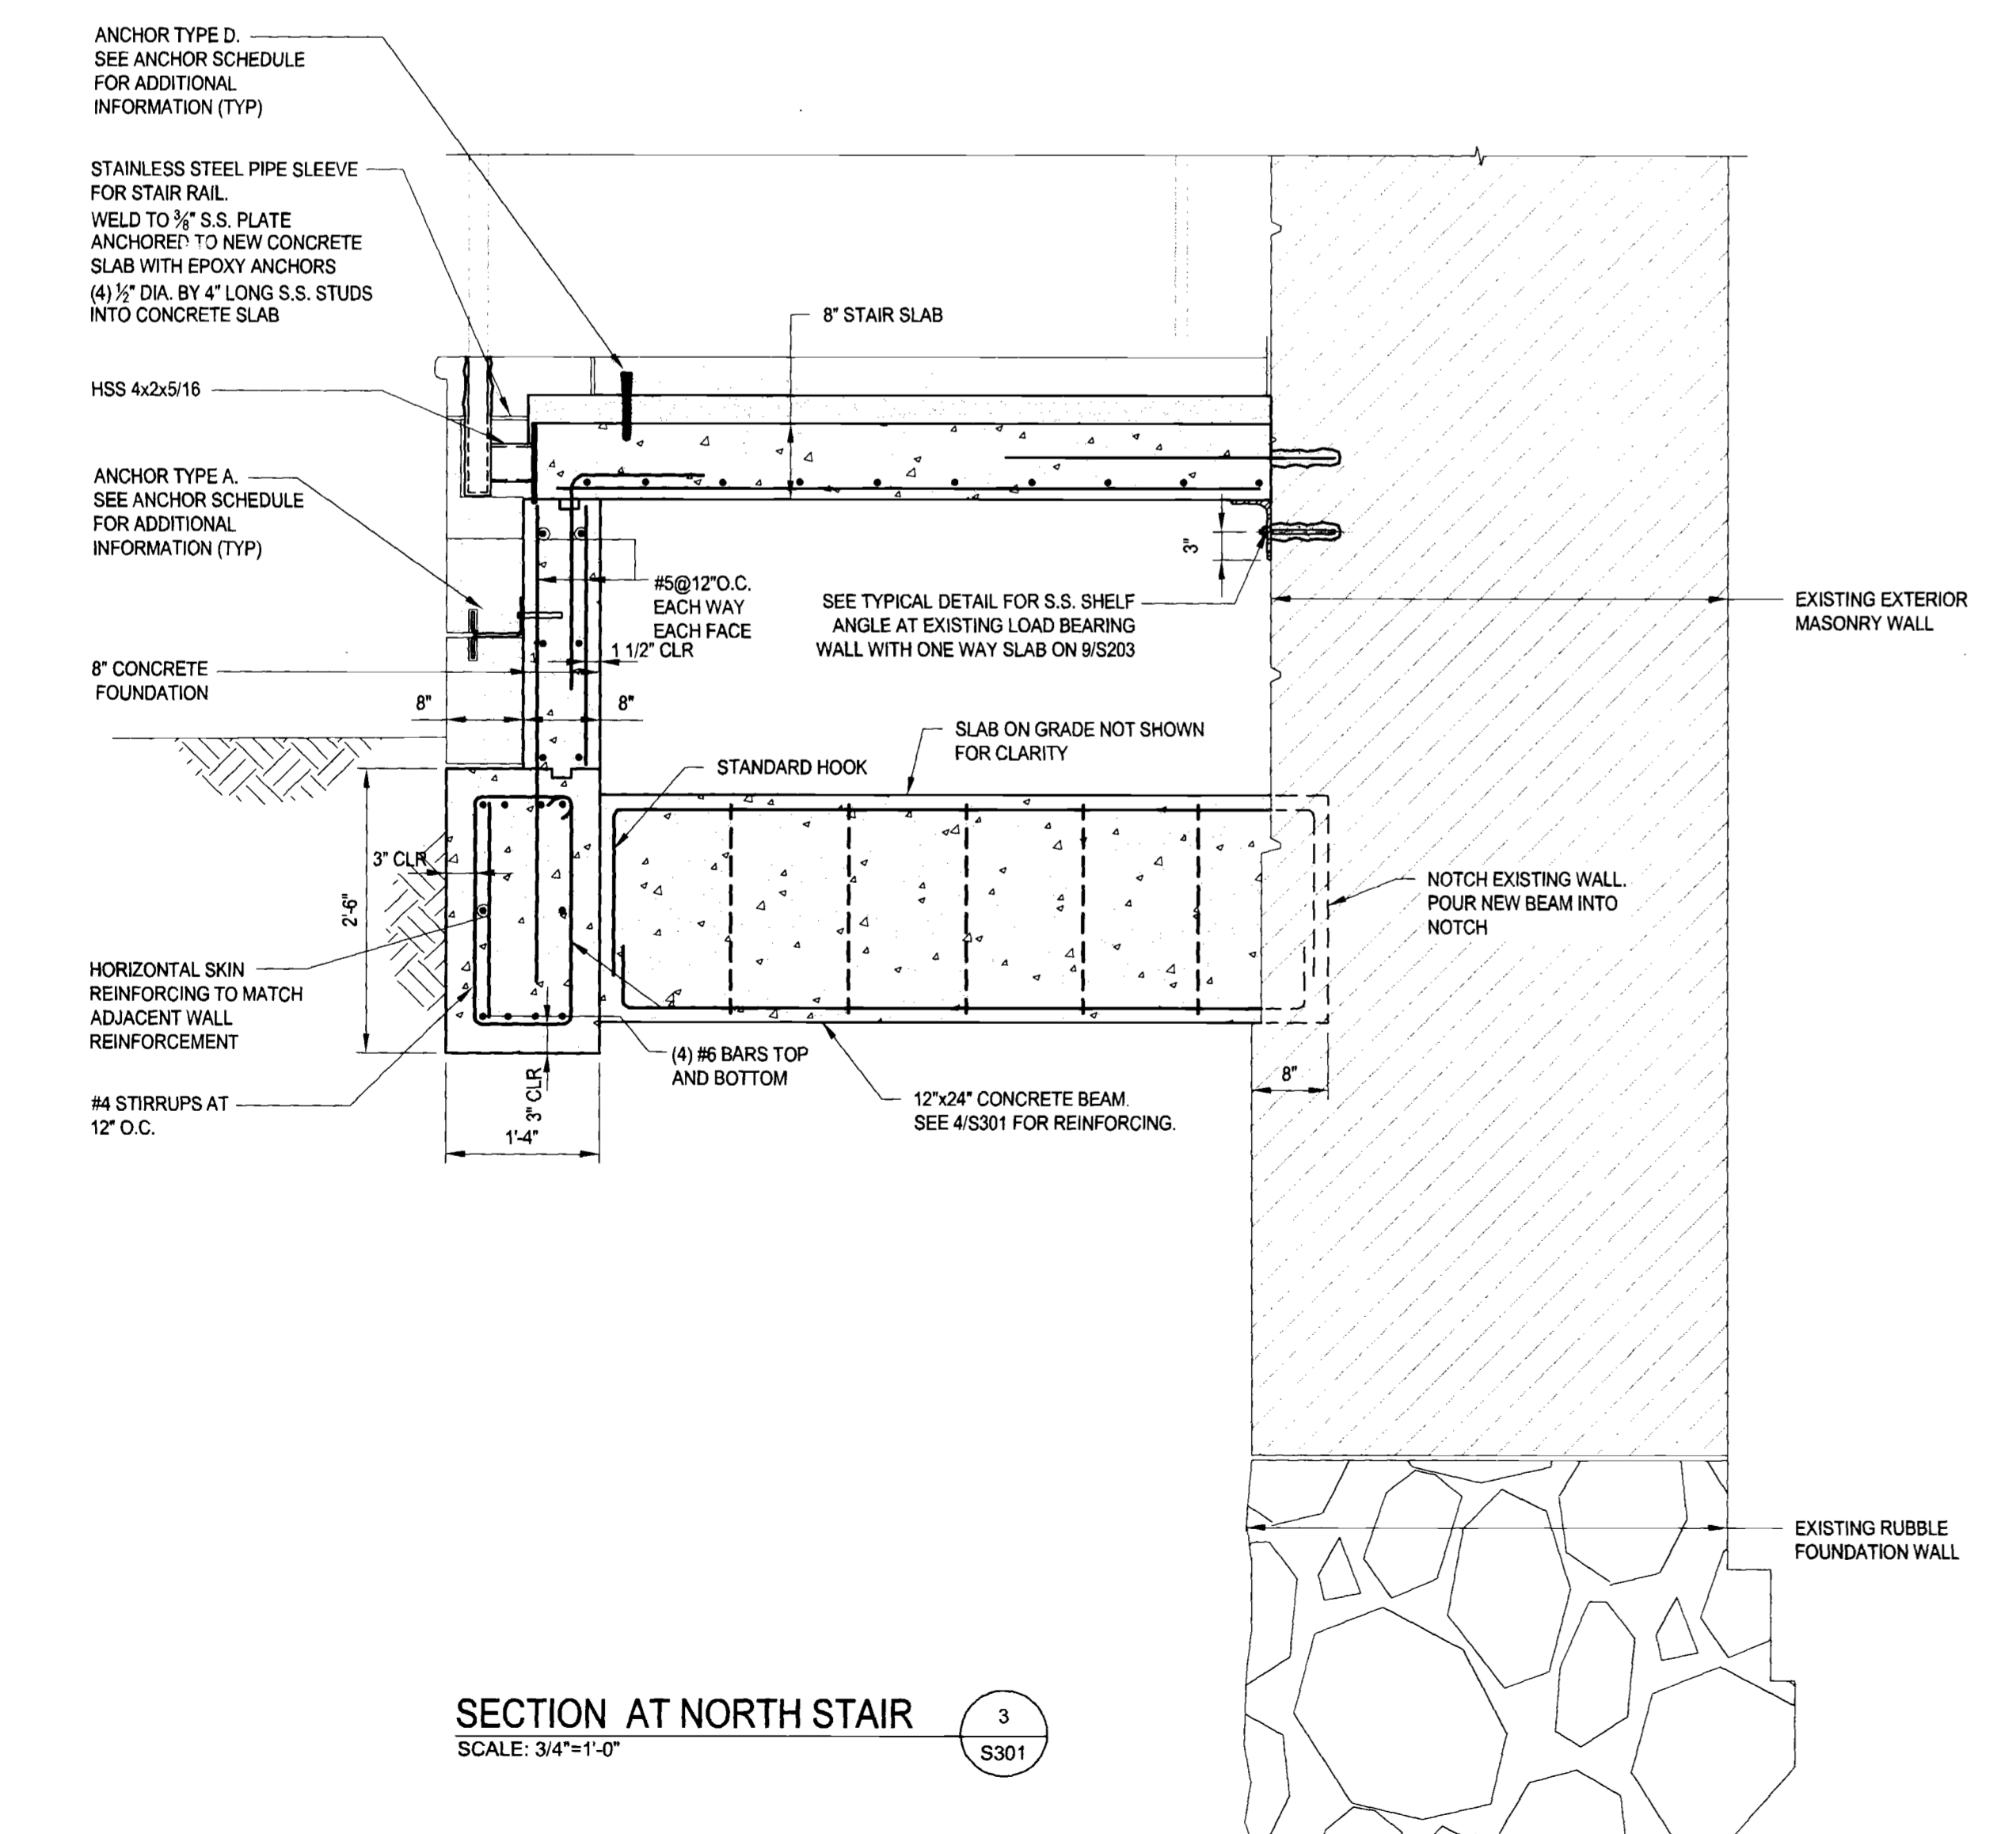


SECTION AT NORTH STAIR
 SCALE: 3/4"=1'-0"

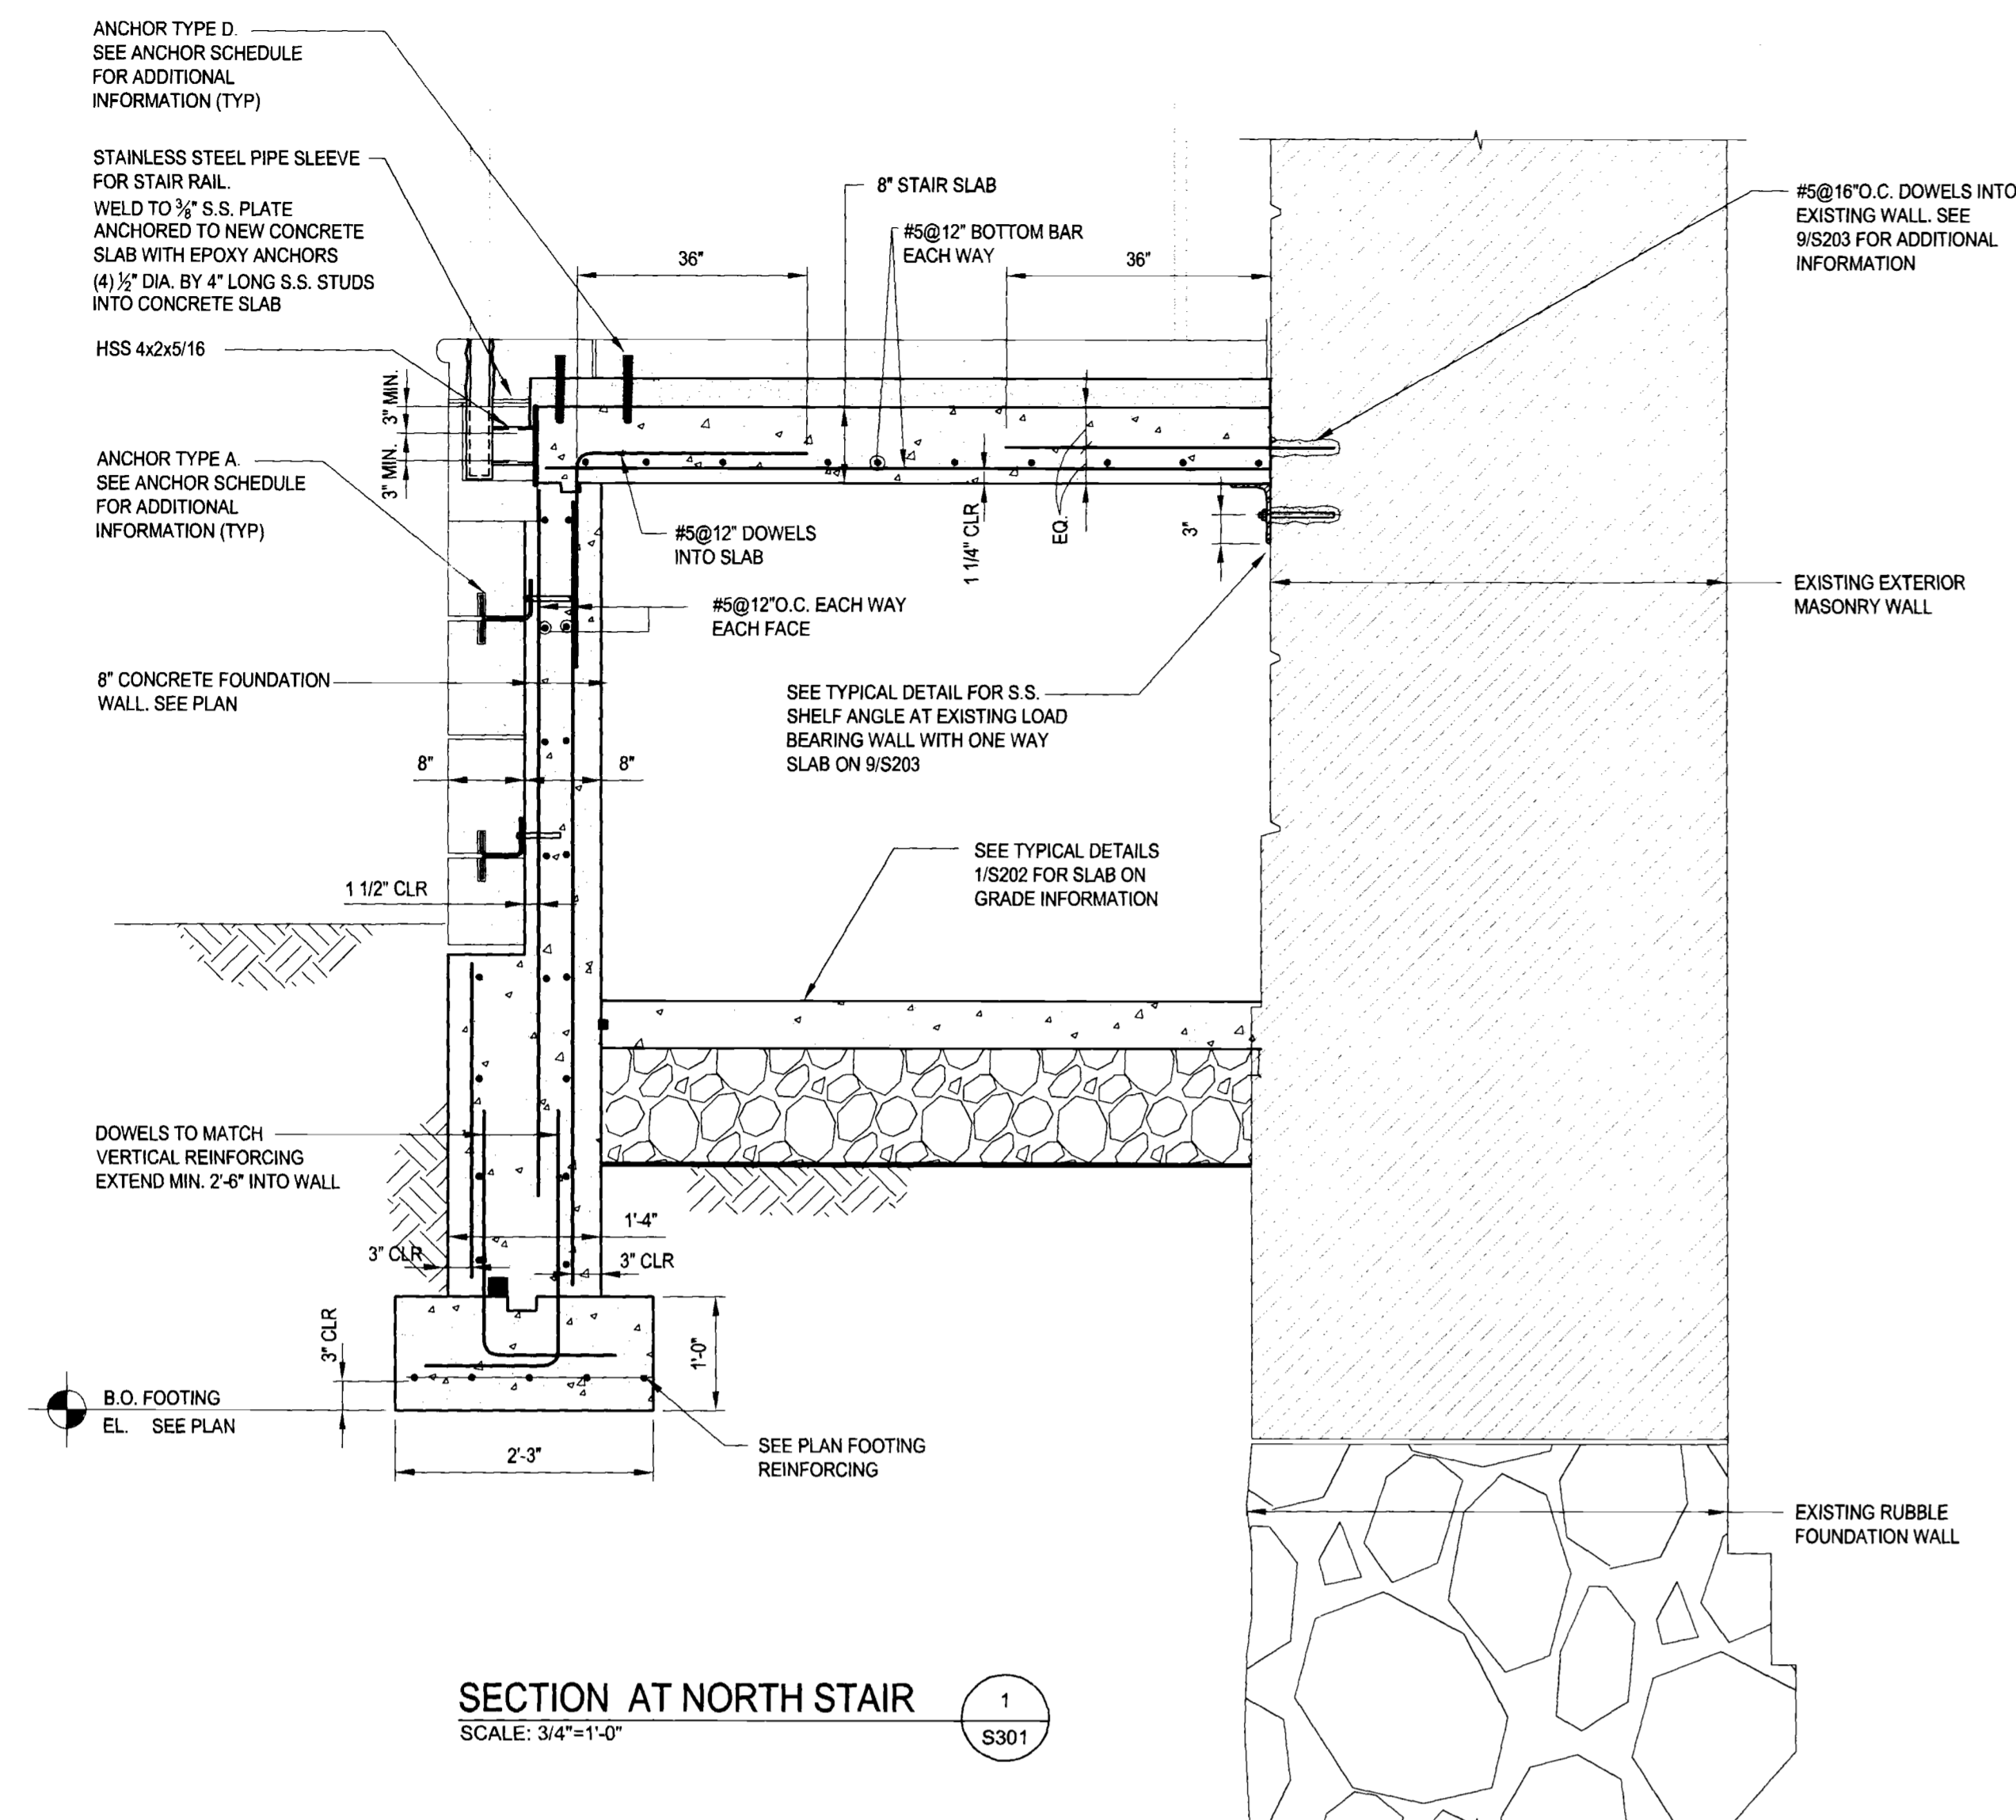


SECTION AT NORTH STAIR
 SCALE: 3/4"=1'-0"

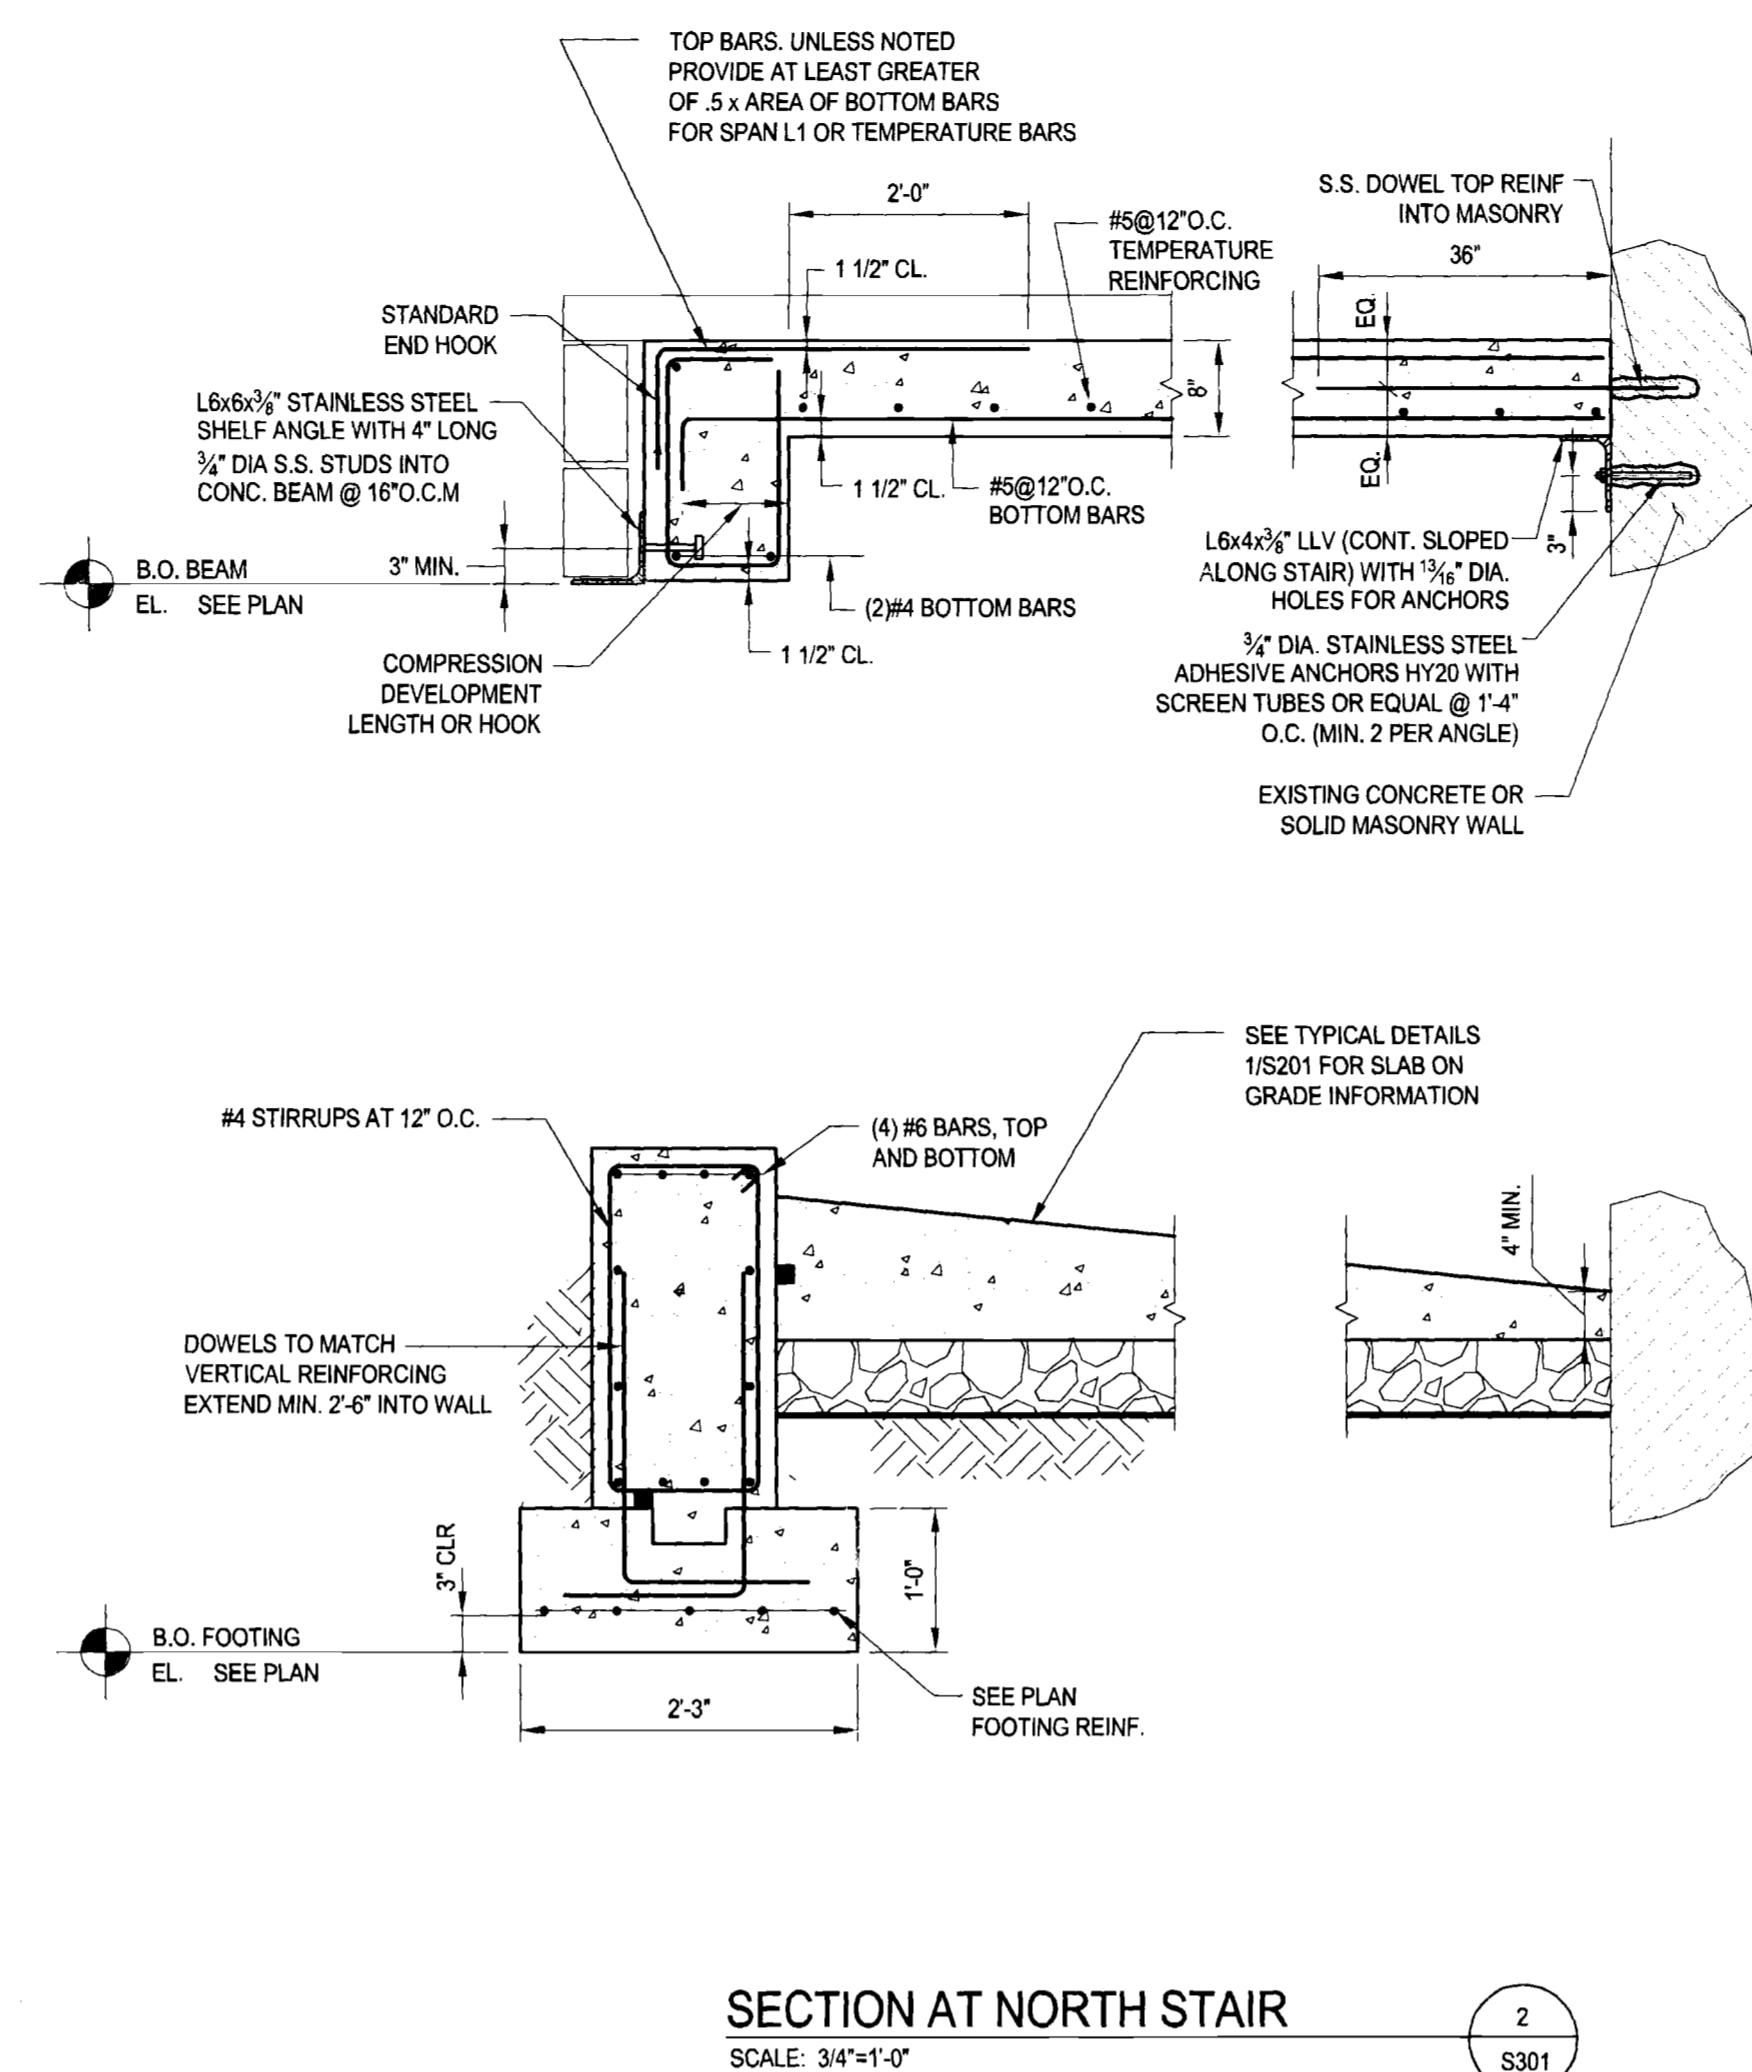ANCHOR SCHEDULE FOR NORTH STAIR				
TYPE	NAME	ANCHOR	SKETCH	DESCRIPTION
A	SPLIT-TAIL STRAP - FASTENER - DOVETAIL - GRIP-STAY	HB307 HB435		1/2" (3) x 2" (3) STRAP WITH 1" (2) SPLIT BEND, SECURED BY 3/4" (1) VERTICAL LEG (V), DOVETAIL (D), OR GRIP-STAY (G). (NOT SHOWN) LENGTH VARIES. FASTEN TO MASONRY WITH ANCHOR AS LISTED IN TABLE A-2. PROVIDE 2 (MIN.) PER STONE, U.O.N.
B	SINGLE OR DOUBLE-BEND STRAP - FASTENER, HORIZ. - FASTENER, VERT. - DOVETAIL OR - GRIP-STAY	HB304 HB450 HB441 HB444		1/2" (3) x 1" (2) STRAP WITH 1" (2) BEND DOWN (W) OR UP (P), SECURED BY HORIZONTAL LEG AND FASTENER (H), HORIZONTAL LEG (V), 3/4" (1) VERTICAL LEG (V), DOVETAIL (D), OR GRIP-STAY (G). (NOT SHOWN) LENGTH VARIES FOR EACH VARIATION. FASTEN TO MASONRY WITH ANCHOR AS LISTED IN TABLE A-2. PROVIDE 2 (MIN.) PER STONE, U.O.N.
C	CORRUGATED BUCK ANCHOR	VARIES		1/2 GAGE METAL PLACED @ 16" O.C. (40#) EACH WAY TYP. U.O.N. FOR WIDTH DESIGNATION SEE NOTES. TYPICAL WIDTHS: 1 1/2" AND 2" . FASTEN TO MASONRY WITH ANCHOR AS LISTED IN TABLE A-2. PROVIDE 2 (MIN.) PER STONE, U.O.N.
D	THREADED ROD	TYPE 304 STAINLESS STEEL		1/2" (3) x LENGTH VARIES. FASTEN TO MASONRY WITH ADHESIVE ANCHOR AS LISTED IN TABLE A-2. PROVIDE 2 (MIN.) PER STONE, U.O.N.




SECTION AT NORTH STAIR
 SCALE: 3/4"=1'-0"

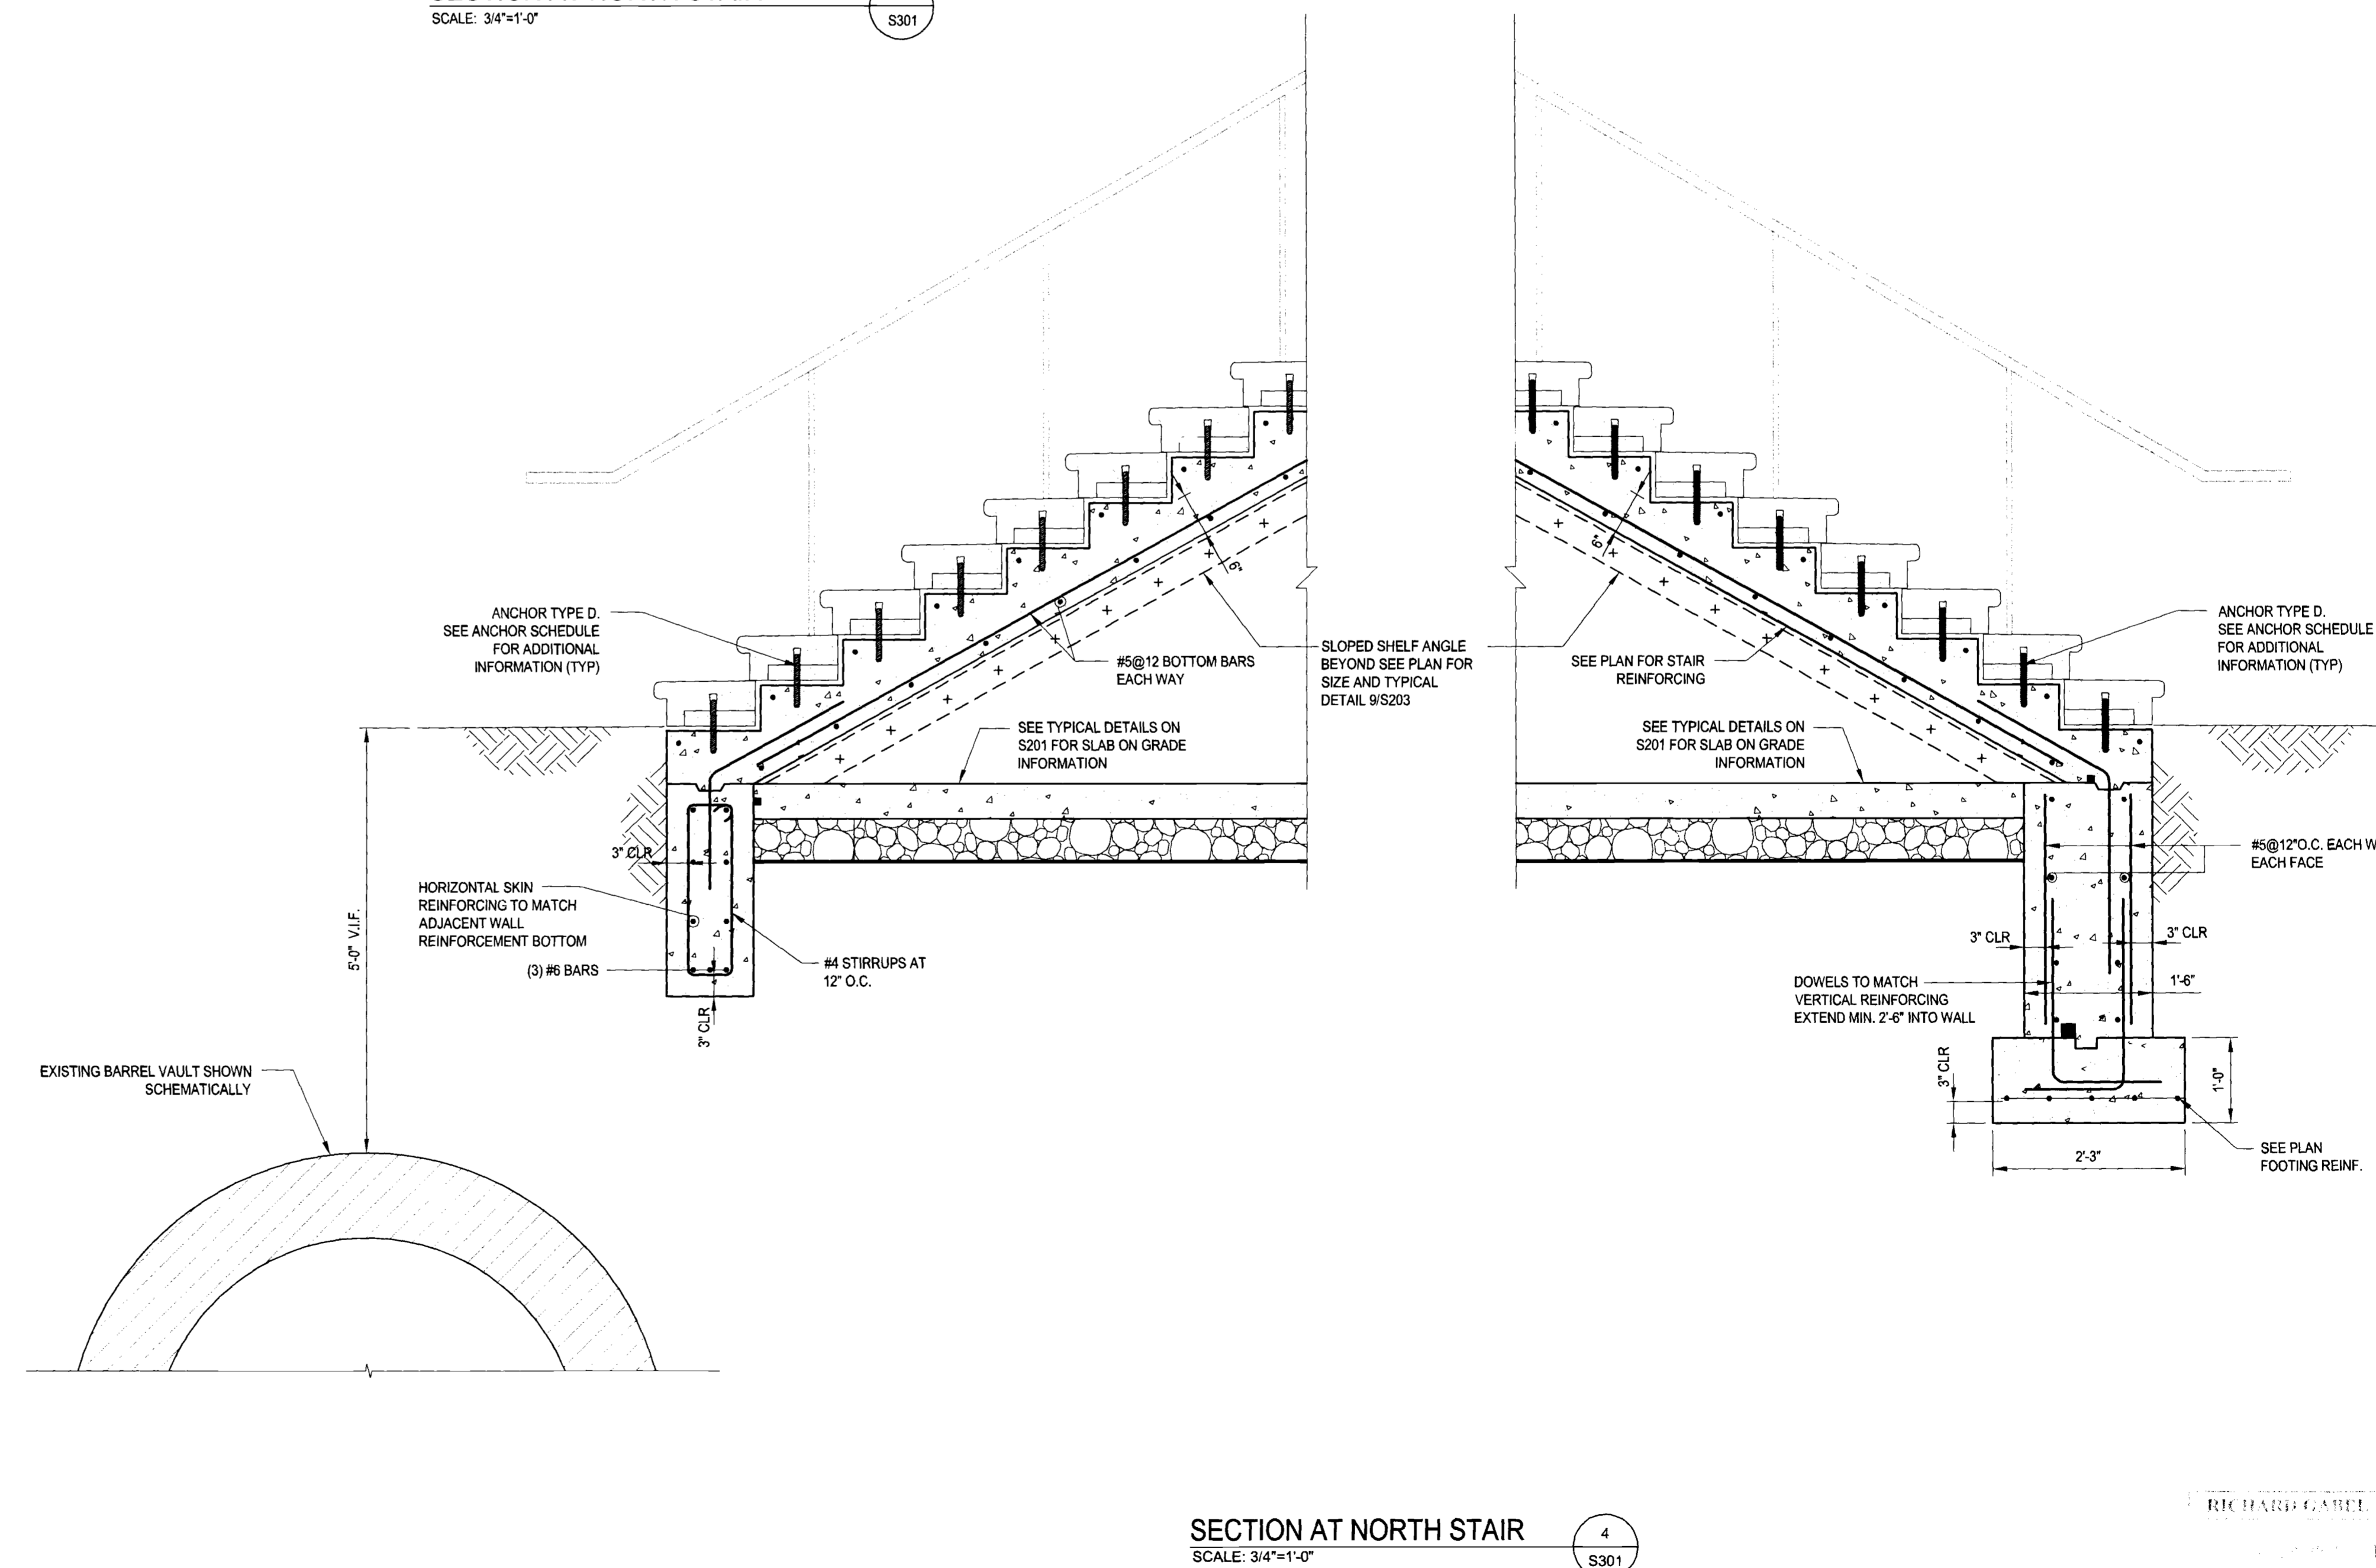

SECTION AT NORTH STAIR
 SCALE: 3/4"=1'-0"

SEAL:

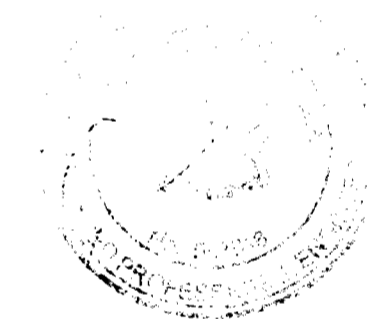

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DRAWING TITLE:

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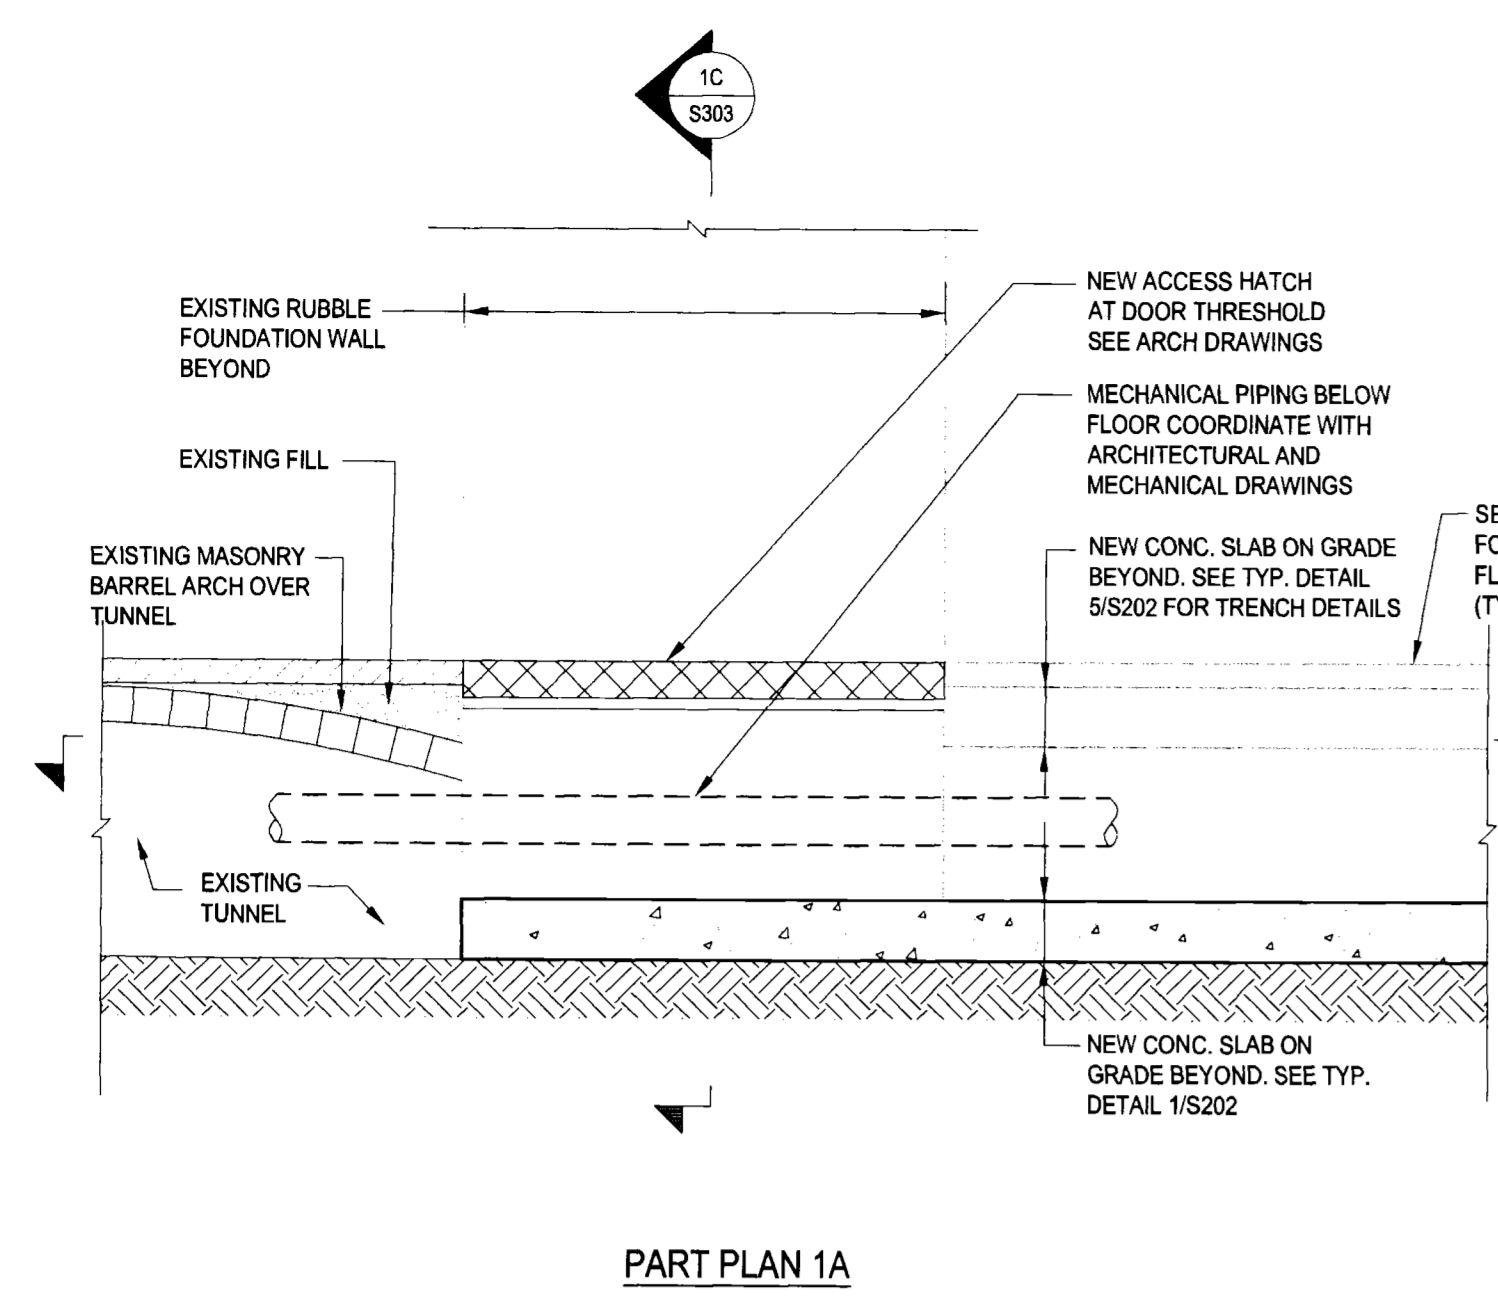
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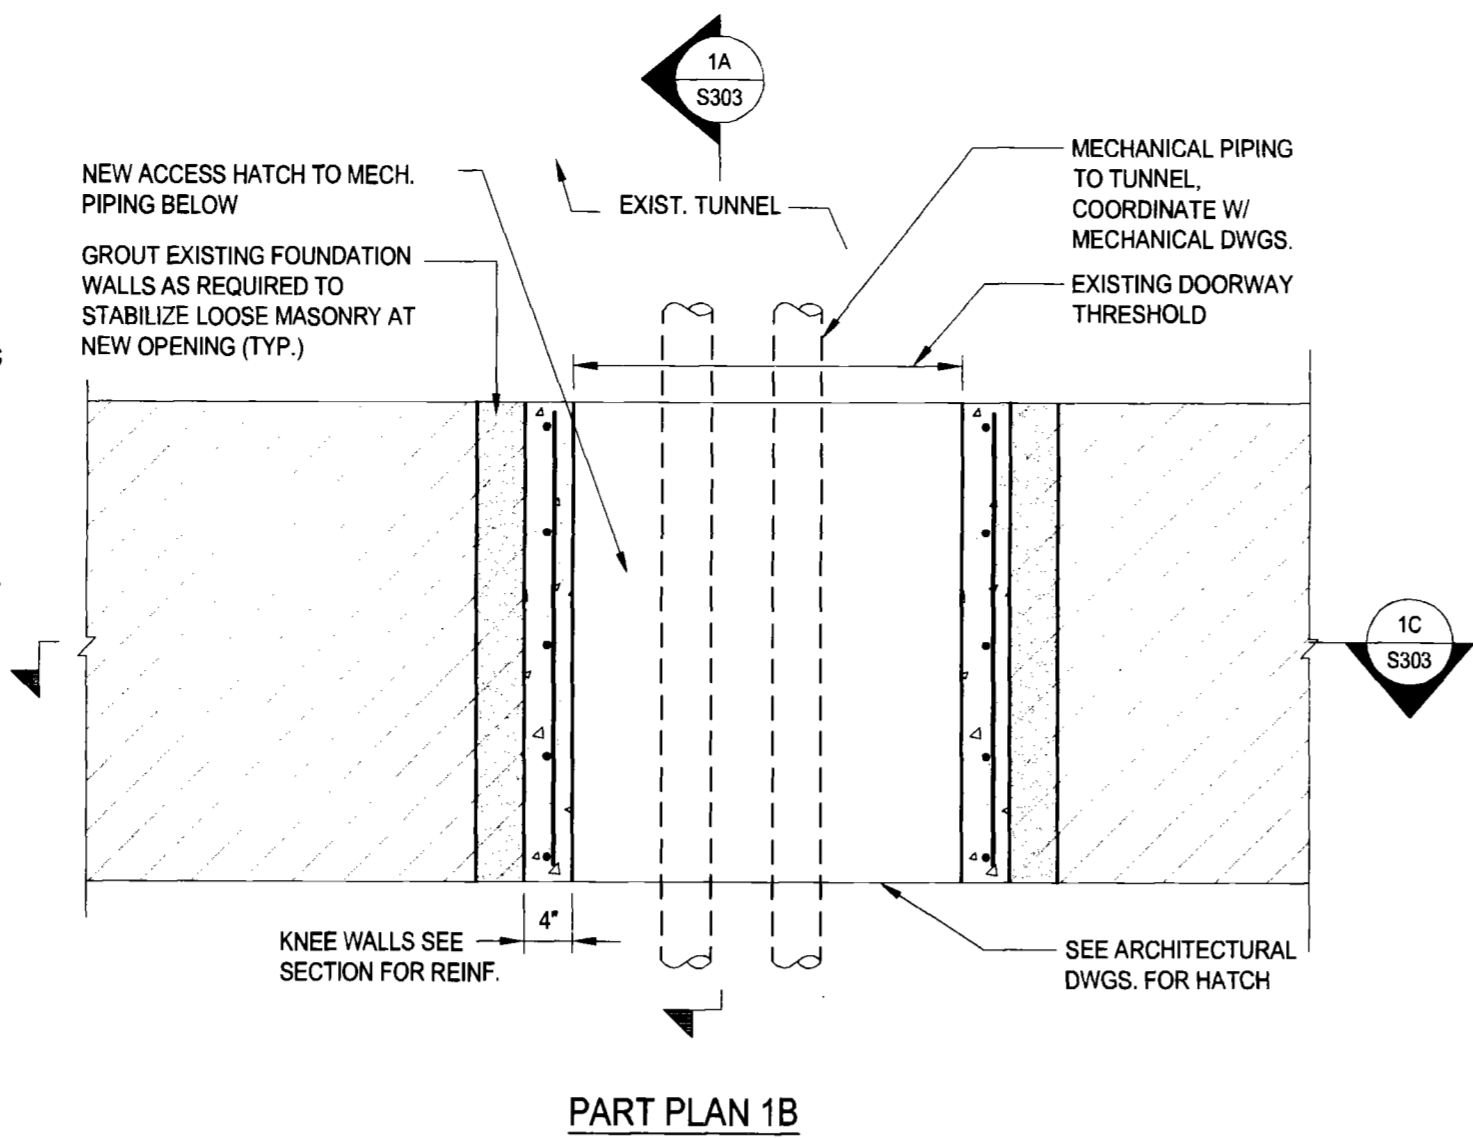
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S301







PART PLAN 1A




PART PLAN 1B

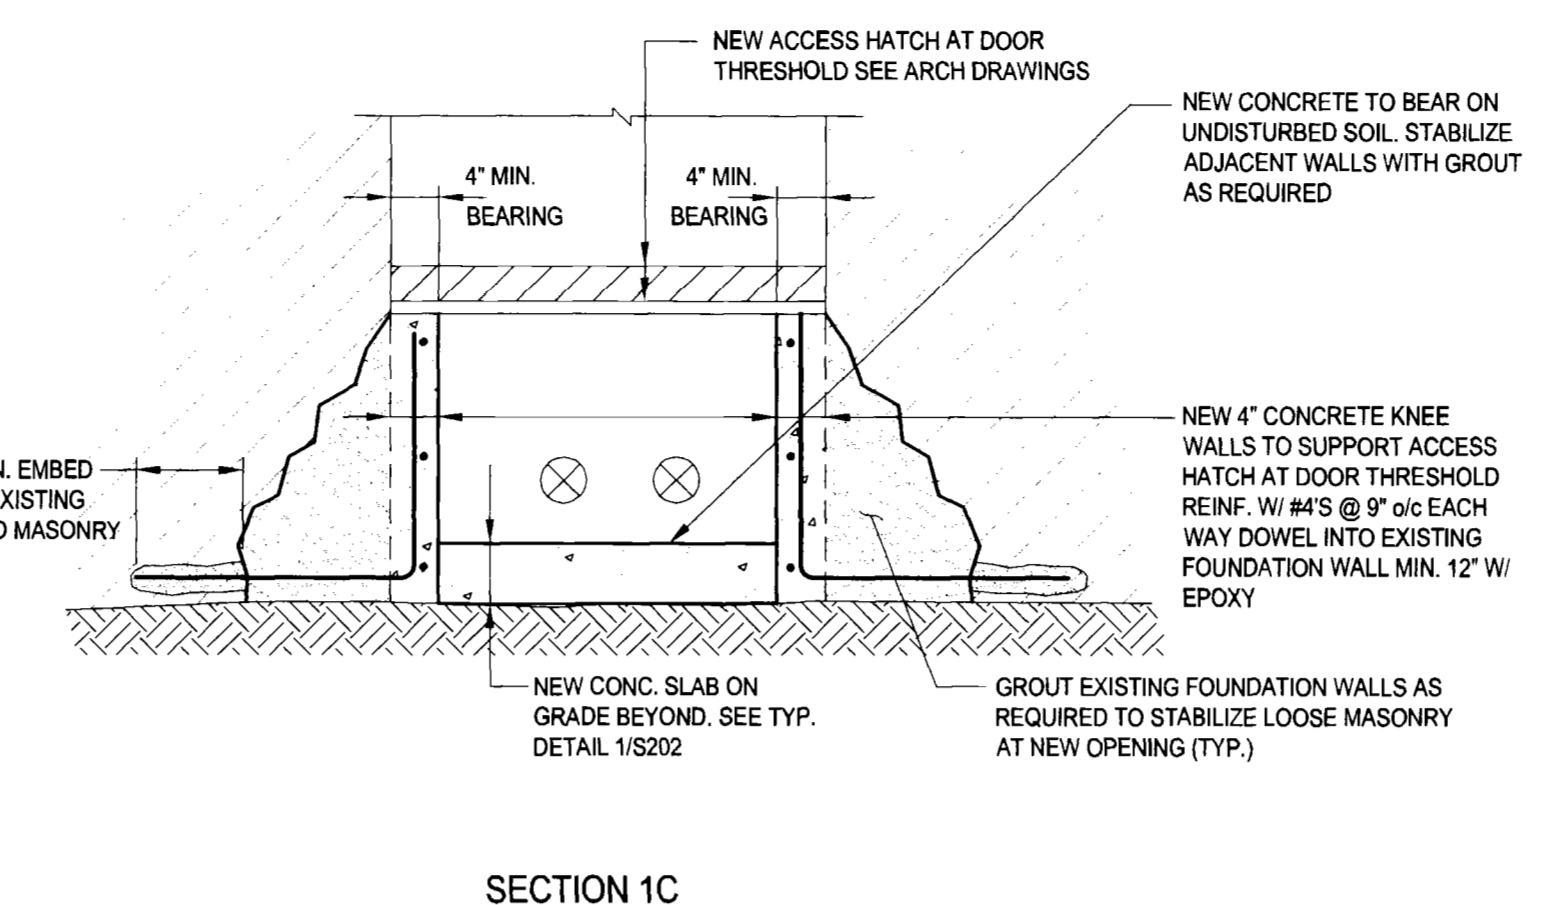

SECTION 1C

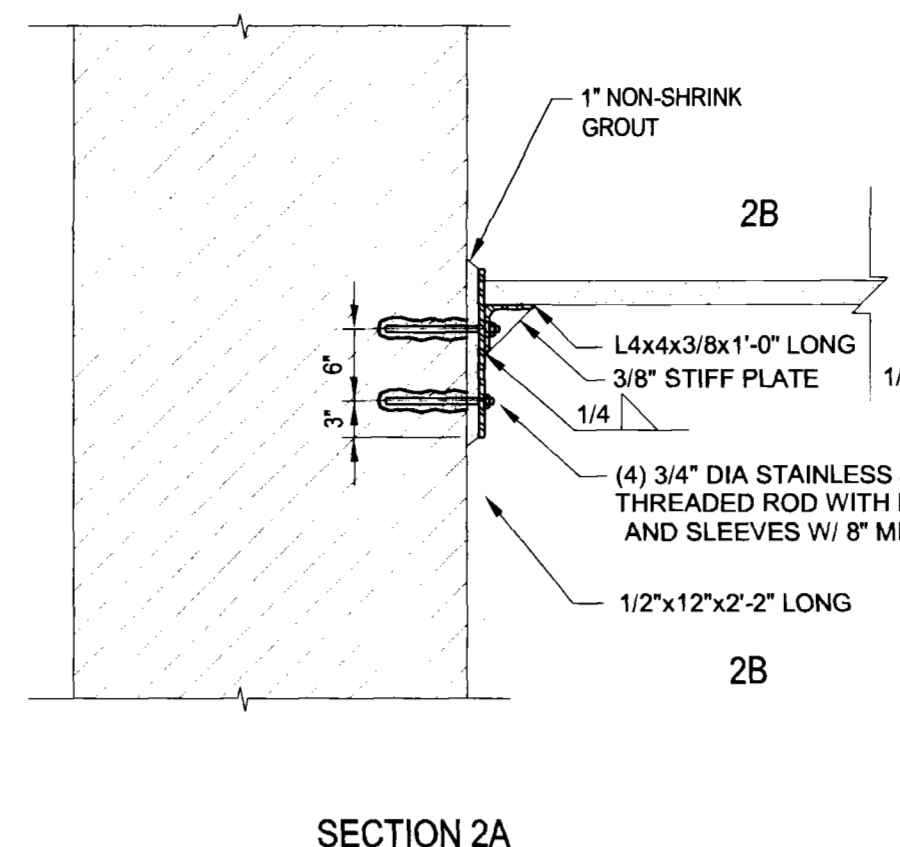


SECTION 2A

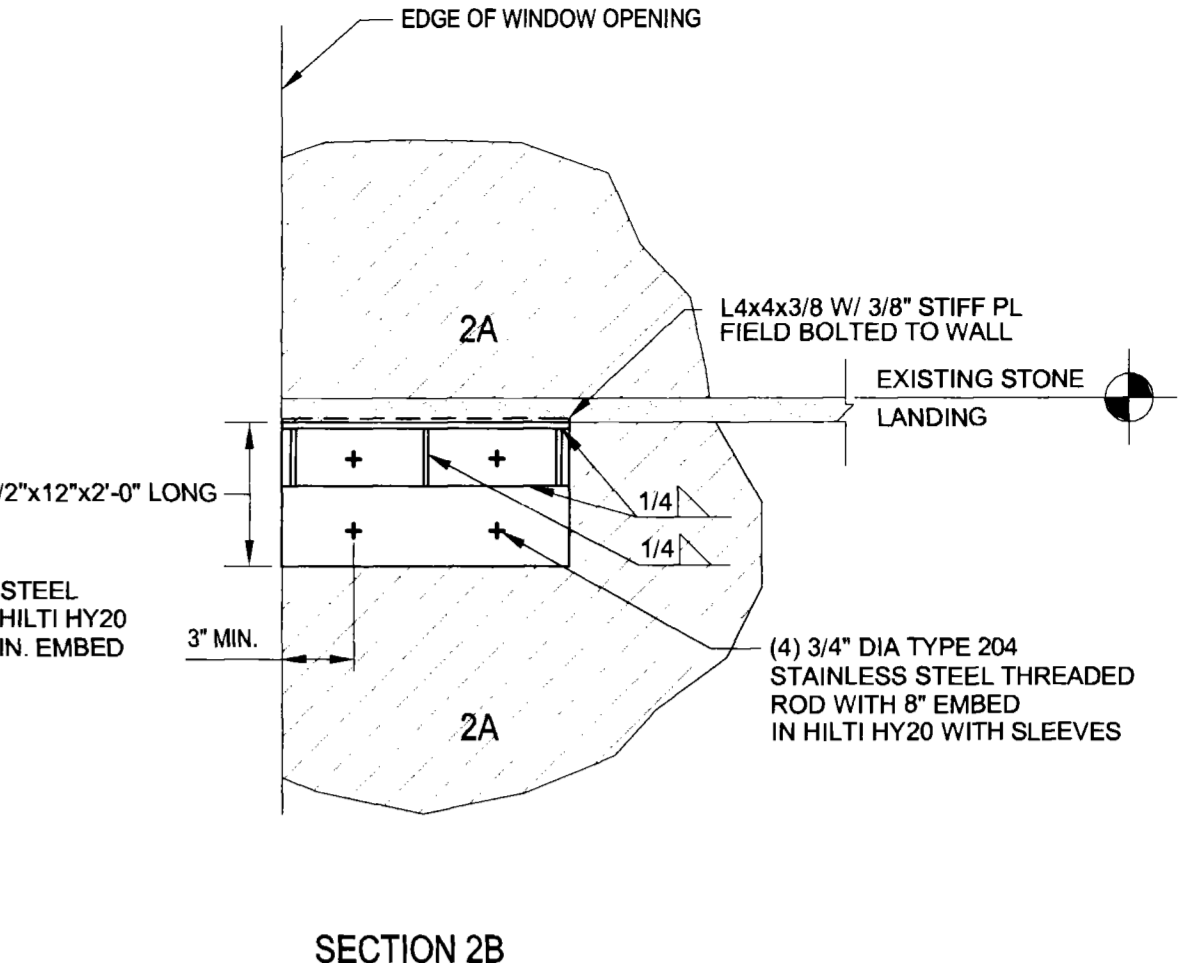


SECTION 2B

DETAIL AT MECHANICAL FLOOR HATCH
 SCALE: 3/4"=1'-0"


SECTION AT EXISTING STONE STAIR LANDING
 SCALE: 3/4"=1'-0"

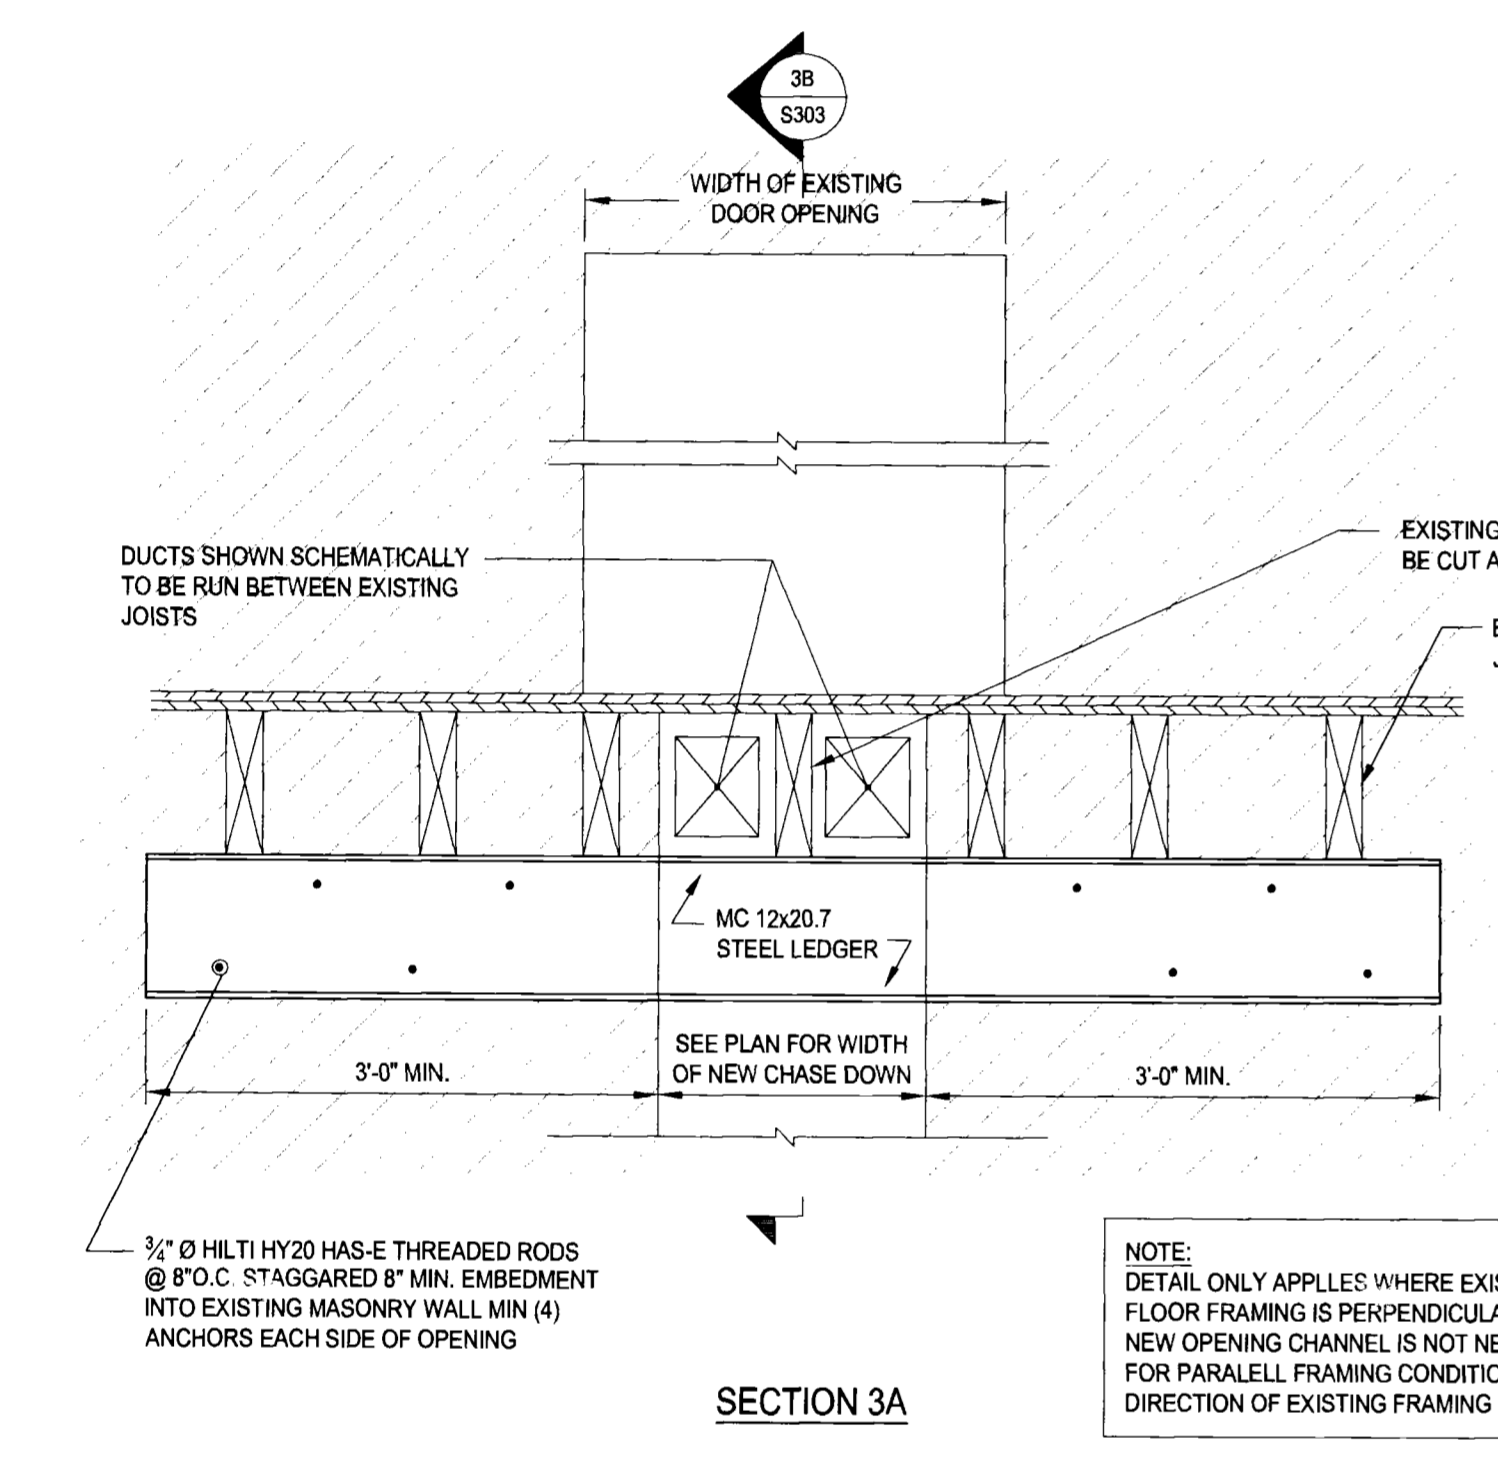


SECTION 3A

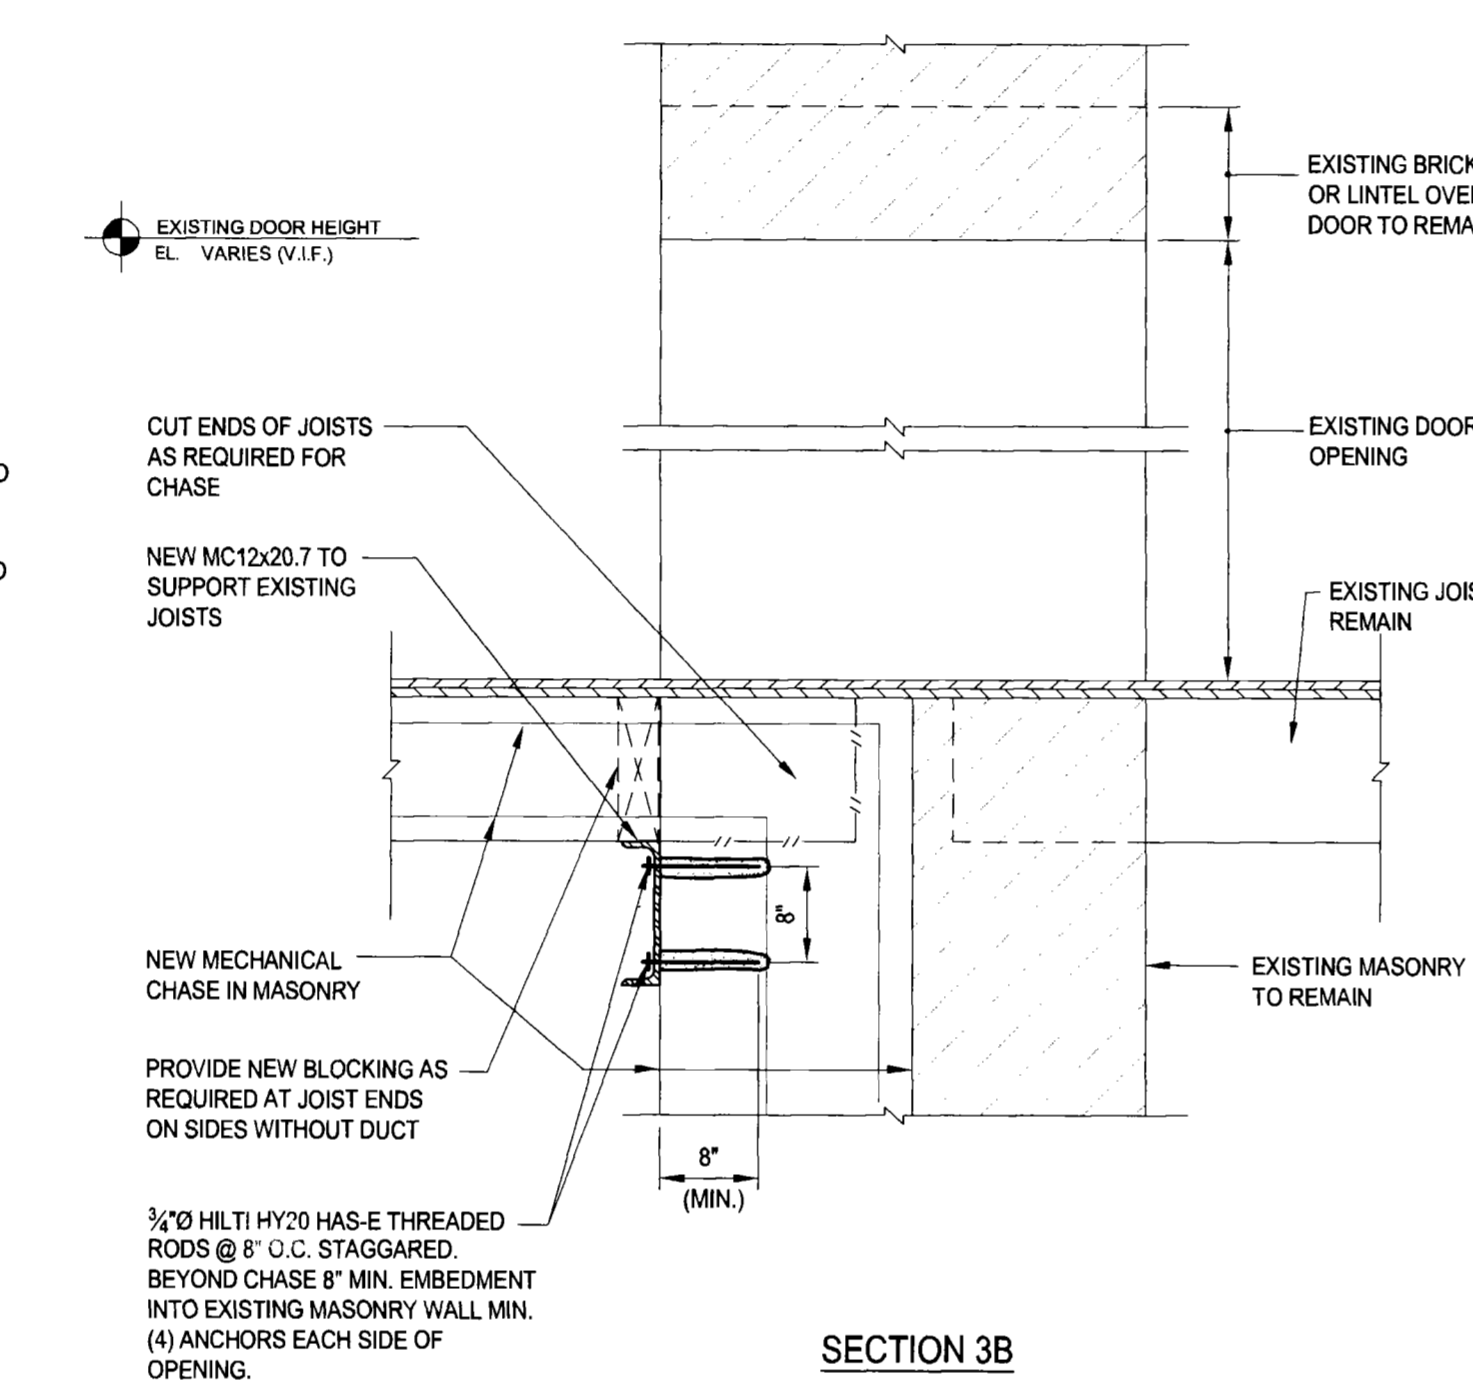

SECTION 3B

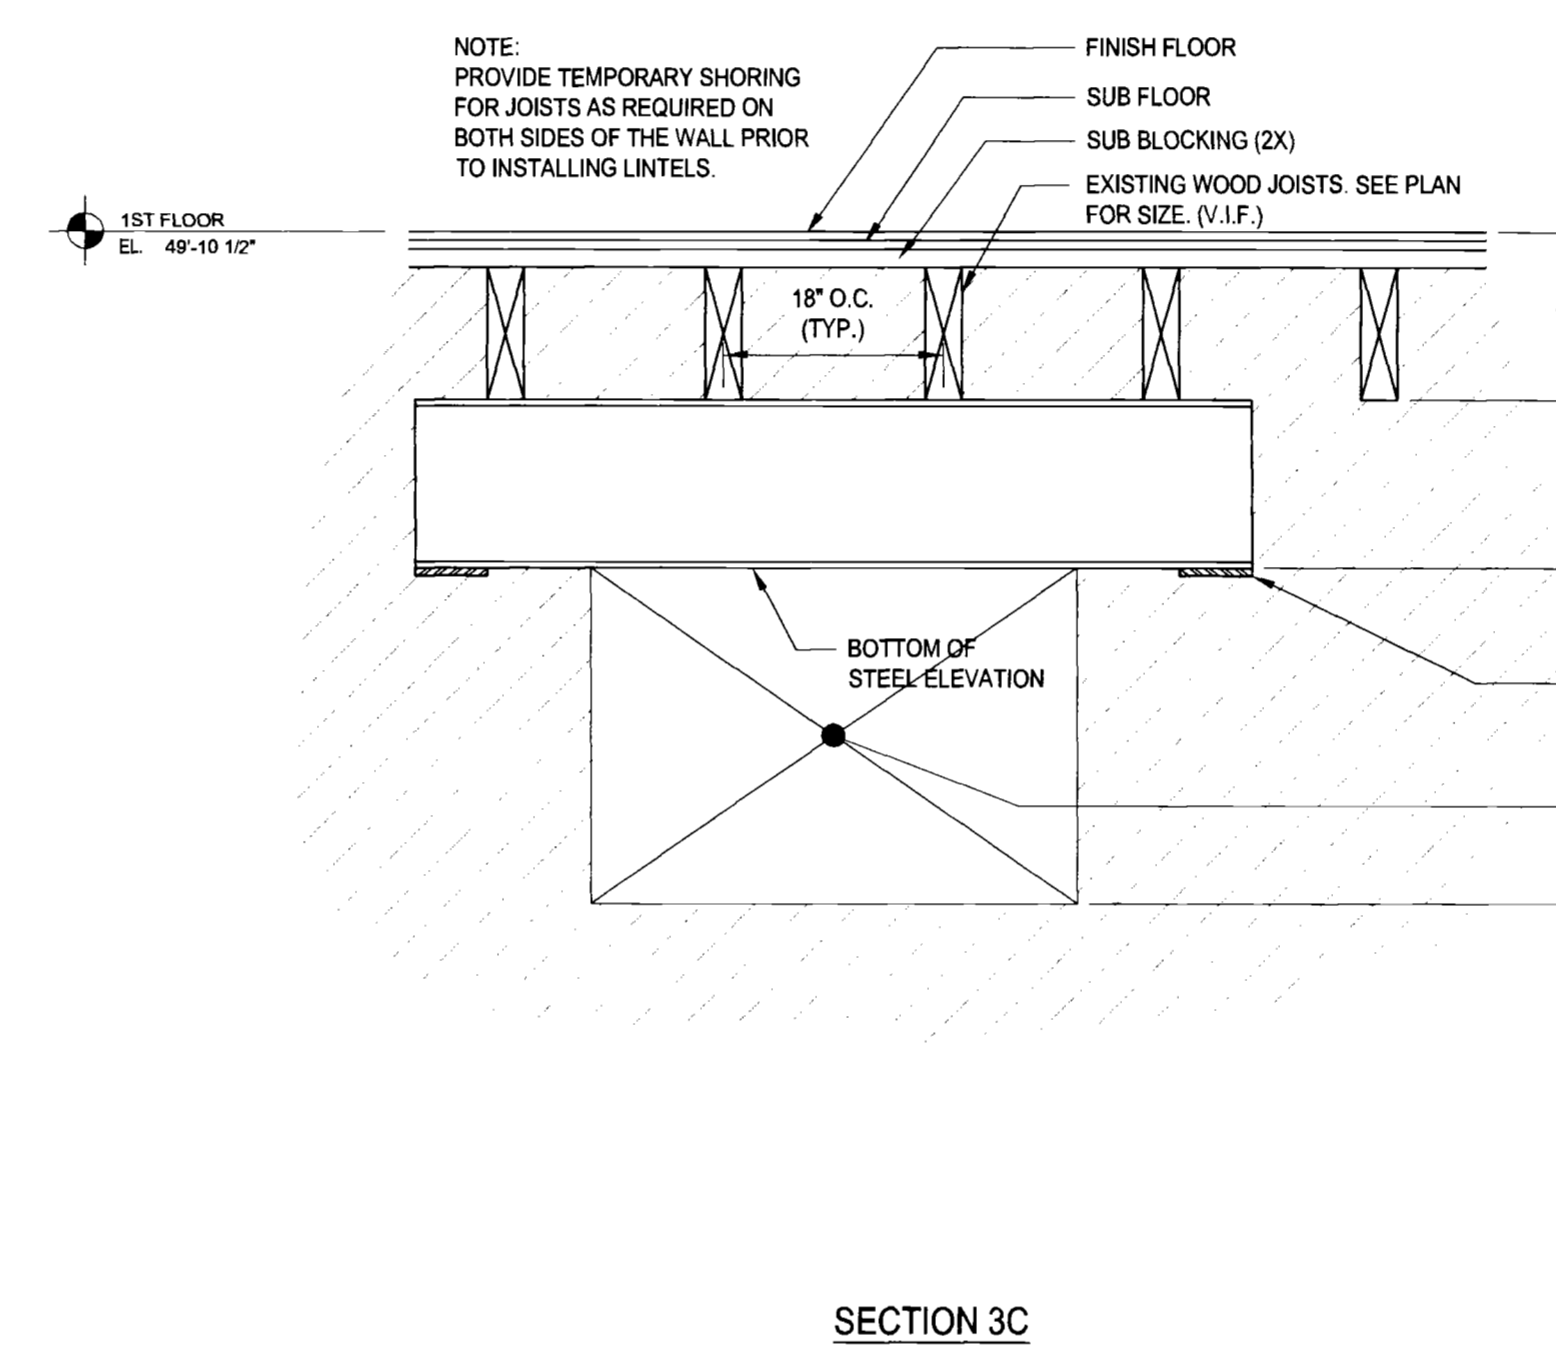


SECTION 3C

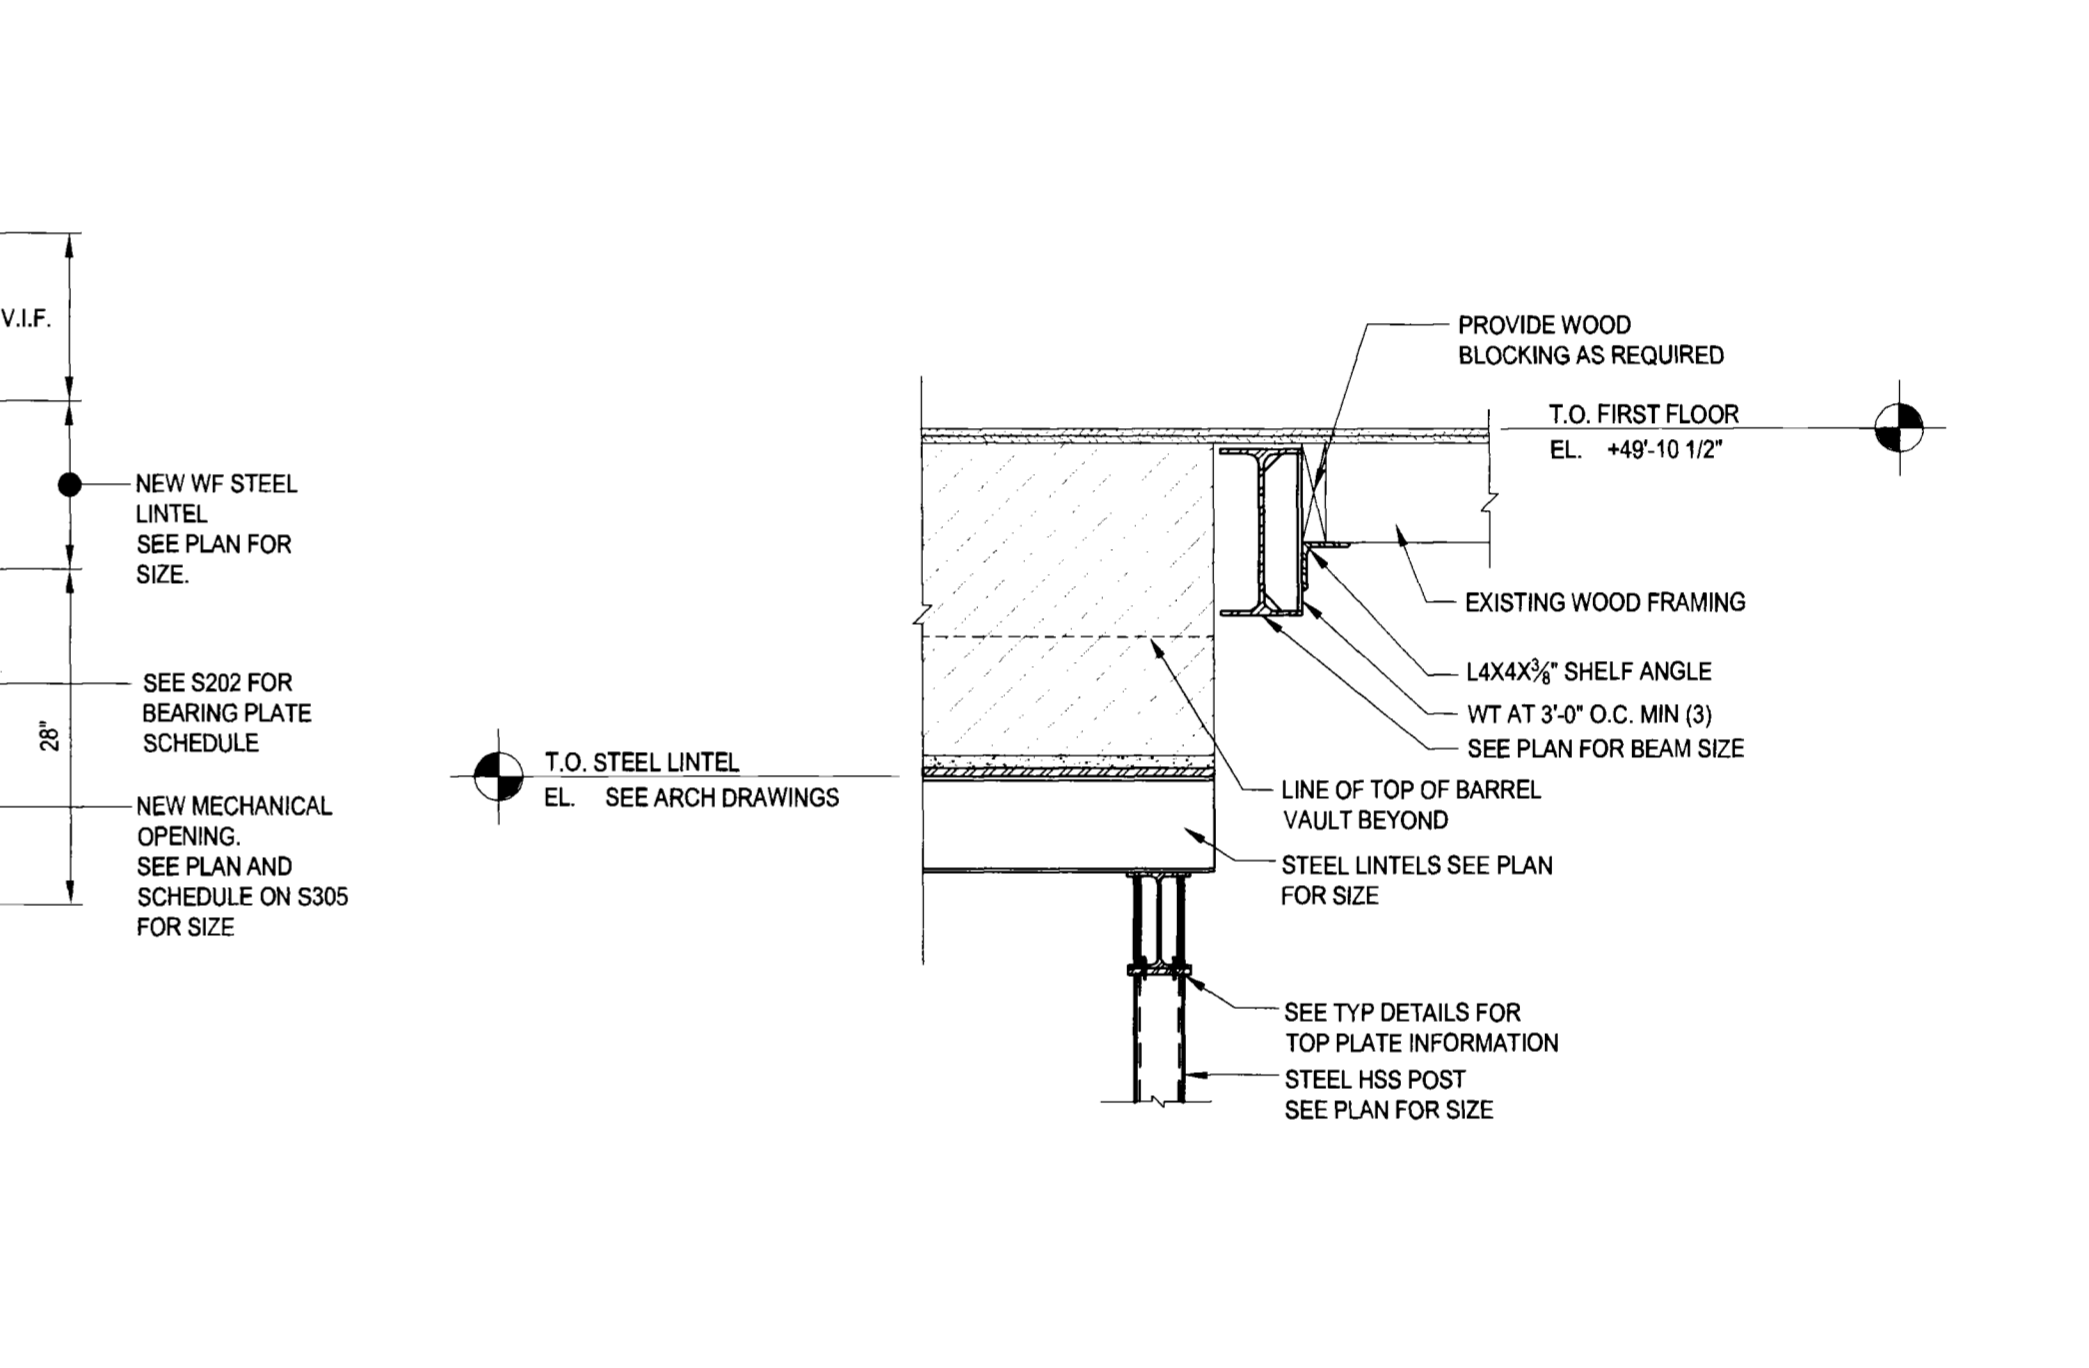


SECTION AT BASEMENT BARREL VAULT
 SCALE: 3/4"=1'-0"


DETAIL AT RE SUPPORT OF PERPENDICULAR JOISTS AT VERTICAL CHASE
 SCALE: 3/4"=1'-0"

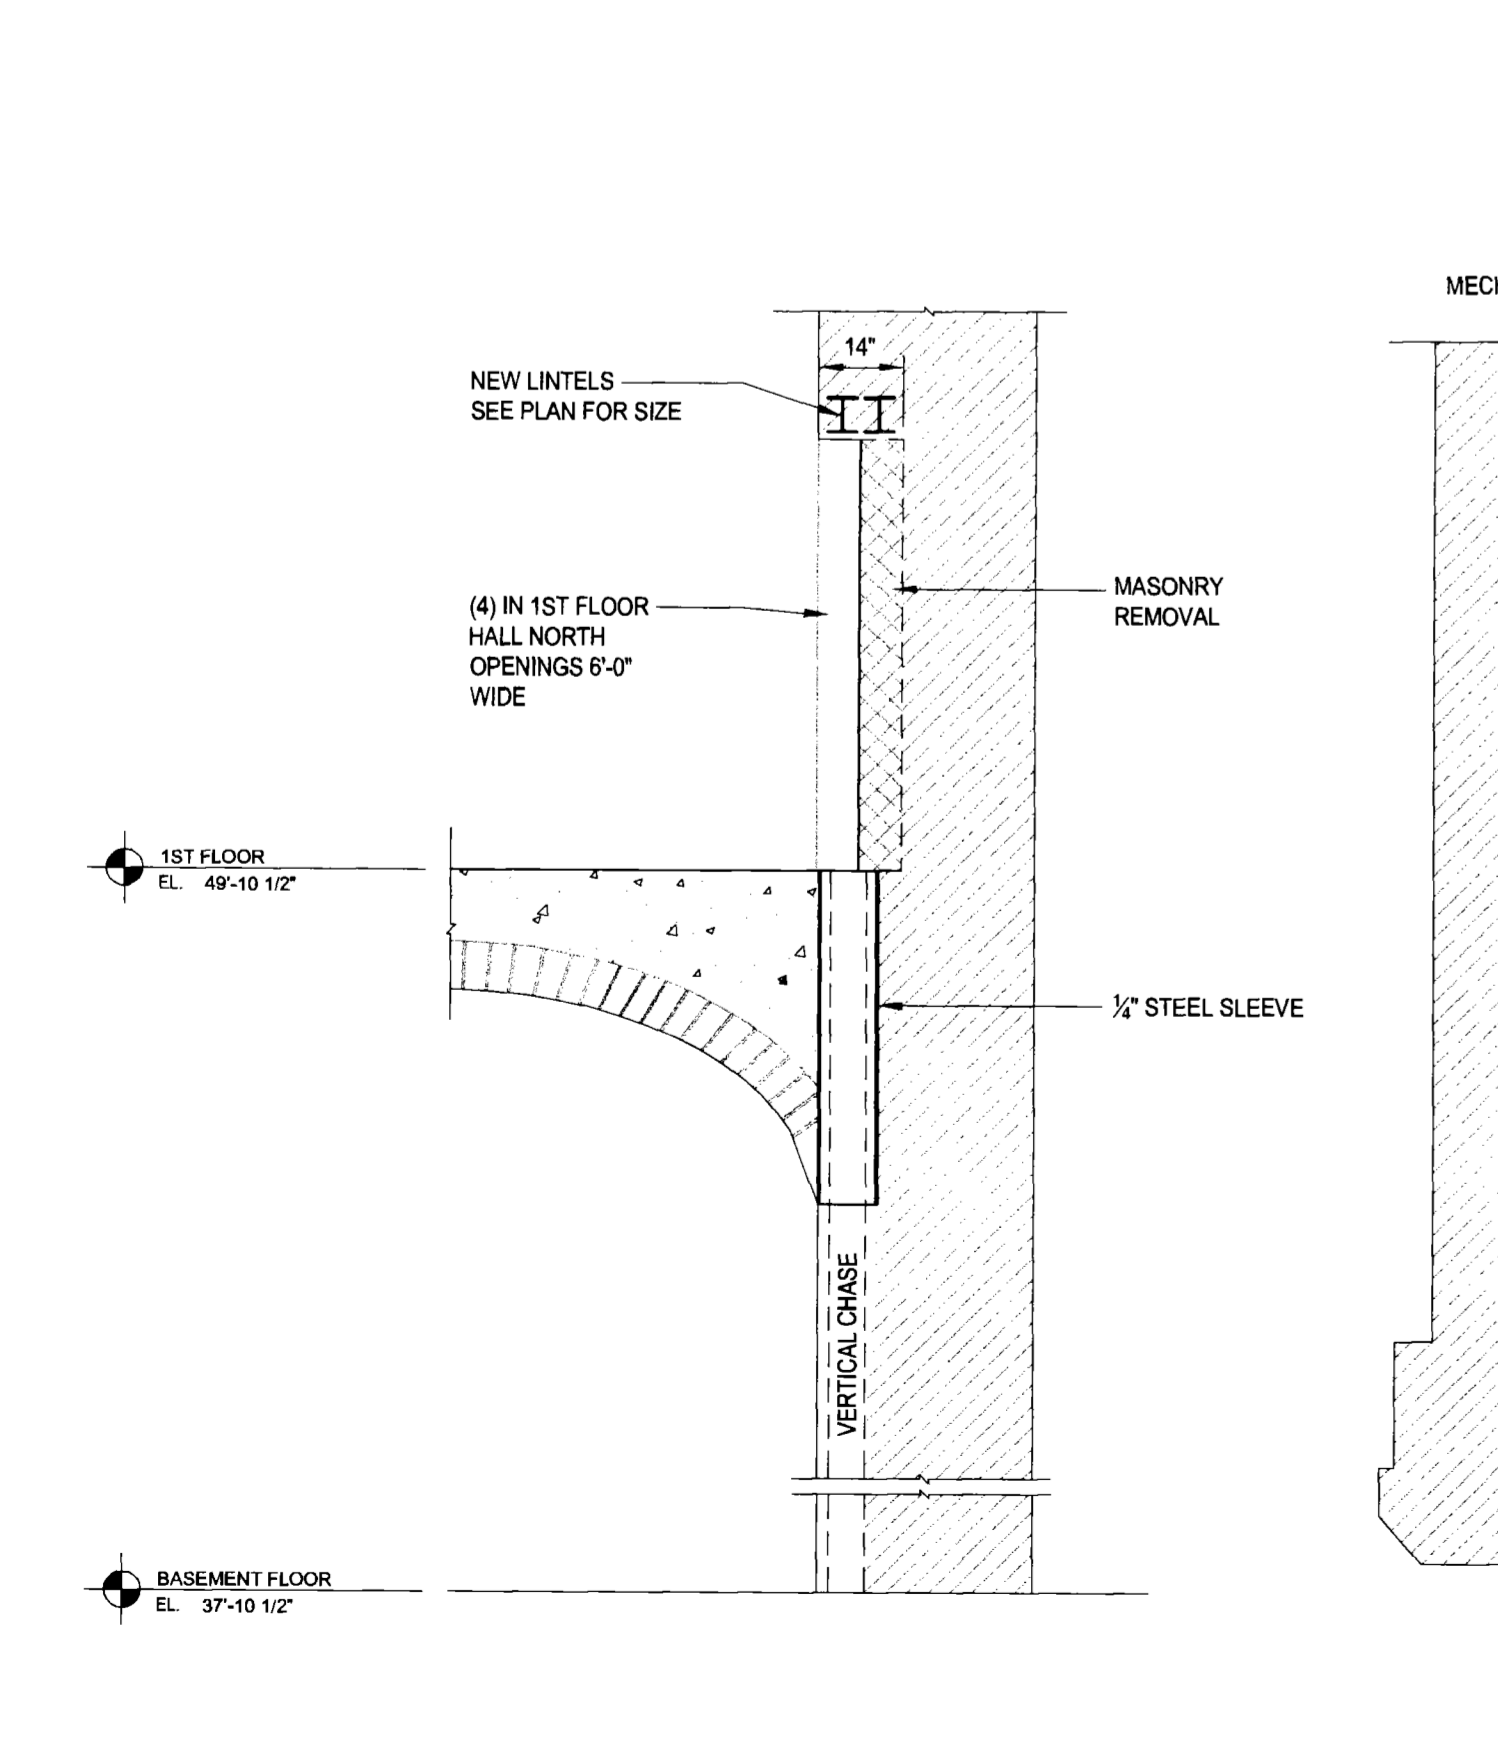

SECTION
 SCALE: 3/8"=1'-0"

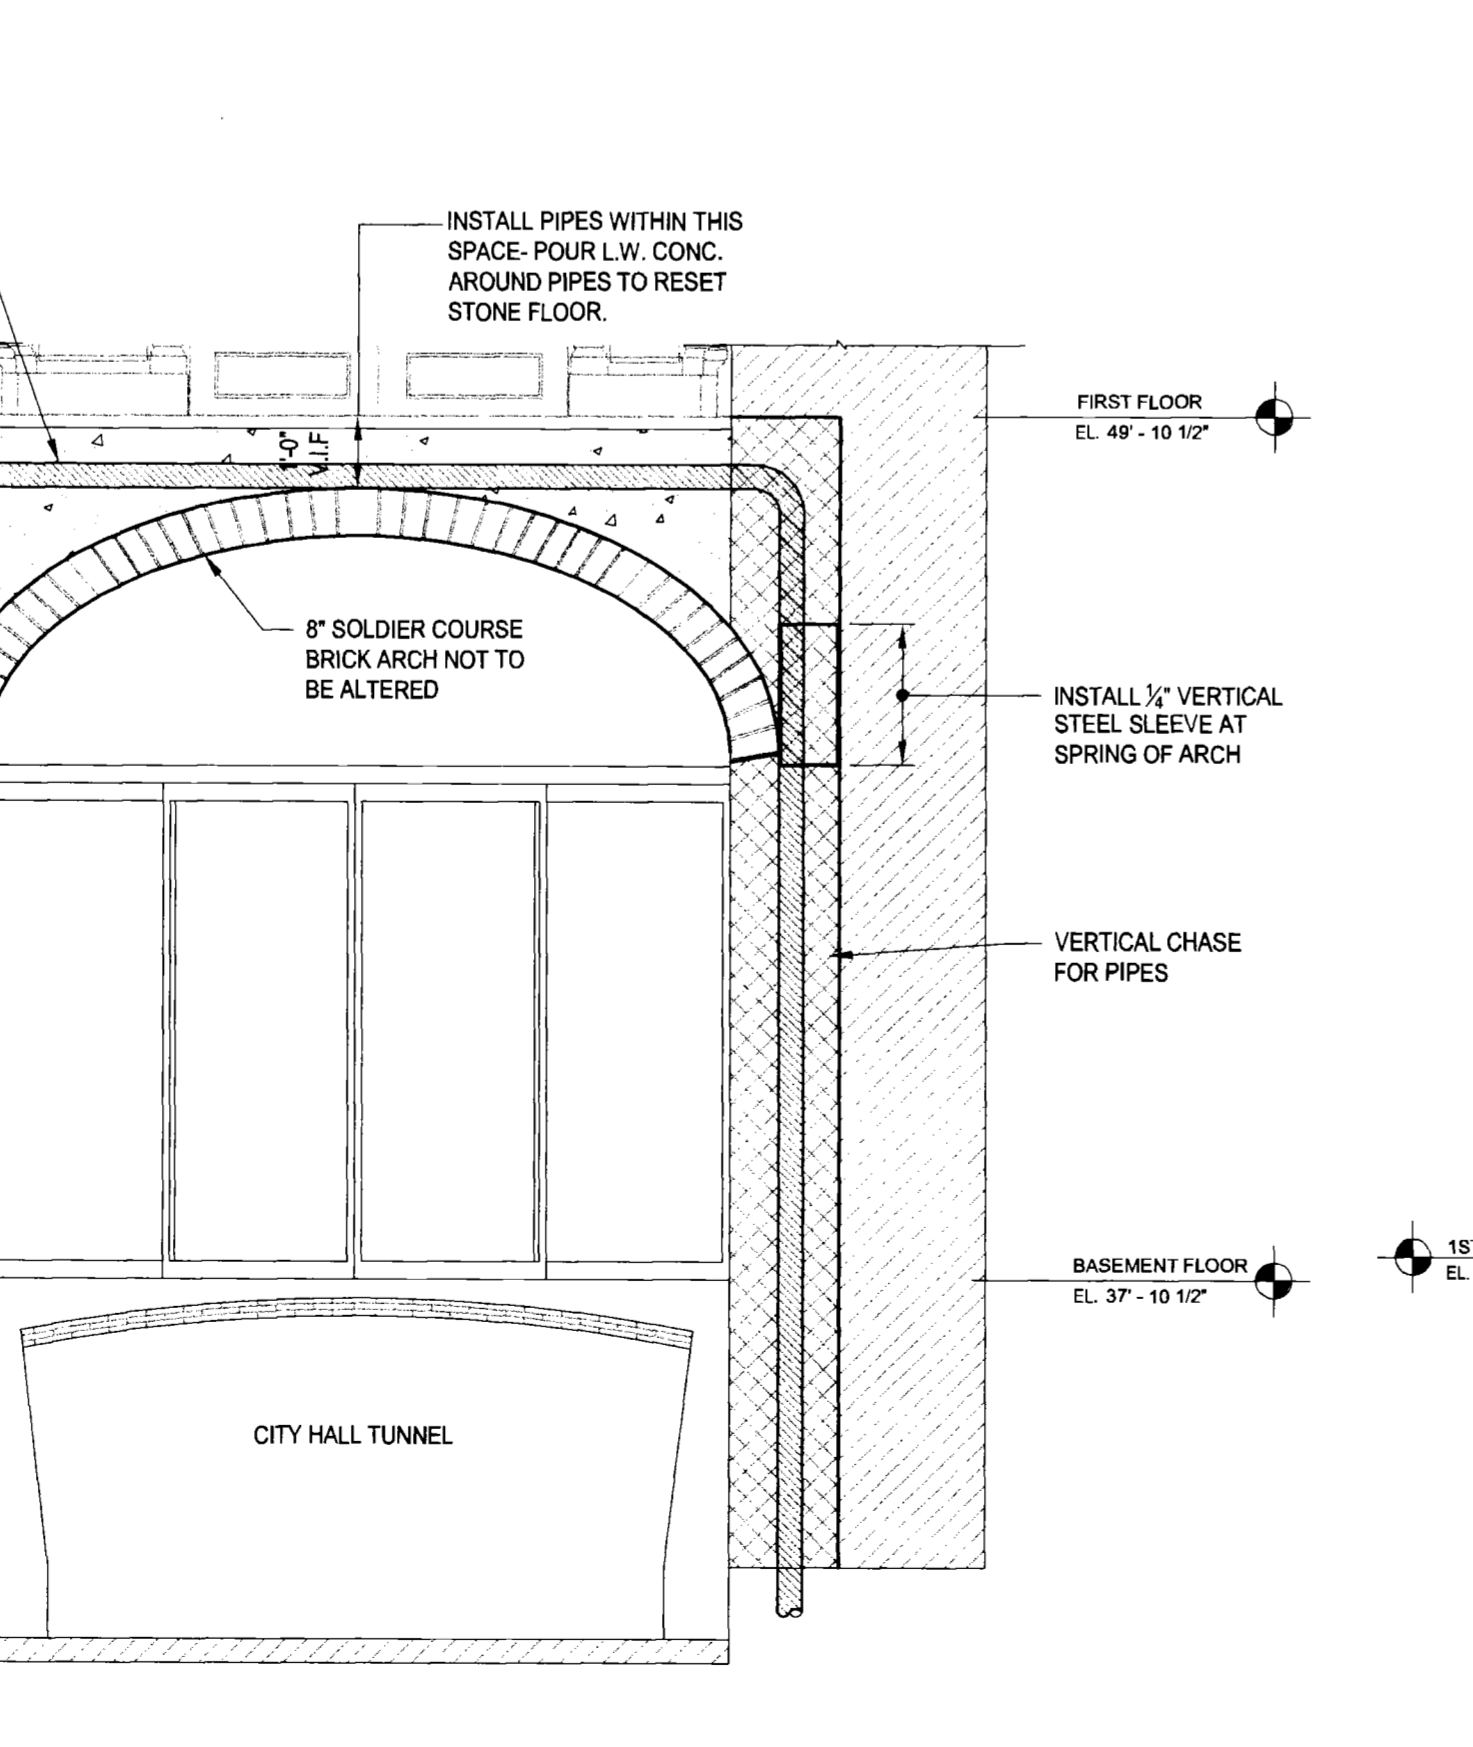


SECTION LOOKING EAST
 SCALE: 3/8"=1'-0"

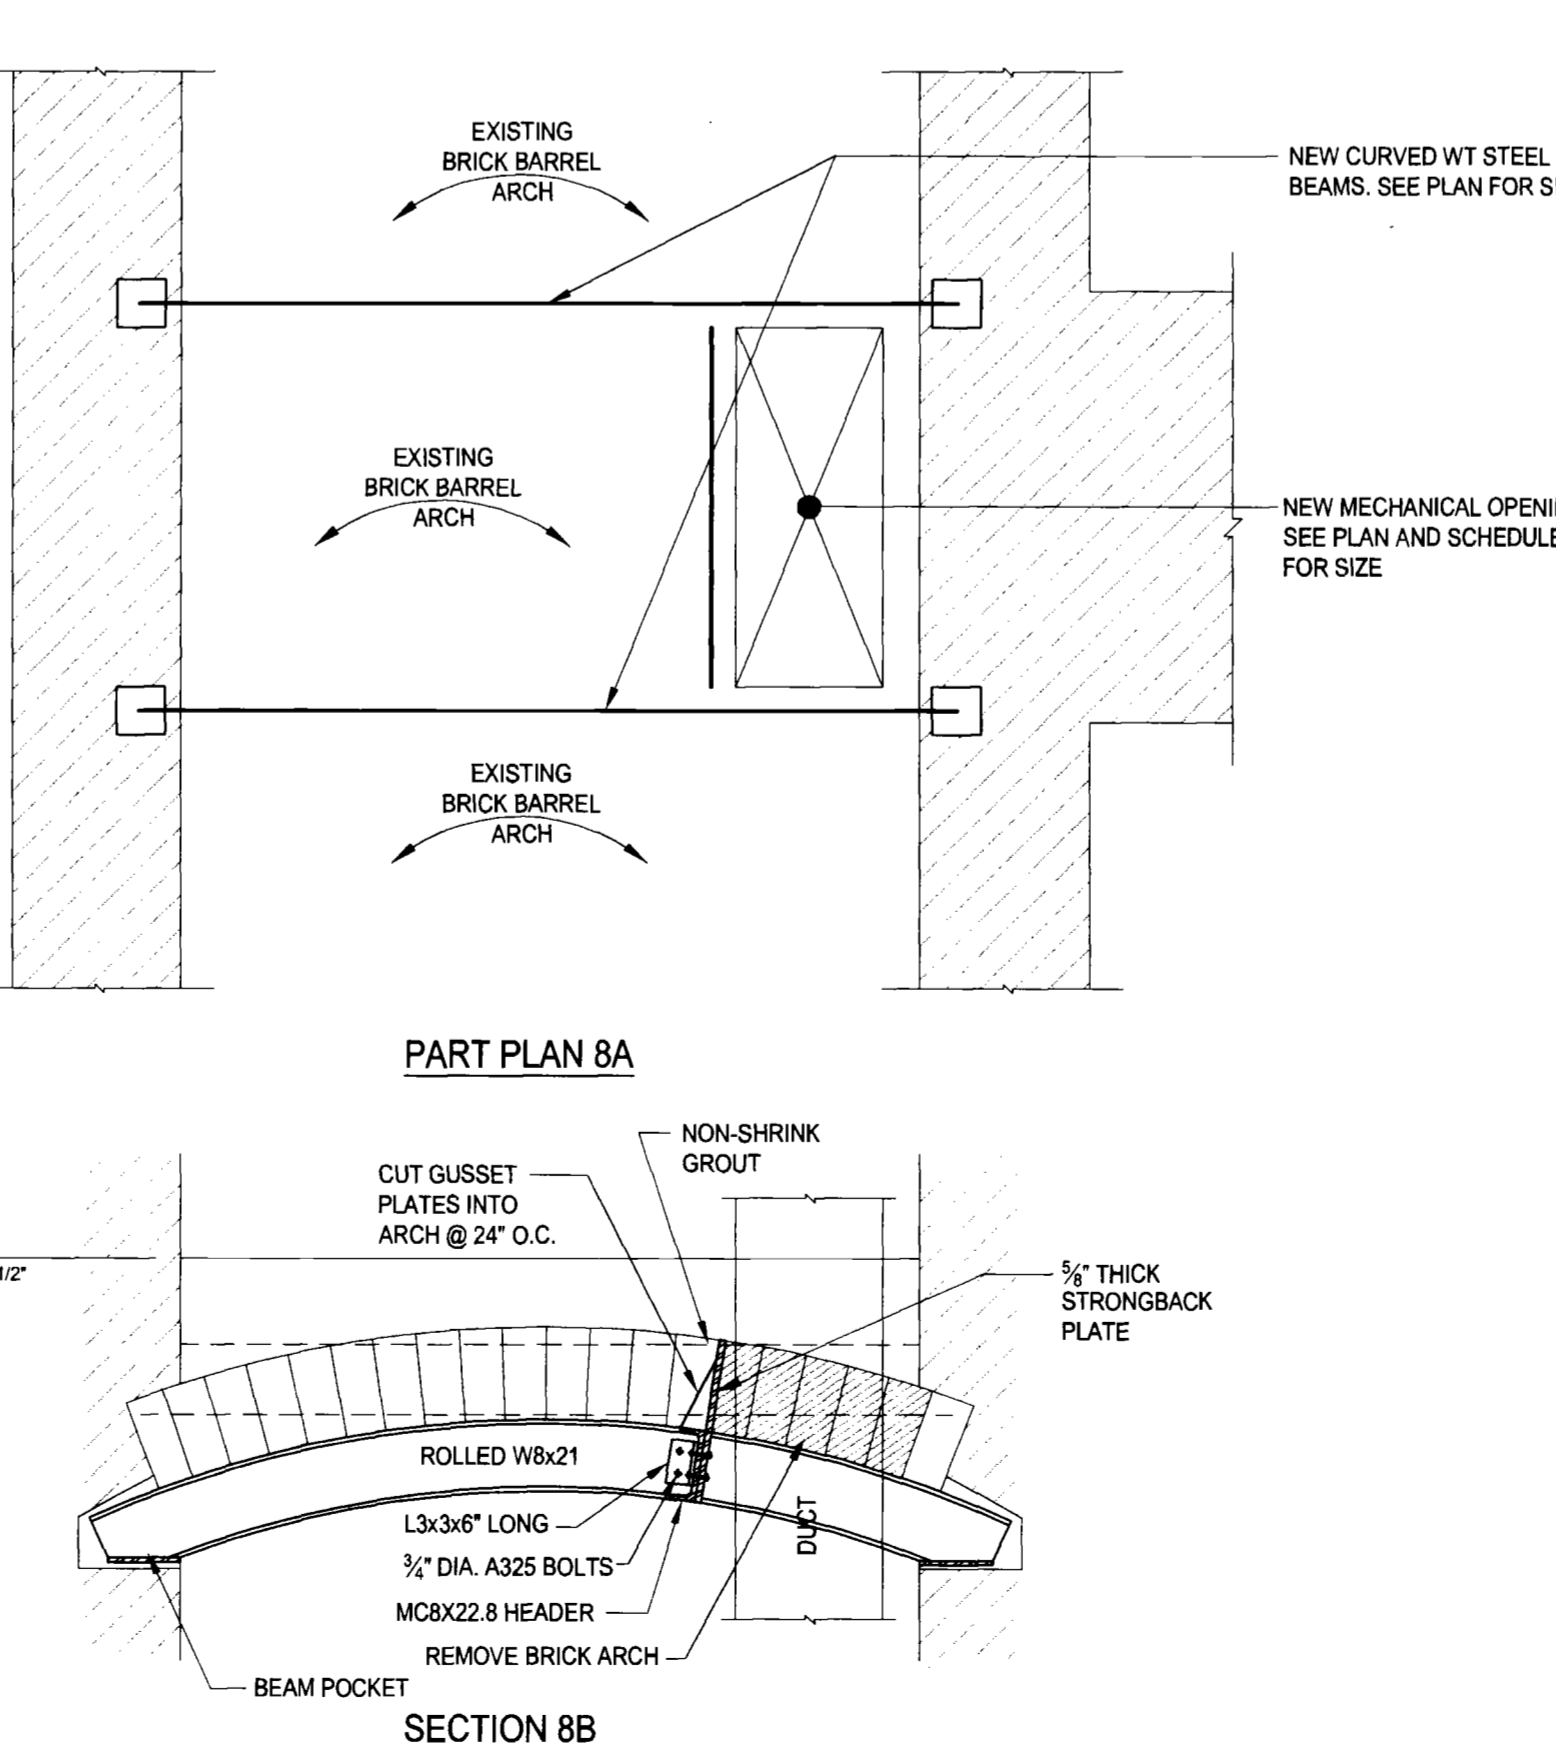

PART PLAN 8A


DETAIL OF NEW FLOOR OPENING AT EXISTING BARREL ARCH TO REMAIN
 SCALE: 3/4"=1'-0"

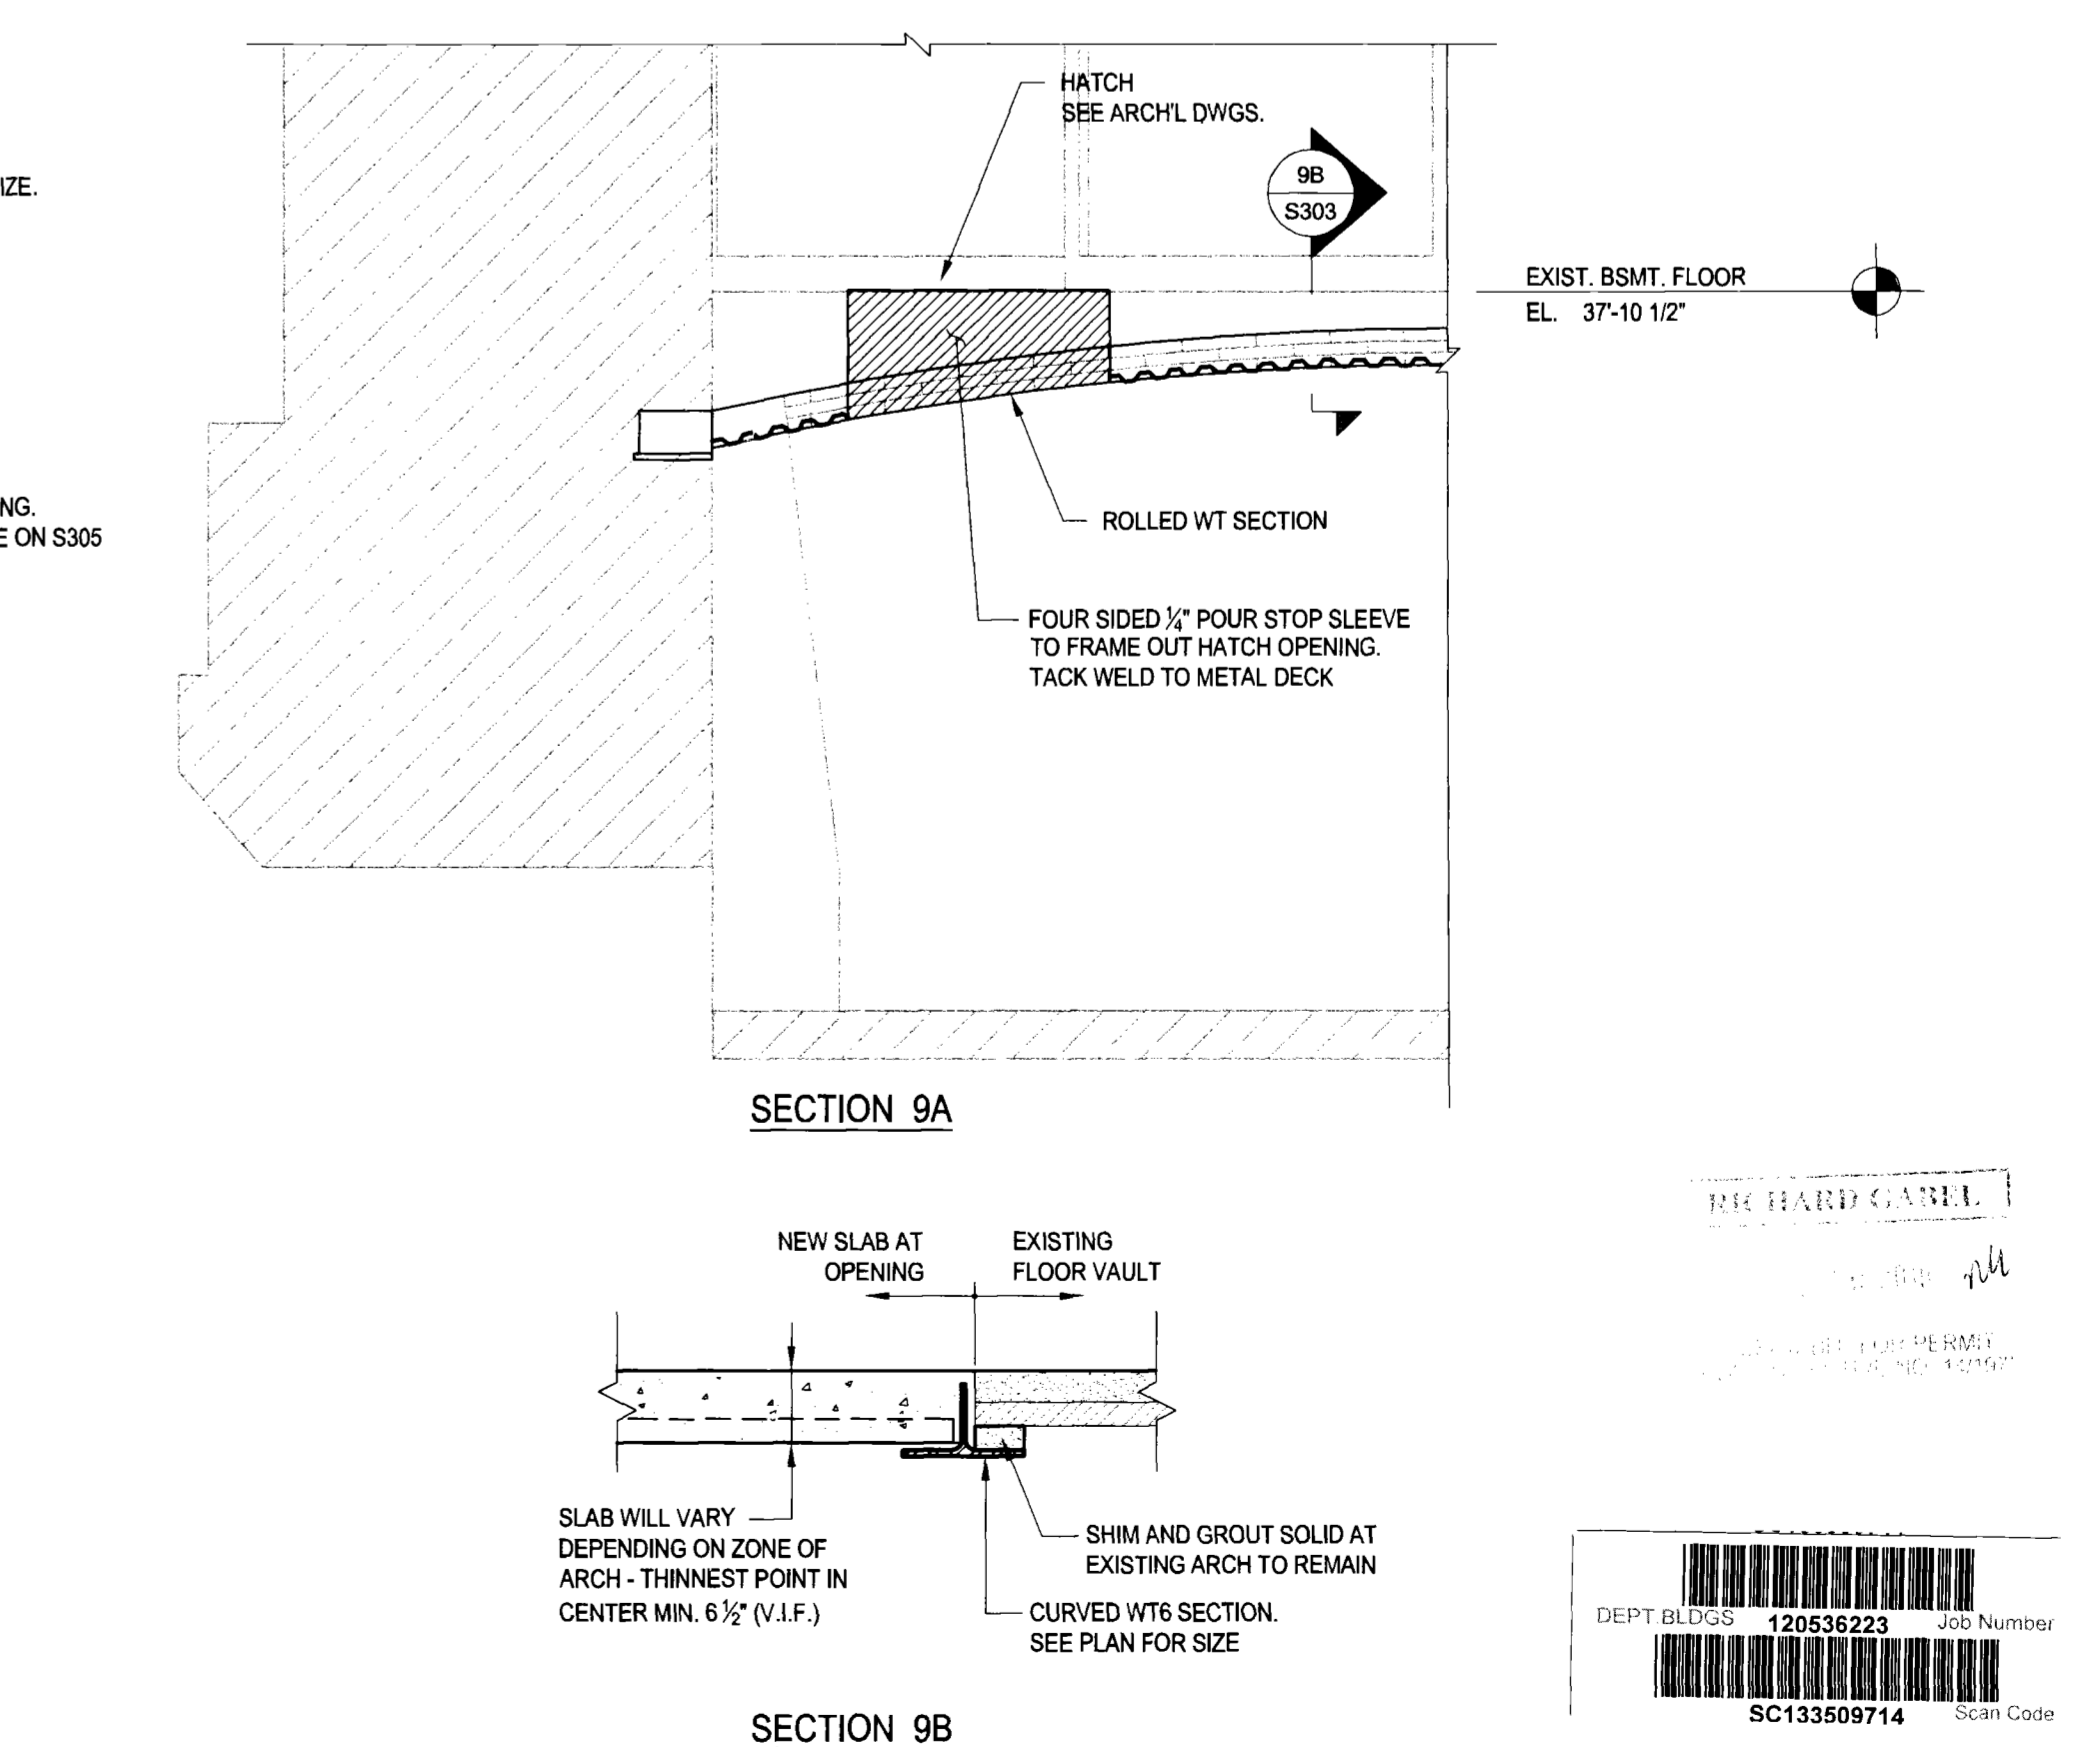

SECTION 9A

DETAIL OF NEW FLOOR OPENING AT EXISTING BARREL ARCH TO BE REMOVED
 SCALE: 3/4"=1'-0"

NOTE:
 ALTERNATIVE: REMOVE FULL SPAN OF BRICK ARCH AND REPLACE WITH FRAMED W8x21 STEEL BEAM & 4.5" CONCRETE ON 2" METAL DECK REPAIR.

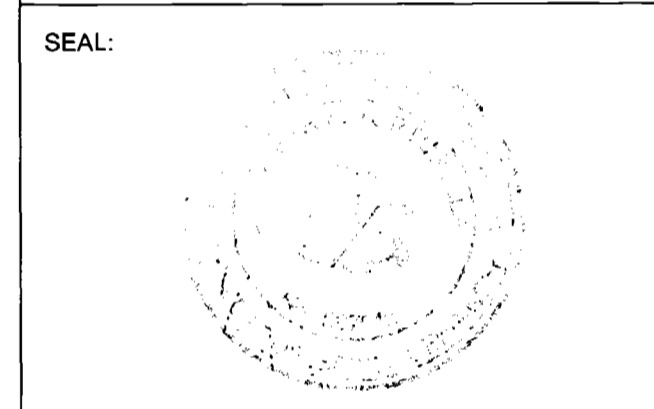

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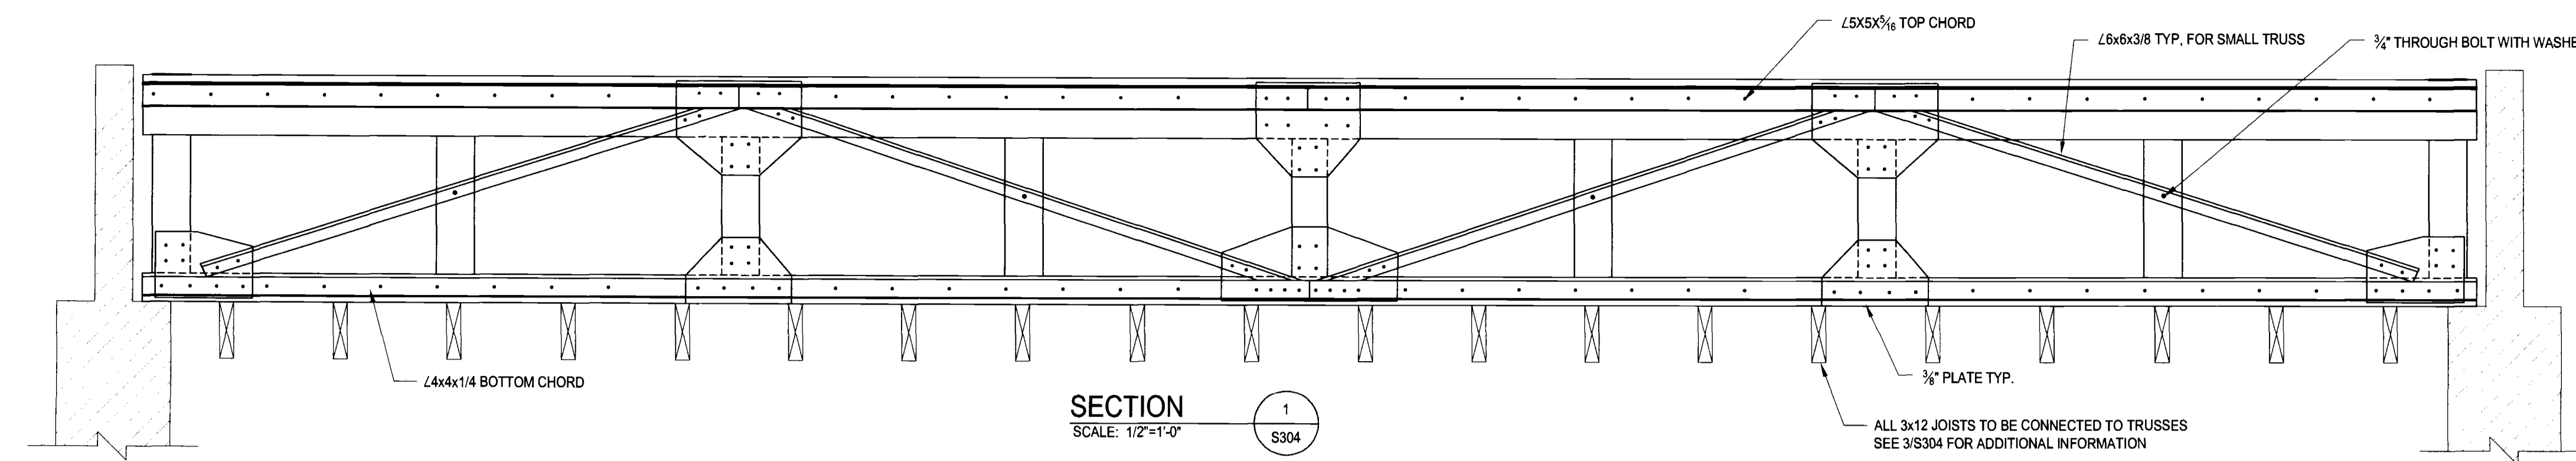
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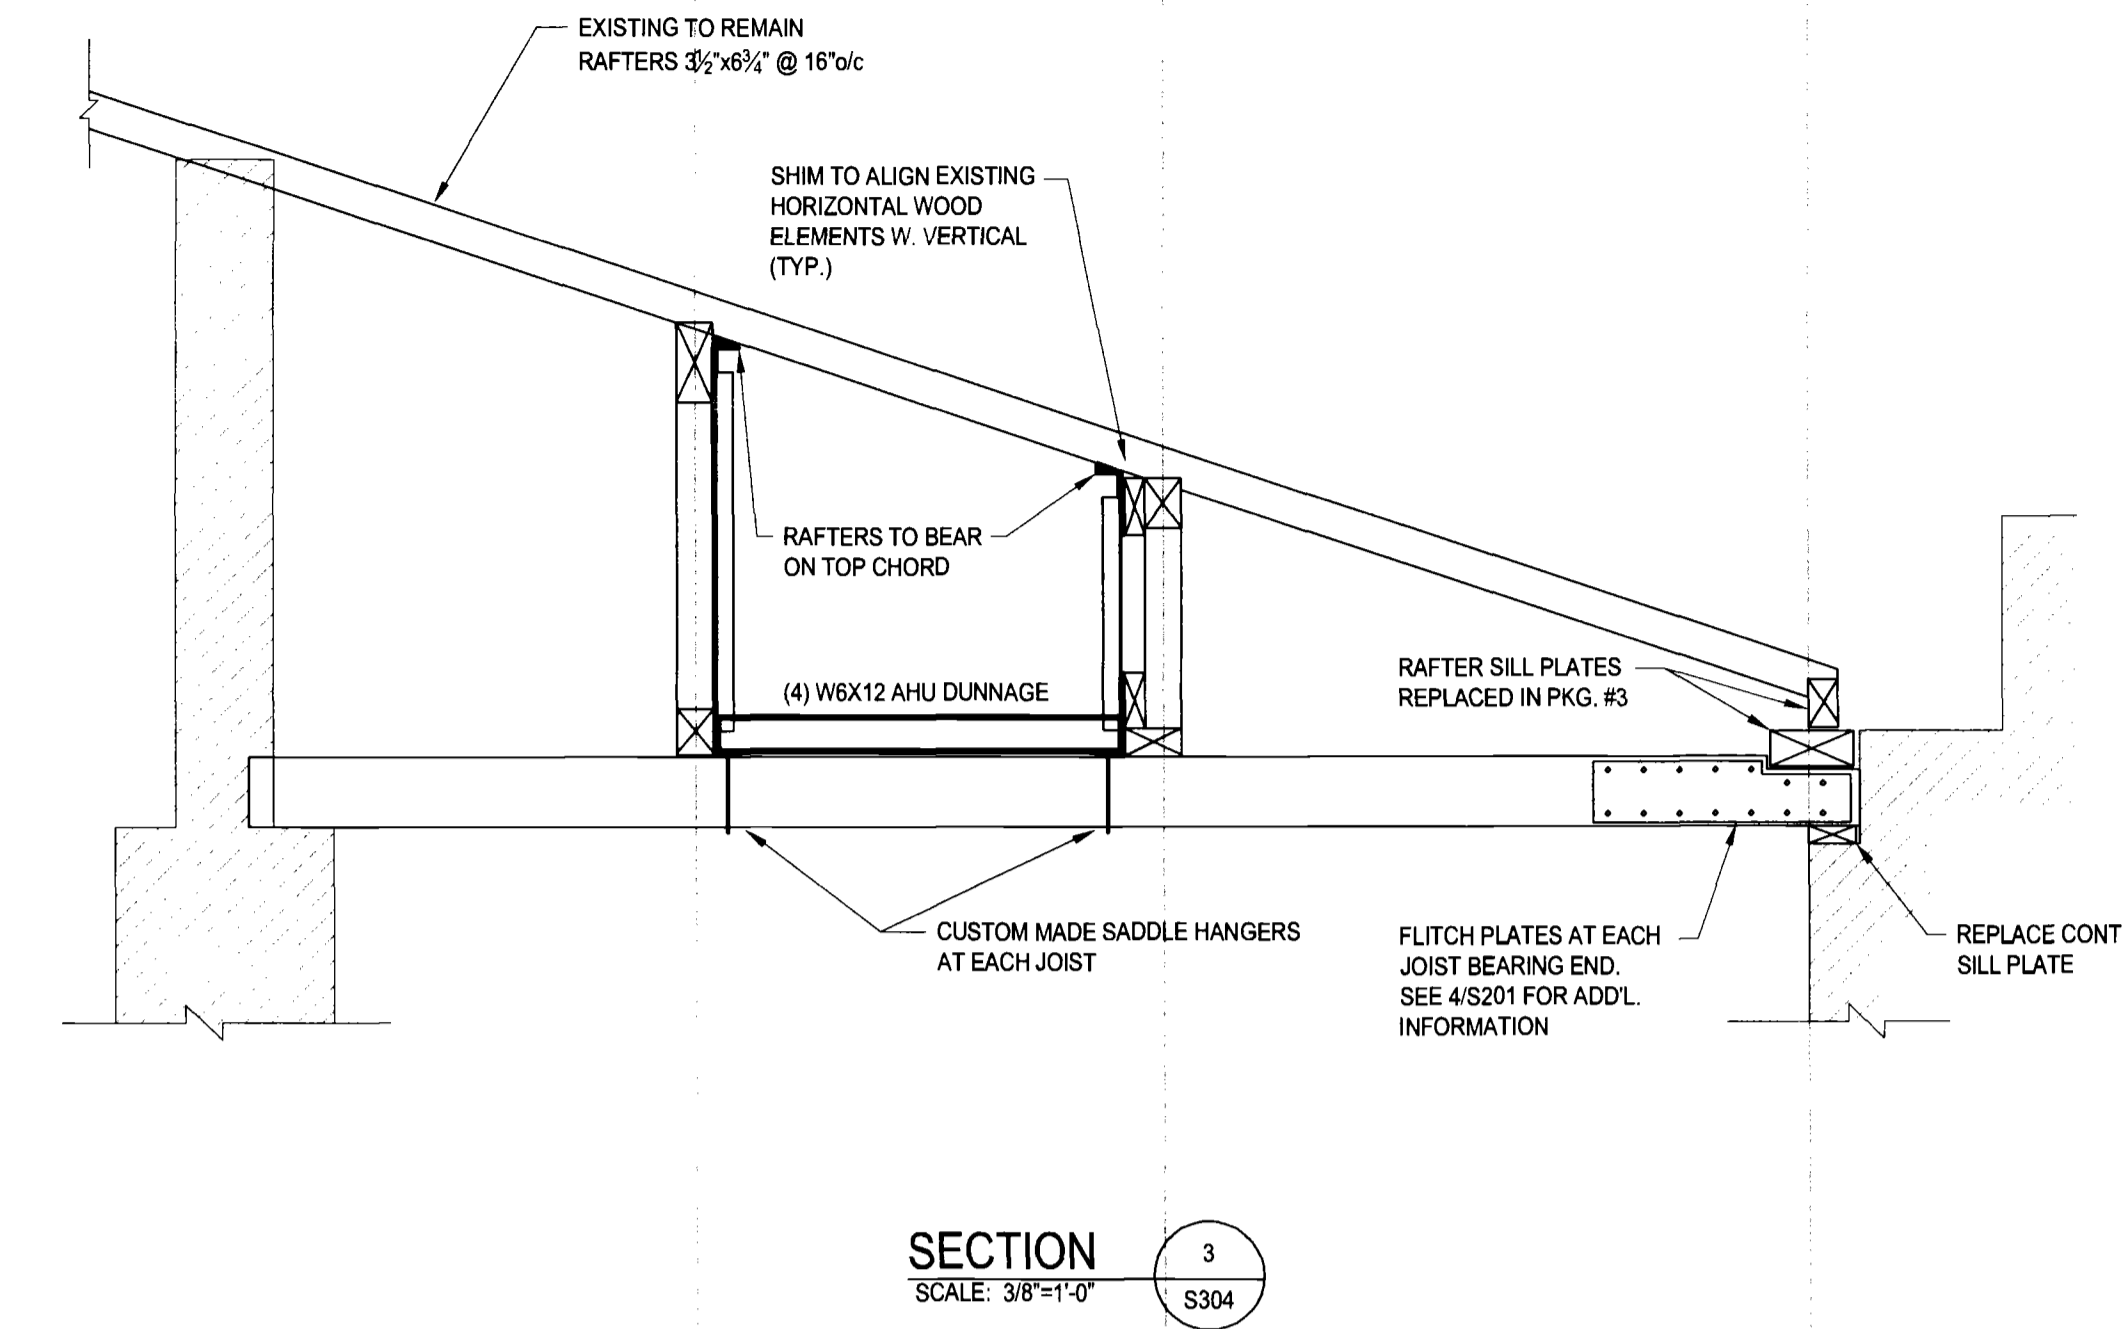
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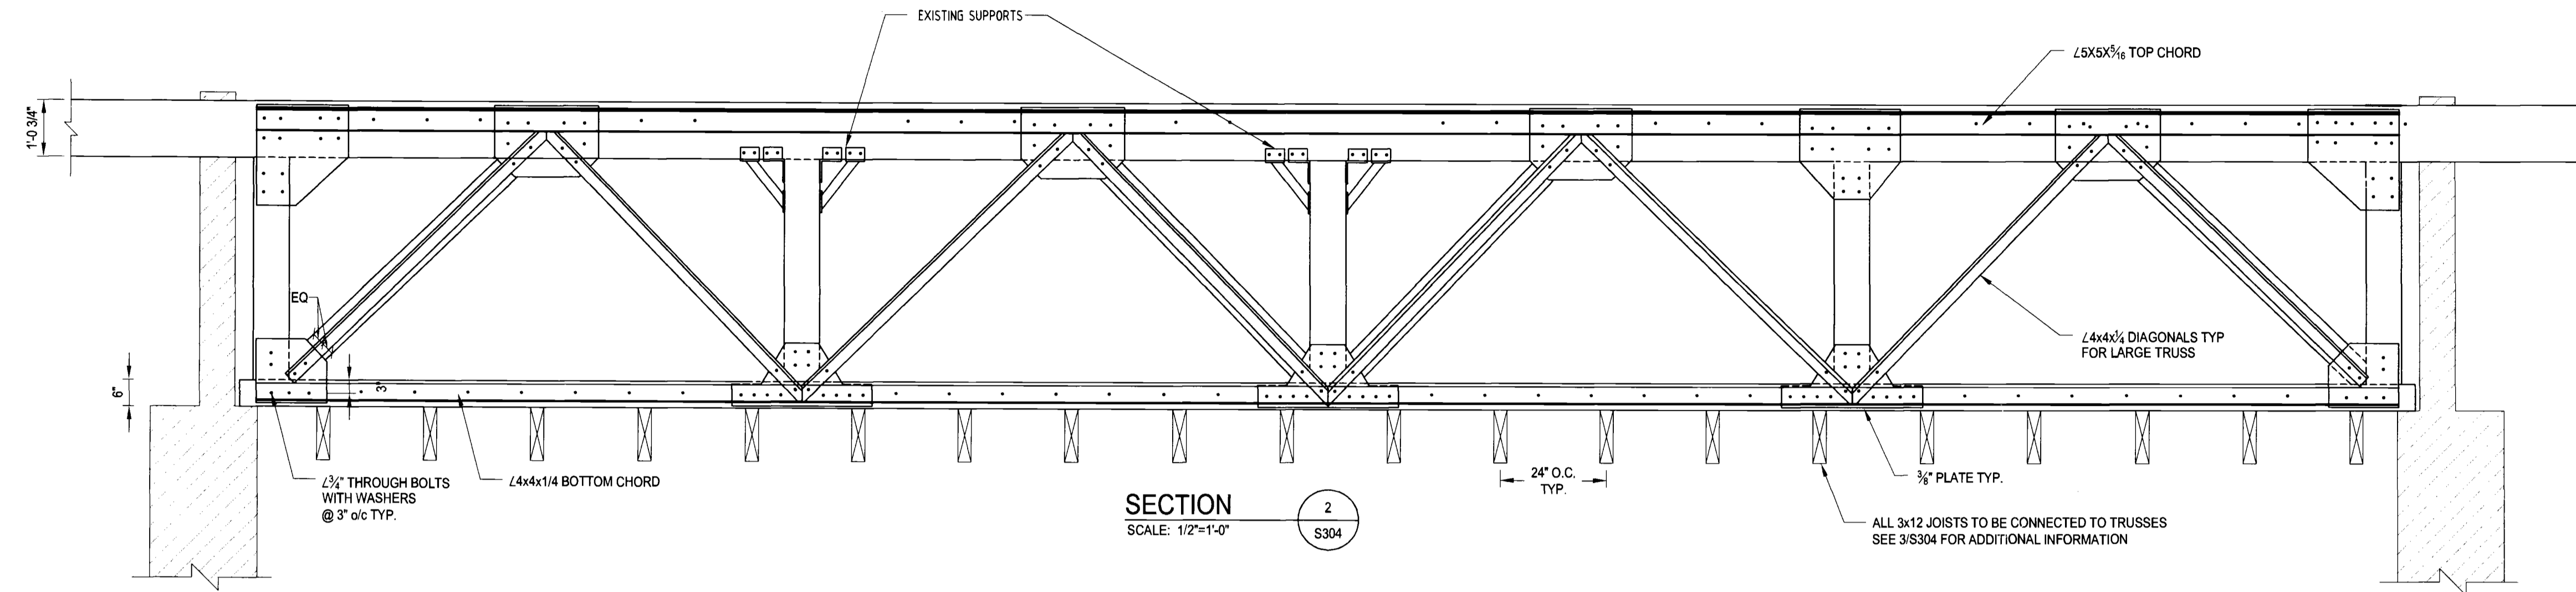
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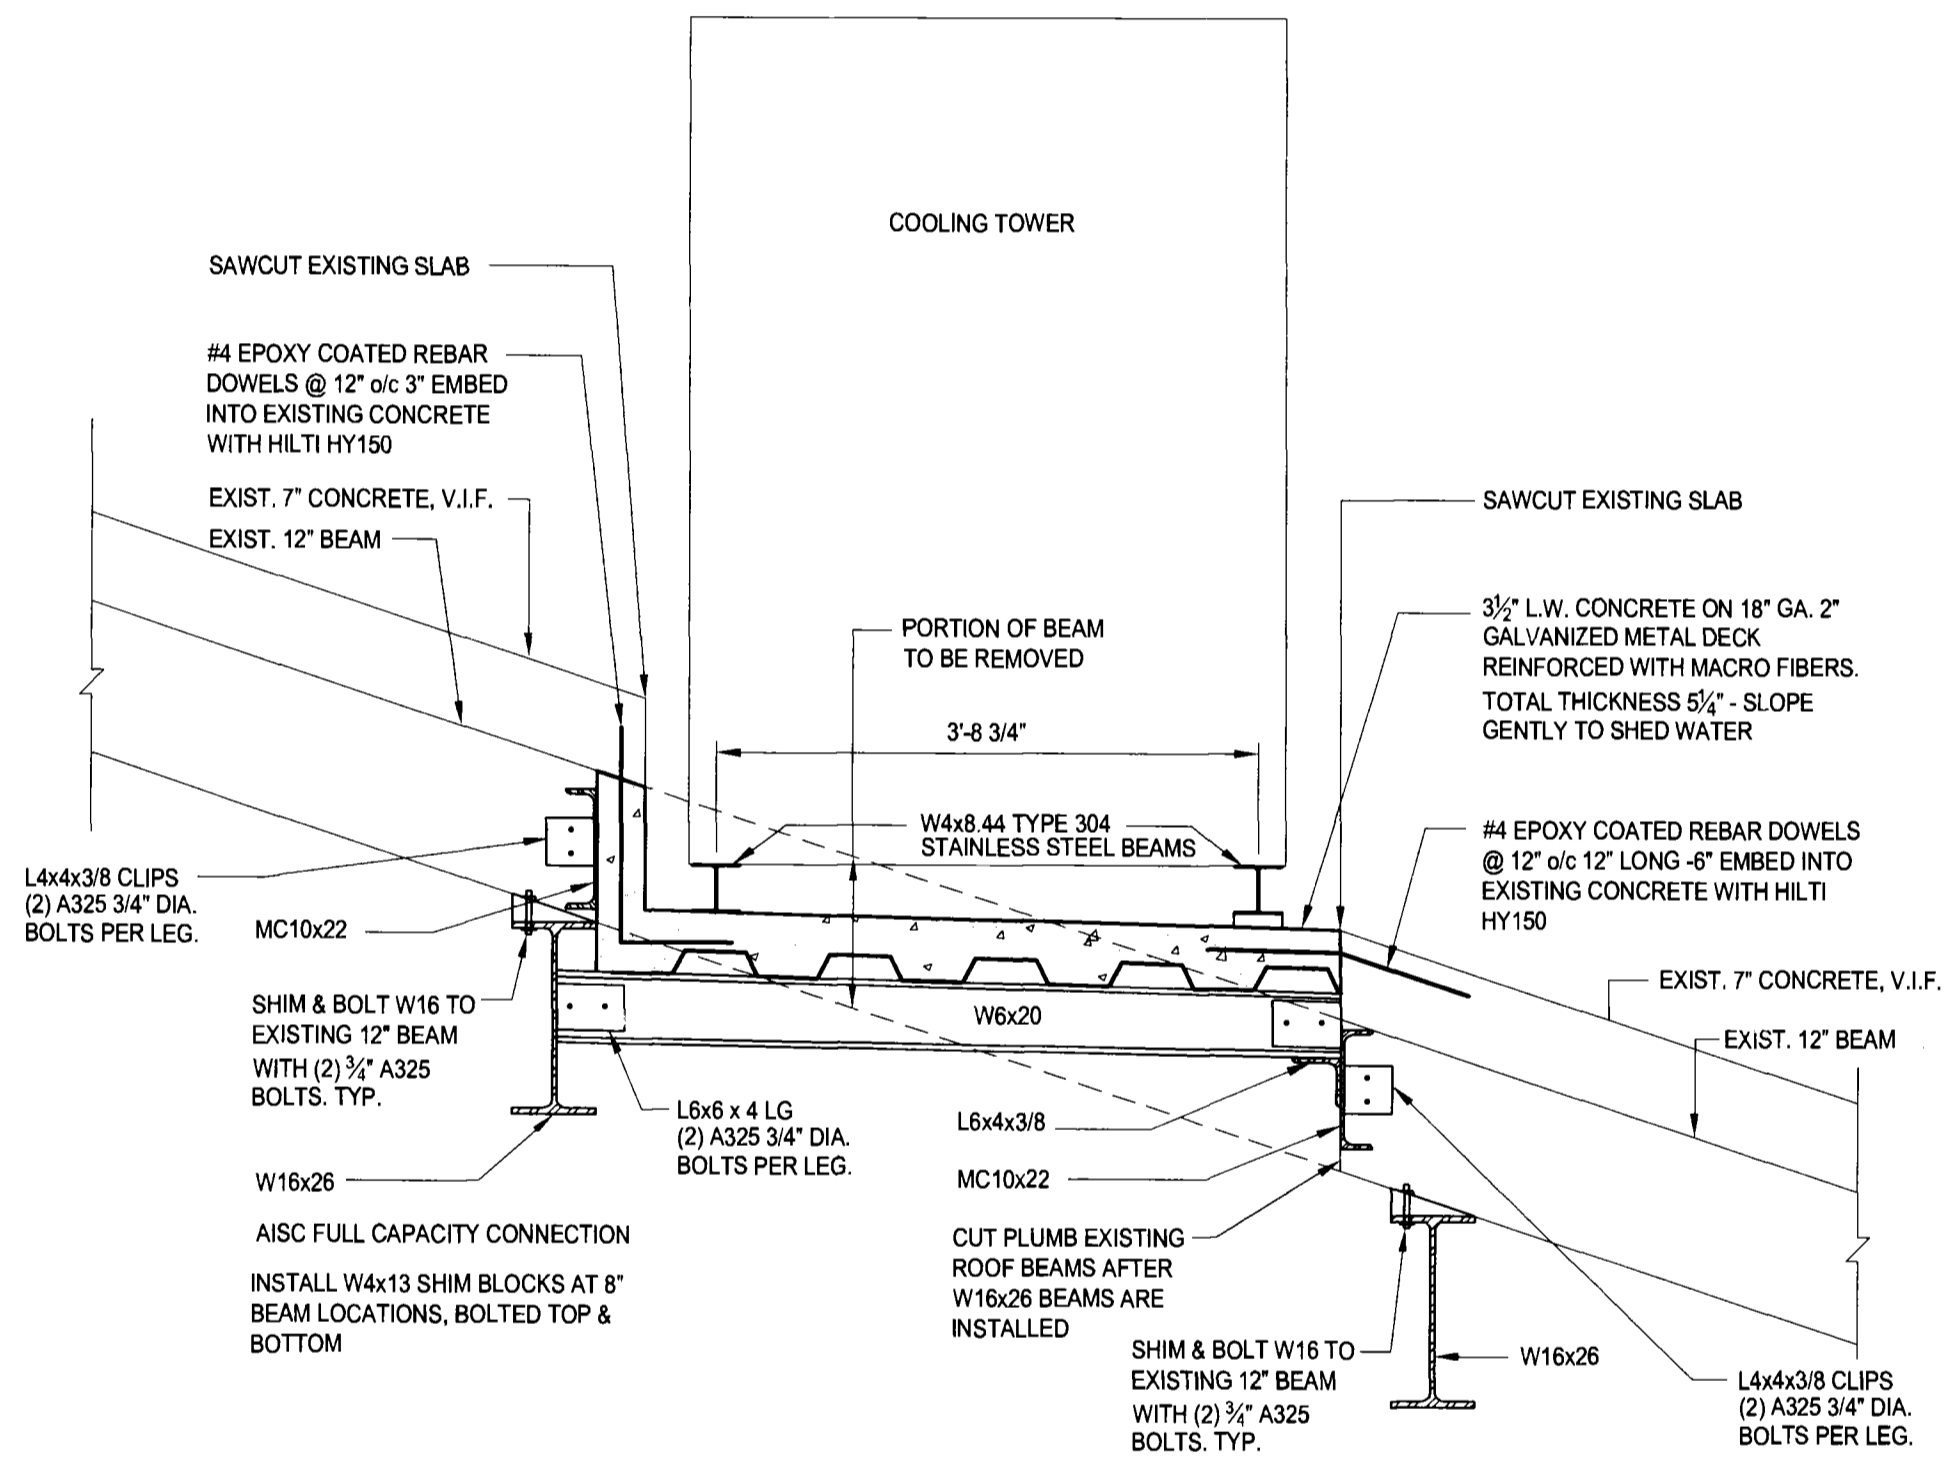
SECTION 1
SCALE: 1/2"=1'-0"
S304




SECTION 3
SCALE: 3/8"=1'-0"
S304




SECTION 2
SCALE: 1/2"=1'-0"
S304



ROTUNDA SECTION @ COOLING TOWER
SCALE: 3/4"=1'-0"
S304

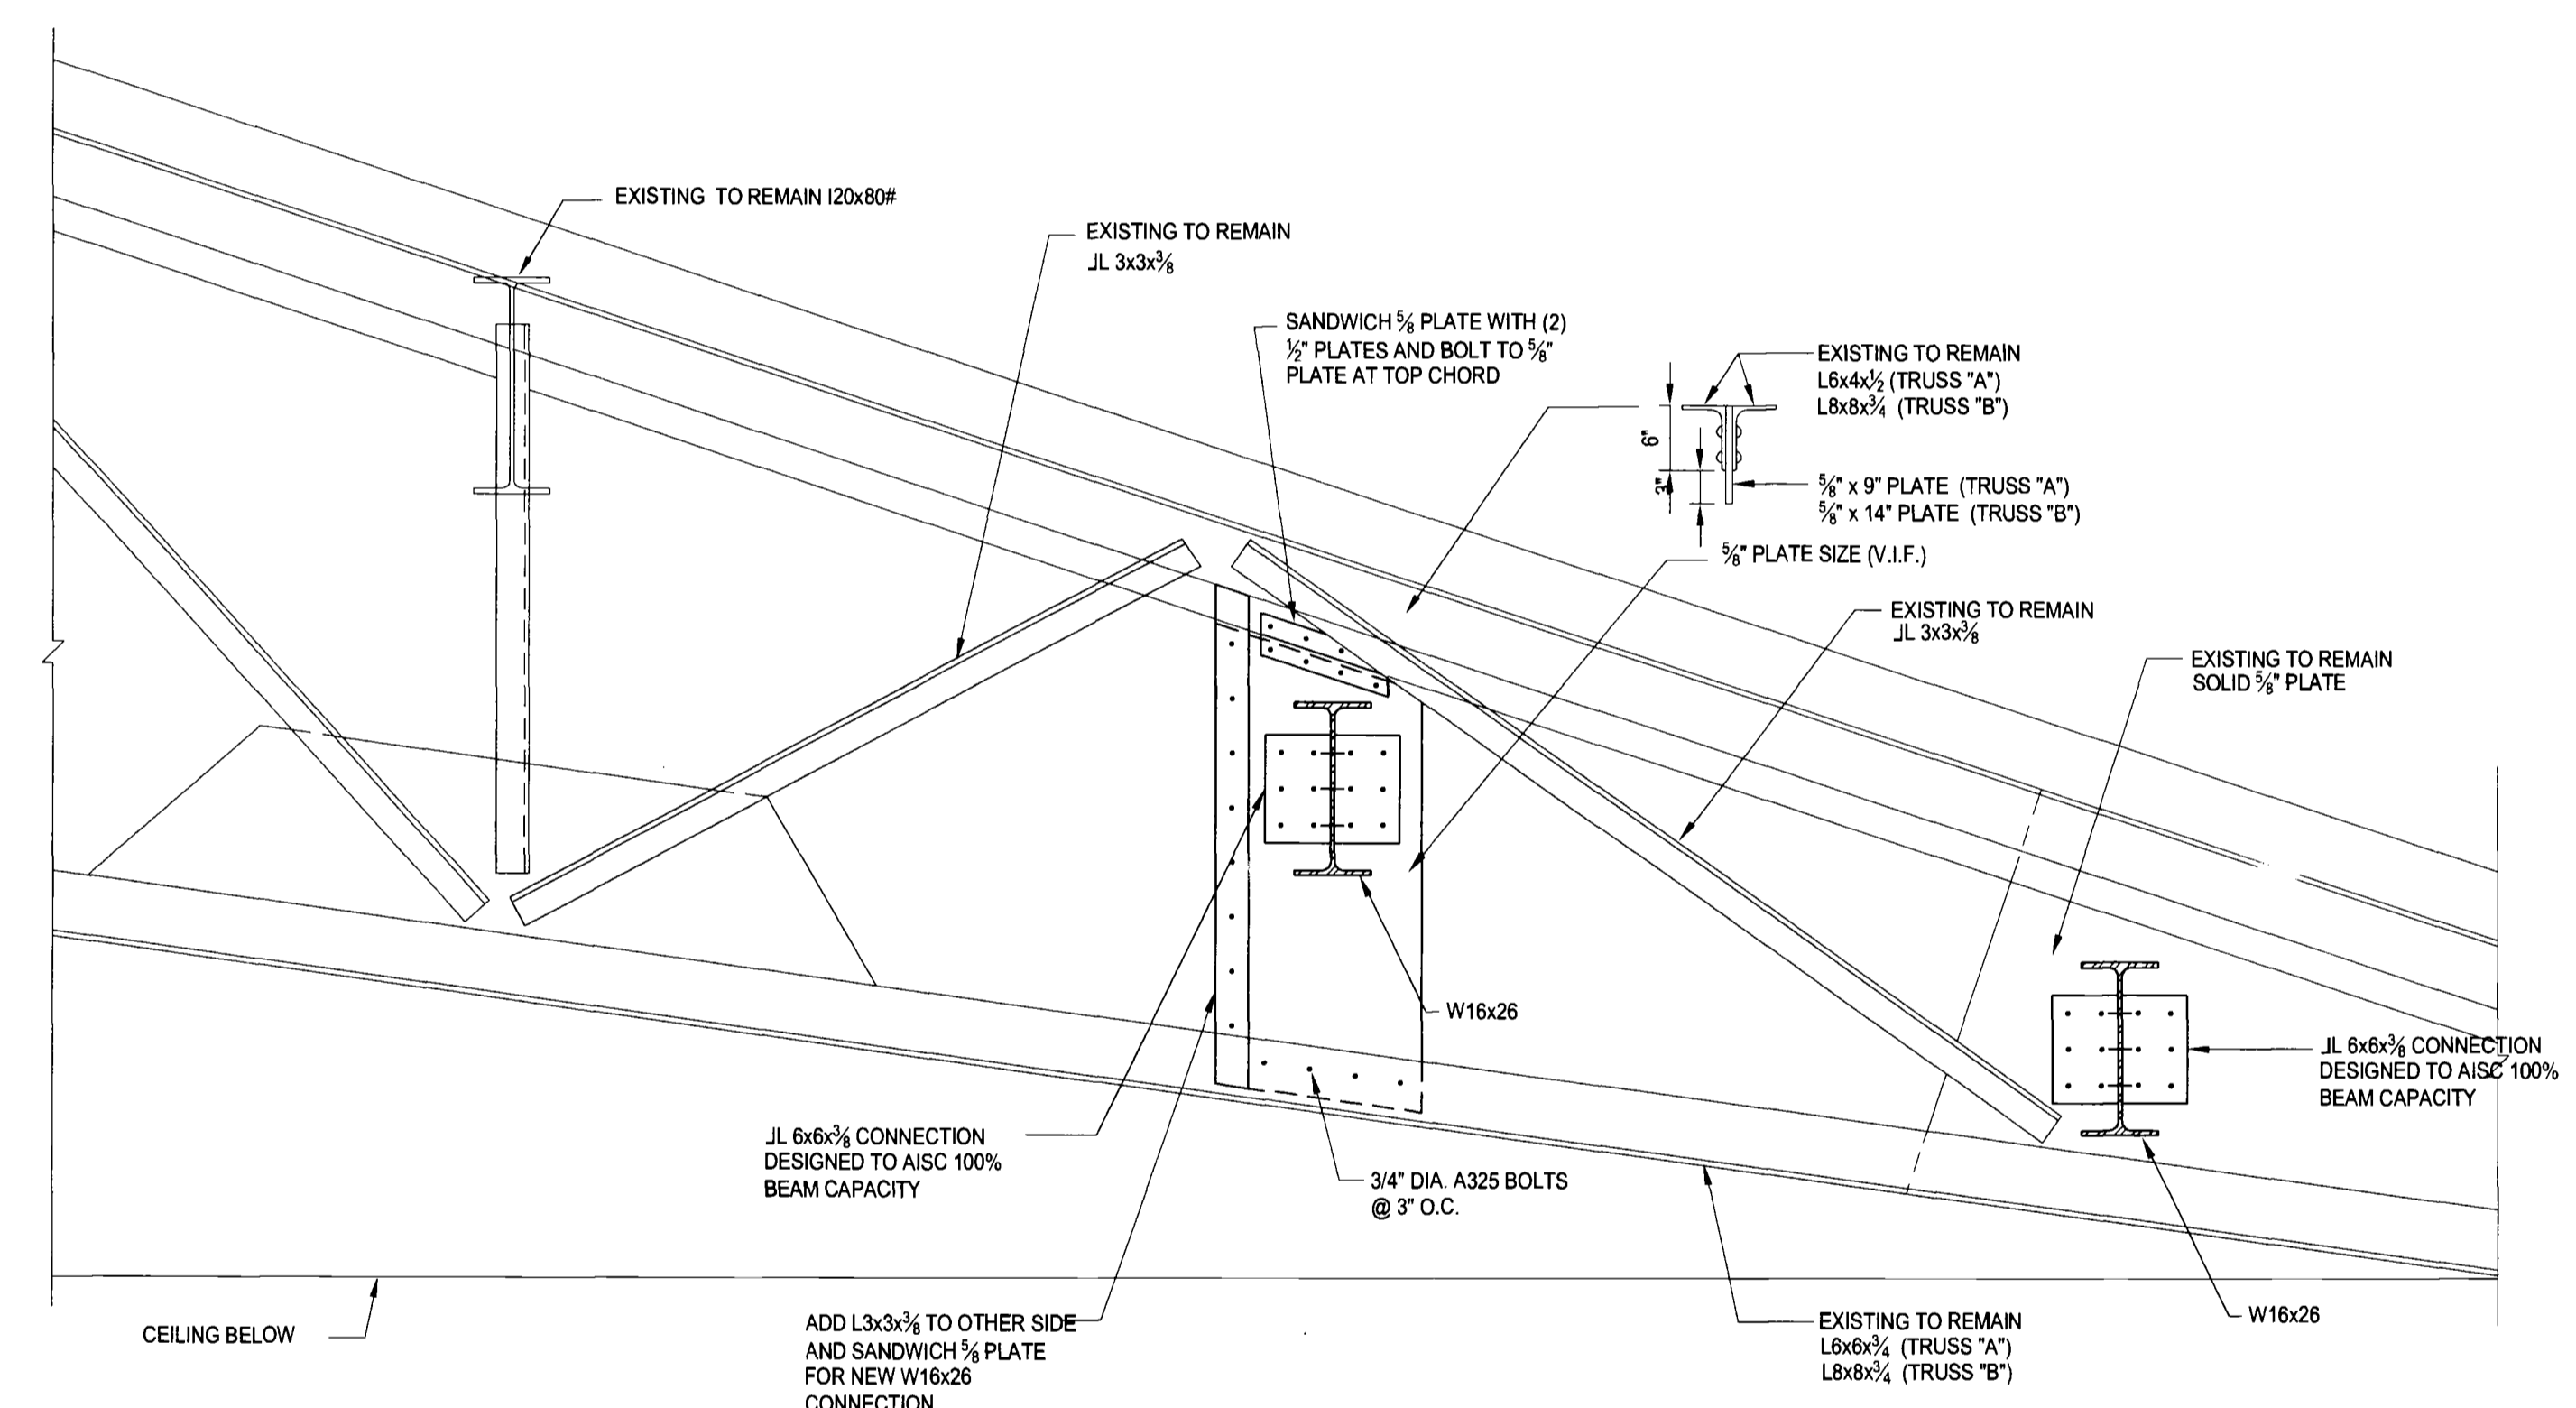


ROTUNDA PART ELEVATION OF TYPICAL TRUSS CONNECTION
SCALE: 3/4"=1'-0"
S304

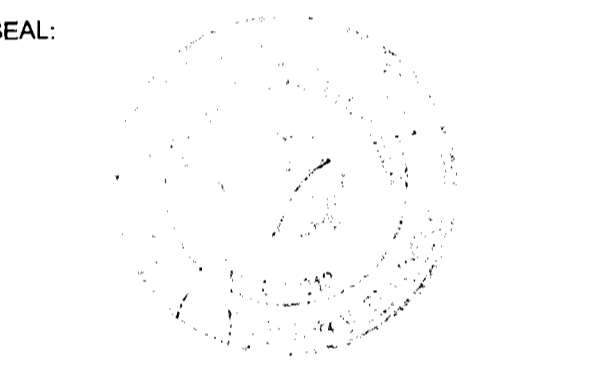

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DRAWING TITLE:

Sections

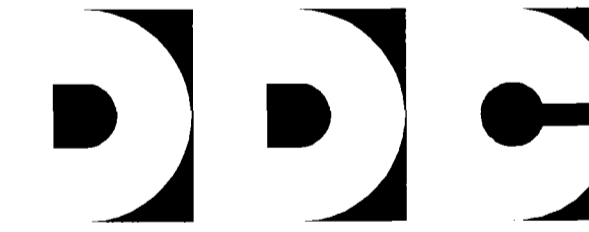DRAWN BY: SL SCALE: AS NOTED
CHECKED BY: JUM DATE: 10.08.10

DRAWING NUMBER:

S304.00


SHEET NUMBER:
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D.O.B. PERMIT APPLICATION

WALL AND FLOOR PENETRATION SCHEDULE						
LABEL	HALL (W) OR FLOOR (F)	PENETRATION TYPE	PENETRATION SIZE IN INCHES U.O.N. OPENING SIZE (W x D) OR CORE SIZE (DIAMETER)	WALL PENETRATION ELEVATION (BOTTOM OF STEEL)	ROOM LOCATION (SEE ARCHITECTURAL)	SECTION REFERENCE
SHEET 5102 BASEMENT PLAN - OPENINGS IN BASEMENT FLOOR SLAB (TYPICAL ELEVATION 31-10'12") OR IN WALLS BETWEEN BASEMENT AND SUB-BASEMENT						
102.01-FO	F	FLOOR OPENING	4'-0" x 4'-0"	-	000 TO TUNNEL	8/5303
102.02-FO	F	FLOOR OPENING	4'-0" x 4'-0"	-	000 TO TUNNEL	8/5303
102.03-FO	F	FLOOR OPENING	4'-0" x 4'-0"	-	000 TO TUNNEL	8/5303
102.04-L	W	LINTEL		SEE MECH	008M TO SUB-BASEMENT	7/5203
102.05-L	W	LINTEL		SEE MECH	008M TO TUNNEL	7/5203
102.06-HC	W	HORIZ. CORE	8"	BELOW SLAB ON GRADE @ CL ± 35'	EXTERIOR TO STAIR HALL	8/5201
102.07-S	F	HORIZ. SLEEVE	18"	BELOW SLAB ON GRADE	008 TO 000	8/5303
102.08-VCH	F	FLOOR CHASE & HATCH ACCESS	MATCH EXTENT OF EXIST DOOR THRESHOLD	-	022 TO 000	1/5303
102.09-VCH	F	FLOOR CHASE & HATCH ACCESS	MATCH EXTENT OF EXIST DOOR THRESHOLD	-	024 TO 000	1/5303
102.10-HC	W	CORE	3"	BELOW SLAB ON GRADE	024 TO 024	6/5201
102.11-HC	W	CORE		BELOW SLAB ON GRADE @ CL ± 35'	EXTERIOR TO 022A	8/5201
102.12-VCH	W	VERTICAL CHASE	SEE MECH	-	008M TO SUB-BASEMENT	11/5203
102.13-FO	F	(2) FLOOR OPENINGS	SEE MECH	-	012 TO TUNNEL	SEE PLAN FOR FRAMING
102.14-FO	F	FLOOR OPENING	4'-0" x 4'-0" (REINFORCE DECK)	-	012 TO TUNNEL	11/5203
102.15-FO	F	FLOOR OPENING	4'-0" x 4'-0" (CONST.) - 2'-0" x 2'-0" (FINAL)	-	012 TO TUNNEL	SEE PLAN FOR FRAMING
102.16-L	W	LINTEL	36"	TOP OF SLEEVE 7'-6" ABOVE BASE	024 TO 032	7/5203
102.17-MR	W	MASONRY REMOVAL/FCU	DEPTH 1'-8", HEIGHT 5'-4" VARIES, FULL WINDOW WIDTH	-	005	1/5302
102.18-MR	W	MASONRY REMOVAL/FCU	DEPTH 1'-8", HEIGHT 5'-4" VARIES, FULL WINDOW WIDTH	-	005	1/5302
102.19-MR	W	MASONRY REMOVAL/FCU	DEPTH 1'-8", HEIGHT 5'-4" VARIES, FULL WINDOW WIDTH	-	005	1/5302
102.20-MR	W	MASONRY REMOVAL/FCU	DEPTH 1'-8", HEIGHT 5'-4" VARIES, FULL WINDOW WIDTH	-	005	1/5302
102.21-MR	W	MASONRY REMOVAL/FCU	DEPTH 1'-8", HEIGHT 5'-4" VARIES, FULL WINDOW WIDTH	-	005	1/5302
102.22-MR	W	MASONRY REMOVAL/FCU	DEPTH 1'-8", HEIGHT 5'-4" VARIES, FULL WINDOW WIDTH	-	005	1/5302
102.23-MR	W	MASONRY REMOVAL/FCU	DEPTH 1'-8", HEIGHT 5'-4" VARIES, FULL WINDOW WIDTH	-	005	1/5302
102.24-MR	W	MASONRY REMOVAL/FCU	DEPTH 1'-8", HEIGHT 5'-4" VARIES, FULL WINDOW WIDTH	-	005	1/5302
102.25-MR	W	MASONRY REMOVAL/FCU	DEPTH 1'-8", HEIGHT 5'-4" VARIES, FULL WINDOW WIDTH	-	005	1/5302
102.26-VCH	F	(5) - CORES	4"	006E TO SUB-BASEMENT	2/5302, 7/5201, 11/5203	
102.27-VCH	F	(5) - CORES	4"	006E TO SUB-BASEMENT	2/5302, 7/5201, 11/5203	
102.28-VCH	F	(5) - CORES	4"	006E TO SUB-BASEMENT	2/5302, 7/5201, 11/5203	
102.29-VCH	F	(5) - CORES	4"	006E TO SUB-BASEMENT	2/5302, 7/5201, 11/5203	
102.430-VCH	F	(5) - CORES	4"	006E TO SUB-BASEMENT	2/5302, 7/5201, 11/5203	
102.31-VCH	F	(5) - CORES	4"	006E TO SUB-BASEMENT	2/5302, 7/5201, 11/5203	
102.32-VCH	F	(5) - CORES	4"	006E TO SUB-BASEMENT	2/5302, 7/5201, 11/5203	
102.33-VCH	F	(5) - CORES	4"	006E TO SUB-BASEMENT	2/5302, 7/5201, 11/5203	
102.34-VCH	F	(5) - CORES	4"	006E TO SUB-BASEMENT	2/5302, 7/5201, 11/5203	
102.35-VCH	F	(5) - CORES	4"	006E TO SUB-BASEMENT	2/5302, 7/5201, 11/5203	
102.36-VCH	F	(2) - CORES	4"	006E TO SUB-BASEMENT	2/5302, 7/5201, 11/5203	
102.37-VCH	W	VERT. CHASE - ENLARGE EXIST	EXPAND TO 6"x20"	-	000	4/5203
102.38-VCH	W	VERT. CHASE - ENLARGE EXIST	EXPAND TO 6"x20"	-	000	4/5203
102.39-VCH	W	VERT. CHASE - ENLARGE EXIST	EXPAND TO 6"x20"	-	000	4/5203
102.40-VCH	W	VERT. CHASE - ENLARGE EXIST	EXPAND TO 6"x20"	-	000	4/5203
102.41-VCH	F	FLOOR CHASE & HATCH ACCESS	MATCH EXTENT OF EXIST DOOR THRESHOLD	-	022 TO 000	1/5303
102.42-VCH	W	VERT. SLEEVE	SEE MECH	SEE MECH	FROM 000 TO 005	6/5303
102.43-FO	F	ACCESS HATCH	4'-0" x 4'-0" (CONST.) - 2'-0" x 2'-0" (FINAL)	-	012 TO TUNNEL	SEE PLAN FOR FRAMING
102.44-MR	W	MASONRY REMOVAL/FCU	DEPTH 1'-8", HEIGHT 5'-4" VARIES, FULL WINDOW WIDTH	-	006 PRESS ROOM	1/5302
102.45-MR	W	MASONRY REMOVAL/FCU	DEPTH 1'-8", HEIGHT 5'-4" VARIES, FULL WINDOW WIDTH	-	006 PRESS ROOM	1/5302
102.46-VCH	-	ELIMINATED	ELIMINATED	-	ELIMINATED	ELIMINATED
SHEET 5103 FIRST FLOOR - OPENINGS IN FIRST FLOOR SLAB (TYPICAL ELEVATION 48-10'10") OR IN WALLS BETWEEN FIRST FLOOR AND BASEMENT FLOOR						
103.01-HC	W	HORIZ. CORE WITH GROUDED SLEEVE	8"	BETWEEN JOISTS	006L TO 006D	8/5203
103.02-HC	W	(4) HORIZ. CORE WITH GROUDED SLEEVES	8"	BETWEEN JOISTS	006L TO 006D	8/5203
103.03-HC	W	HORIZ. CORE WITH GROUDED SLEEVE	4"	BETWEEN JOISTS	006L TO 006D	8/5203
103.04-HC	W	(2) HORIZ. CORE WITH GROUDED SLEEVES	8"	BETWEEN JOISTS	006D TO 006E	8/5203
103.05-HC	W	HORIZ. CORE WITH GROUDED SLEEVE	4"	BETWEEN JOISTS	006D TO 006E	8/5203
103.06-HC	W	HORIZ. CORE WITH GROUDED SLEEVE	12"	BETWEEN JOISTS	006D TO 006E	8/5203
103.07-L	W	LINTEL	72"	DIRECTLY BELOW JOISTS	006N TO 006B	5/5203
103.08-L	W	LINTEL	40x28	DIRECTLY BELOW JOISTS	006B TO 006F	5/5203
103.09-L	W	LINTEL	48"	9'-3" ABOVE BSMT FLOOR	006J TO 012	5/5203
103.10-FO	F	FLOOR OPENING	SEE MECH	THROUGH FLOOR	107 TO 005A	5/5303
103.11-VCH	F	FLOOR CHASE	SEE MECH	FROM BASE TO 1ST FLOOR	001 TO 108	5/5303
103.12-S	W	HORIZ. SLEEVE	14-8	9'-1" ABOVE BSMT FLOOR	005B TO 005A	8/5203
103.13-S	W	HORIZ. SLEEVE	18-8	9'-1" ABOVE BSMT FLOOR	005A TO 005C	8/5203
103.14-L	W	LINTEL	DOOR + DUCT	AS HIGH AS POSSIBLE	005A TO STAIR HALL	7/5203
103.15-L	W	LINTEL	48"x18"	9'-4" ABOVE BSMT FLOOR	006 TO 006	5/5203
103.16-MR	F	FLOOR OPENING	18x10	THROUGH 1ST FLOOR	107 TO 005A	5/5303
103.17-L	W	LINTEL	26x16	9'-4" ABOVE BSMT FLOOR	006 TO 000	7/5203
103.18-MR	F	FLOOR OPENING	18x10	THROUGH 1ST FLOOR	105 TO 006A	5/5303
103.19-L	W	LINTEL	26x20 & 36x20	9'-4" ABOVE BSMT FLOOR	006 TO 020	5/5203
103.20-L	W	LINTEL	30x28	9'-4" ABOVE BSMT FLOOR	022 TO 023	7/5203
103.21-L	-	ELIMINATED	ELIMINATED	-	ELIMINATED	ELIMINATED
103.22-MR	F	FLOOR OPENING	20x14	ELIMINATED	ELIMINATED	5/5303
103.23-S	W	HORIZ. SLEEVE	20x8 (MUST BE 20" WIDE)	B.O. SLEEVE 7'-6" ABOVE BSMT FLOOR	023 TO 024	8/5203
103.24-S	W	CORE & ROUND SLEEVE	18"	B.O. SLEEVE 8'-4" ABOVE BSMT FLOOR	024 TO 000	8/5203
103.25-S	W	CORE & ROUND SLEEVE	18"	B.O. SLEEVE 8'-4" ABOVE BSMT FLOOR	024 TO 000	8/5203
103.26-S	W	CORE & ROUND SLEEVE	18"	B.O. SLEEVE 8'-4" ABOVE BSMT FLOOR	024 TO 000	8/5203
103.27-HCH	W	HORIZ. CHASE	24x12	BELOW WINDOW	023 TO 044	8/5203
103.28-FO	F	FRAMED OPENING	22x10	THROUGH WOOD FLOOR	025 TO 021	5/5302
103.29-L	W	(4) - CORES (LINTELED)	(2) 10" & (2) 8"	9'-4" ABOVE BSMT FLOOR	015 TO 018	7/5203
103.30-L	W	LINTEL	(2) 10x9 & (2) 18x8	9'-4" ABOVE BSMT FLOOR	012 TO 015	7/5203
103.31-S	W	HORIZ. SLEEVE	16-8	9'-4" ABOVE BSMT FLOOR	012 TO 014	8/5203
103.32-S	W	HORIZ. SLEEVE	16-8	9'-4" ABOVE BSMT FLOOR	012 TO 014	8/5203
103.33-MR	F	MASONRY REMOVAL/FCU	4"	107 TO 005A	5/5302	
103.34-MR	F	MASONRY REMOVAL/FCU	4"	107 TO 005A	5/5302	
103.35-MR	F	MASONRY REMOVAL/FCU	4"	107 TO 005A	5/5302	
103.36-MR	F	MASONRY REMOVAL/FCU	4"	107 TO 005A	5/5302	
103.37-MR	F	MASONRY REMOVAL/FCU	4"	107 TO 005A	5/5302	
103.38-MR	F	MASONRY REMOVAL/FCU	4"	107 TO 005A	5/5302	
103.39-MR	F	MASONRY REMOVAL/FCU	4"	107 TO 005A	5/5302	
103.40-MR	F	MASONRY REMOVAL/FCU	4"	107 TO 005A	5/5302	
103.41-L	W	LINTEL	36"	1573 TO 100	7/5203	
103.42-L	W	LINTEL	54"	HIGH AS POSSIBLE	006B TO 006N	5/5203
103.43-MR	F	FLOOR OPENING	18x10	THROUGH 1ST FLOOR	131 TO 024	5/5303
103.44-FO	F	FLOOR OPENING	(2) 8' x (2) 7' 11" 1/2"	THROUGH 1ST FLOOR	131 TO 024	5/5303
103.45-FO	F	FLOOR OPENING/PIPE CHASE	38x10	THROUGH 1ST FLOOR	131 TO 025	5/5303
103.46-FO	F	FRAMED FLOOR OPENING	20x12	THROUGH 1ST FLOOR	117 TO 018	SEE PLAN FOR FRAMING
103.47-FO	F	FRAMED FLOOR OPENING	10x12	THROUGH BRICK ARCH	117 TO 018	SEE PLAN FOR FRAMING
103.48-FO	F	FRAMED FLOOR OPENING	14" x 18" @ (2) 7/8" @ (1) 5"	THROUGH BRICK ARCH	104 TO 012	8/5203
103.49-FO	F	FRAMED FLOOR OPENING	12x26	THROUGH WINDOW HEADER	105 TO 006	SEE PLAN FOR FRAMING
103.50-FO	F	FRAMED FLOOR OPENING	14x24	THROUGH WINDOW HEADER	105 TO 006	SEE PLAN FOR FRAMING
103.51-MR	F	MASONRY REMOVAL/FCU	4"	THROUGH WINDOW HEADER	115 TO 006	5/5302
103.52-MR	F	MASONRY REMOVAL/FCU	4"	THROUGH WINDOW HEADER	115 TO 006	5/5302
103.53-MR	F	MASONRY REMOVAL/FCU	4"	THROUGH WINDOW HEADER	114 TO 006	5/5302
103.54-MR	F	MASONRY REMOVAL/FCU	4"	THROUGH WINDOW HEADER	113 TO 006	5/5302
103.55-MR	F	MASONRY REMOVAL/FCU	4"	THROUGH WINDOW HEADER	112 TO 006	5/5302
103.56-MR	F	MASONRY REMOVAL/FCU	4"	THROUGH WINDOW HEADER	111 TO 006	5/5302
103.57-MR	F	MASONRY REMOVAL/FCU	4"	THROUGH WINDOW HEADER	111 TO 006	5/5302
103.58-MR	F	MASONRY REMOVAL/FCU	4"	THROUGH WINDOW HEADER	111 TO 006	5/5302
103.59-MR	F	MASONRY REMOVAL/FCU	4"	THROUGH WINDOW HEADER	111 TO 006	5/5302
103.60-MR	F	MASONRY REMOVAL/FCU	4"	THROUGH WINDOW HEADER	111 TO 006	5/5302
103.61-MR	F	MASONRY REMOVAL/FCU	4"	THROUGH WINDOW HEADER	108 TO 001	5/5302
103.62-MR	F	MASONRY REMOVAL/FCU	4"	THROUGH WINDOW HEADER	108 TO 001	5/5302
103.63-VCH	W	VERT. CHASE	6"x20"	BASE TO 1ST FLOOR	100	5/5302
103.64-VCH	W	VERT. CHASE	6"x20"	BASE TO 1ST FLOOR	100	5/5302
103.65-VCH	W	VERT. CHASE	6"x20"	BASE TO 1ST FLOOR	100	5/5302
103.66-HC	W	VERT. CHASE	9"x20"	BASE TO 1ST FLOOR	100	5/5302
103.67-HCH	-	ELIMINATED	ELIMINATED	-	ELIMINATED	-
103.68-S	W	HORIZ. SLEEVE	16x18	BELOW WINDOW	117 TO EXTERIOR	8/5203
103.69-HCH	-	ELIMINATED	ELIMINATED	-	ELIMINATED	-
103.70-HCH	-	ELIMINATED	ELIMINATED	-	ELIMINATED	-
103.71-MR	W	FLOOR OPENING	20'x12'	FLOOR OPENING	FROM 022 TO 023	2/5303
103.72-L	W	LINTEL	37"x12"	9'-4" ABOVE BSMT FLOOR	FROM 012 TO 017	8/5203
103.73-S	W	HORIZ. SLEEVE	18"x10"	9'-4" ABOVE BSMT FLOOR	FROM 012 TO 017	8/5203
103.74-S	-	ELIMINATED	ELIMINATED	-	ELIMINATED	-
103.75-S	W	HORIZ. SLEEVE	24x24	SEE MECH	006L TO 006D	8/5203
103.76-L	W	LINTEL	42"	9'-4" ABOVE BSMT FLOOR	006L TO 012	7/5203
103.77-L	W	LINTEL	48x18	9'-4" ABOVE BSMT FLOOR	006L TO 012	7/5203
103.78-S	W	HORIZ. SLEEVE	16x8	T.O. SLEEVE 7'-6" ABOVE BSMT	023 TO 024	8/5203
SHEET 5104 SECOND FLOOR - OPENINGS IN SECOND FLOOR SLAB (TYPICAL ELEVATION 66-0'12") OR IN WALLS BETWEEN SECOND FLOOR AND FIRST FLOOR						
104.01-L	-	ELIMINATED	ELIMINATED	-	ELIMINATED	ELIMINATED
104.02-L	W	LINTEL	(3) 5' x (2) 7"	16'-0" ABOVE 1ST FLOOR	122 TO 120	7/5203
104.03-L	W	LINTEL	(3) 5' x (2) 7"	16'-0" ABOVE 1ST FLOOR	118 TO 117	7/5203
104.04-S	W	HORIZ. SLEEVE	(5) 4"	16'-0" ABOVE 1ST FLOOR	117 TO 103	8/5203
104.05-S	W	HORIZ. SLEEVE	(3) 5' x (3) 4"	16'-0" ABOVE 1ST FLOOR	103 TO 104	8/5203
104.06-S	W	HORIZ. SLEEVE	16-8	16'-2" TOP OF SLEEVE	117 TO 103	8/5203
104.07-S	W	HORIZ. SLEEVE	16-8	16'-2" TOP OF SLEEVE	103 TO 104	8/5203
104.08-S	W	HORIZ. SLEEVE	18-10	16'-2" TOP OF SLEEVE	104 TO 116	8/5203
104.09-S	W	(2) CORES AND SLEEVE	7"	HIGH AS POSSIBLE	104 TO 113	8/5203

WALL AND FLOOR PENETRATION SCHEDULE						
LABEL	HALL (W) OR FLOOR (F)	PENETRATION TYPE	PENETRATION SIZE IN INCHES U.O.N			



1 Roof Framing Plan
1/8" = 1'-0"

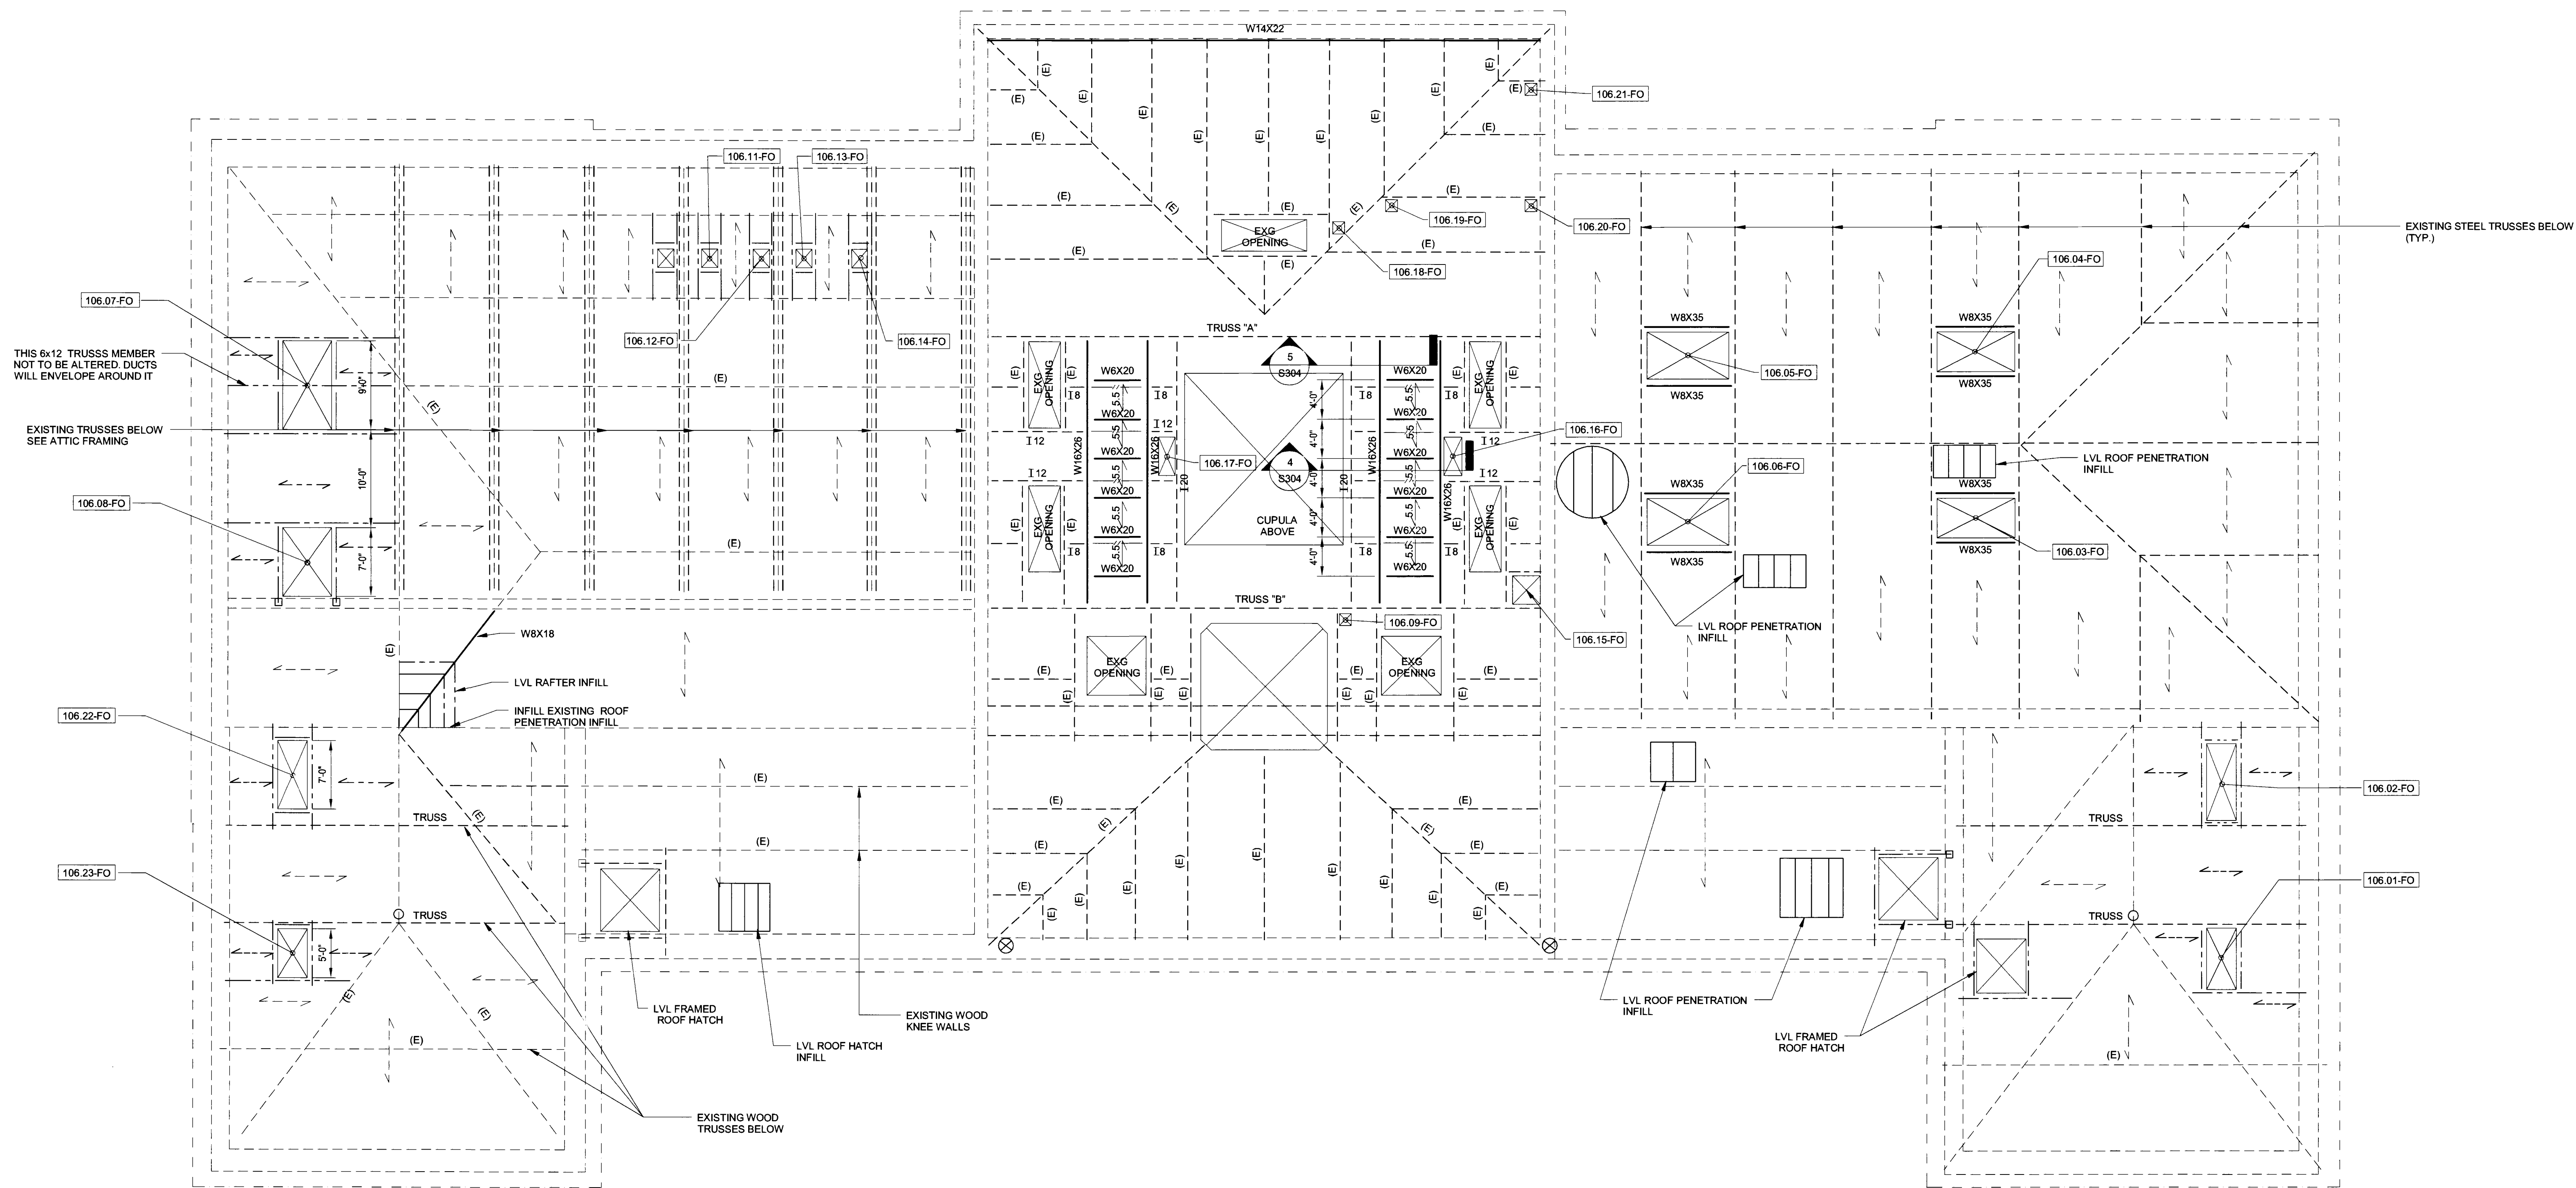LEGEND:

- INDICATES DIRECTION OF EXISTING 3"x12" WOOD RAFTERS/JOISTS (TYP) ACTUAL SIZE MAY VARY. VERIFY ALL EXISTING FRAMING DIMENSIONS IN FIELD. NOTIFY ENGINEER AND ARCHITECT OF ANY DISCREPANCIES FOUND.
- W INDICATES NEW STEEL BEAM.
- (E) INDICATES EXISTING STEEL BEAM TO REMAIN.
- (E) INDICATES NEW (2) 1 3/4"x9" LVL, U.O.N. ATTACH WITH SIMPSON HHU5410 HANGERS.
- (E) INDICATES EXISTING WOOD FRAMING.
- INDICATES NEW 1 3/4" x EXISTING JOIST DEPTH LVL @ 16" O.C. U.O.N.
- INDICATES EXISTING MASONRY WALL BELOW TO REMAIN.
- XXX-XXX-X INDICATES MECHANICAL PENETRATION IN WALL OR FLOOR. SEE S305 AND THIS SHEET FOR SCHEDULE LEGEND AND DETAILS.
- XXX-XX-FO INDICATES ROOF OPENING.
- INDICATES NEW STEEL GRATING FOR MECHANICAL CATWALK BELOW. SEE SPECS FOR ATTACHMENT TO STRUCTURE AND FOLLOW MANUFACTURERS REQUIREMENTS AND RECOMMENDATIONS.
- 5.5 INDICATES 3 1/2" LW CONC SLAB ON 2" 15" GA COMPOSITE METAL DECK REINF WITH MACRO FIBERS TOTAL THICKNESS = 5 1/2"
- INDICATES LVL 1 3/4" X 7 1/4" @ 16" O.C. FRAMED REPAIR WITH SIMPSON HU7 FACE MOUNT JOIST HANGERS

NOTES:

1. COOLING TOWER FRAMING LAYOUT IS BASED ON LIMITED FIELD SURVEY INFORMATION. THE COOLING TOWER FRAMING SHOWN ON THIS DRAWING MUST BE FIELD VERIFIED.
2. PLAN INDICATES ROOF FRAMING WITH ATTIC WALLS BELOW.
3. SEE S200 SERIES FOR ALL TYPICAL DETAILS.
4. ALL EXISTING FRAMING SHOWN IS BASED ON LIMITED FIELD SURVEY INFORMATION AND IS SHOWN SCHEMATICALLY. ALL EXISTING FRAMING IS TO BE VERIFIED IN FIELD.
5. NO FIELD WELDING PERMITTED EXCEPT WHERE APPROVED BY DDC.
6. SEE PENETRATION SCHEDULE ON S305 AND LEGEND ON THIS SHEET FOR INFORMATION ON ALL PENETRATIONS INDICATED ON PLAN. PENETRATIONS NOTED THUS: SHEET NUMBER, PENETRATION NUMBER - TYPE [EX:102XX-X] COORDINATE WITH ARCHITECTURAL DRAWINGS.

SEAL:



REVISIONS:

NUMBER	DESCRIPTION	DATE




DIVISION OF STRUCTURES
BUREAU OF ARCHITECTURE & ENGINEERING



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CITY HALL 2
PROJECT NAME:
Renovation of City Hall
Bid Package 2

FOR THE:


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Roof Framing Plan

DRAWN BY: SI
CHECKED BY:
DRAWING N°

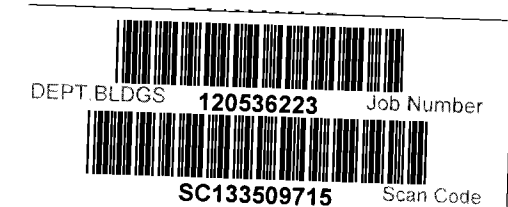

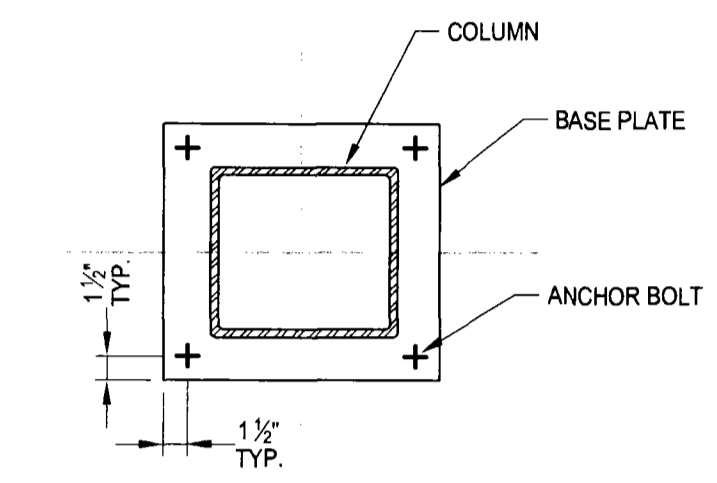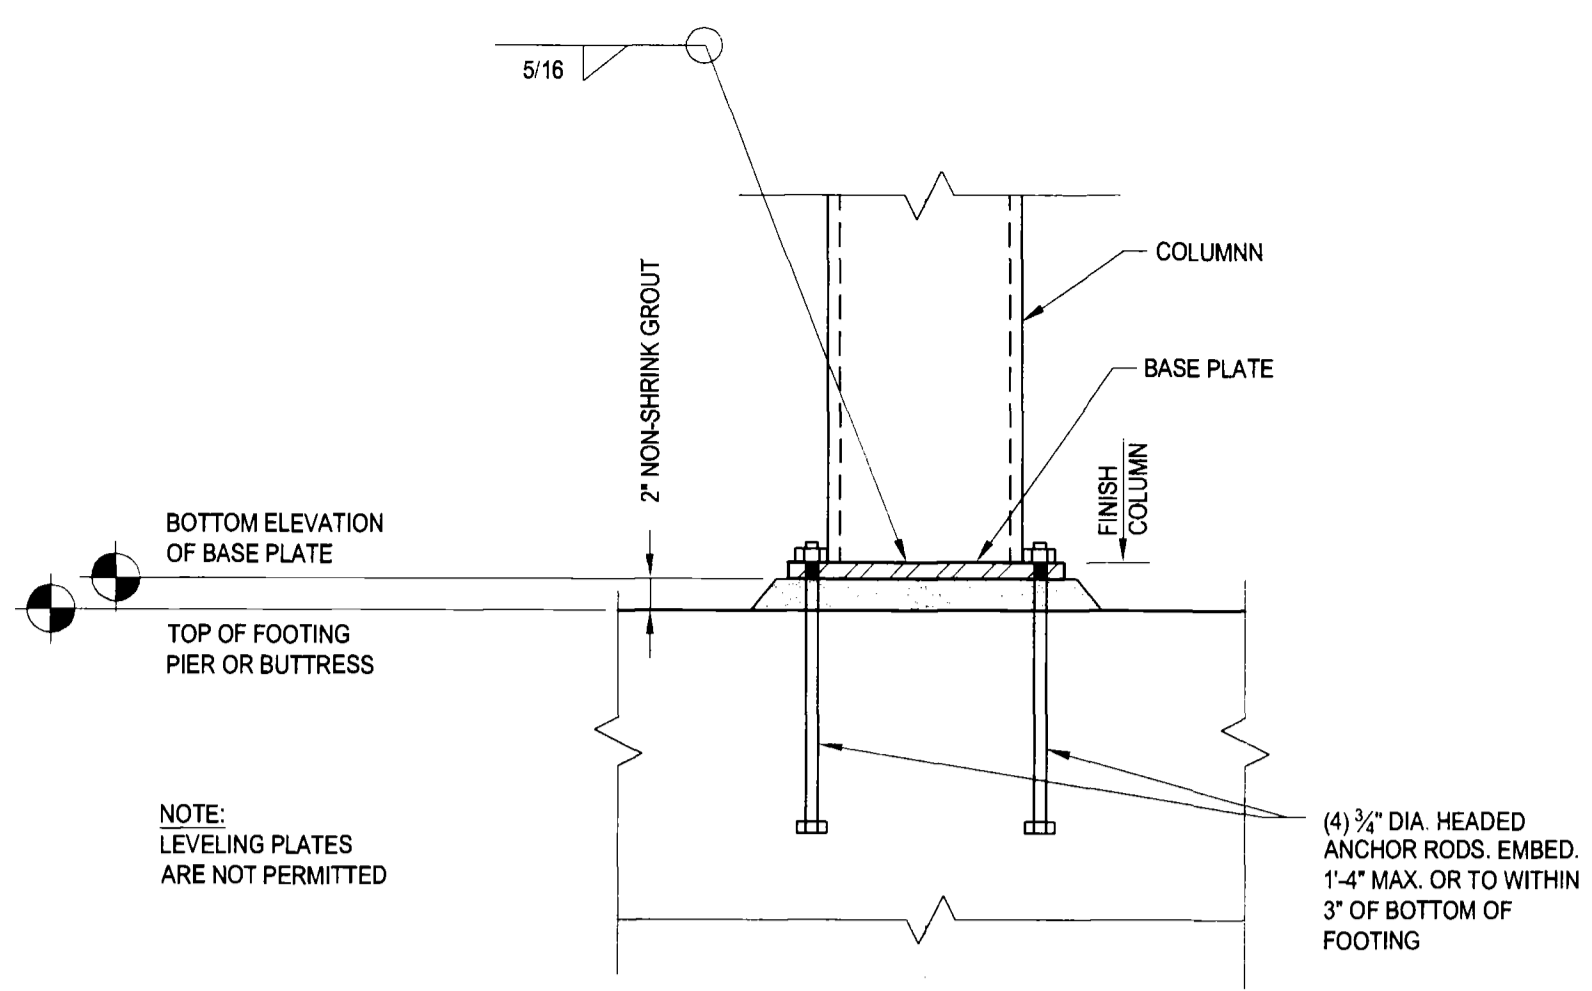


TYPICAL DETAIL COLUMN BASE PLATE PIPE OR TUBE COLUMN
SCALE: 1"=1'-0"

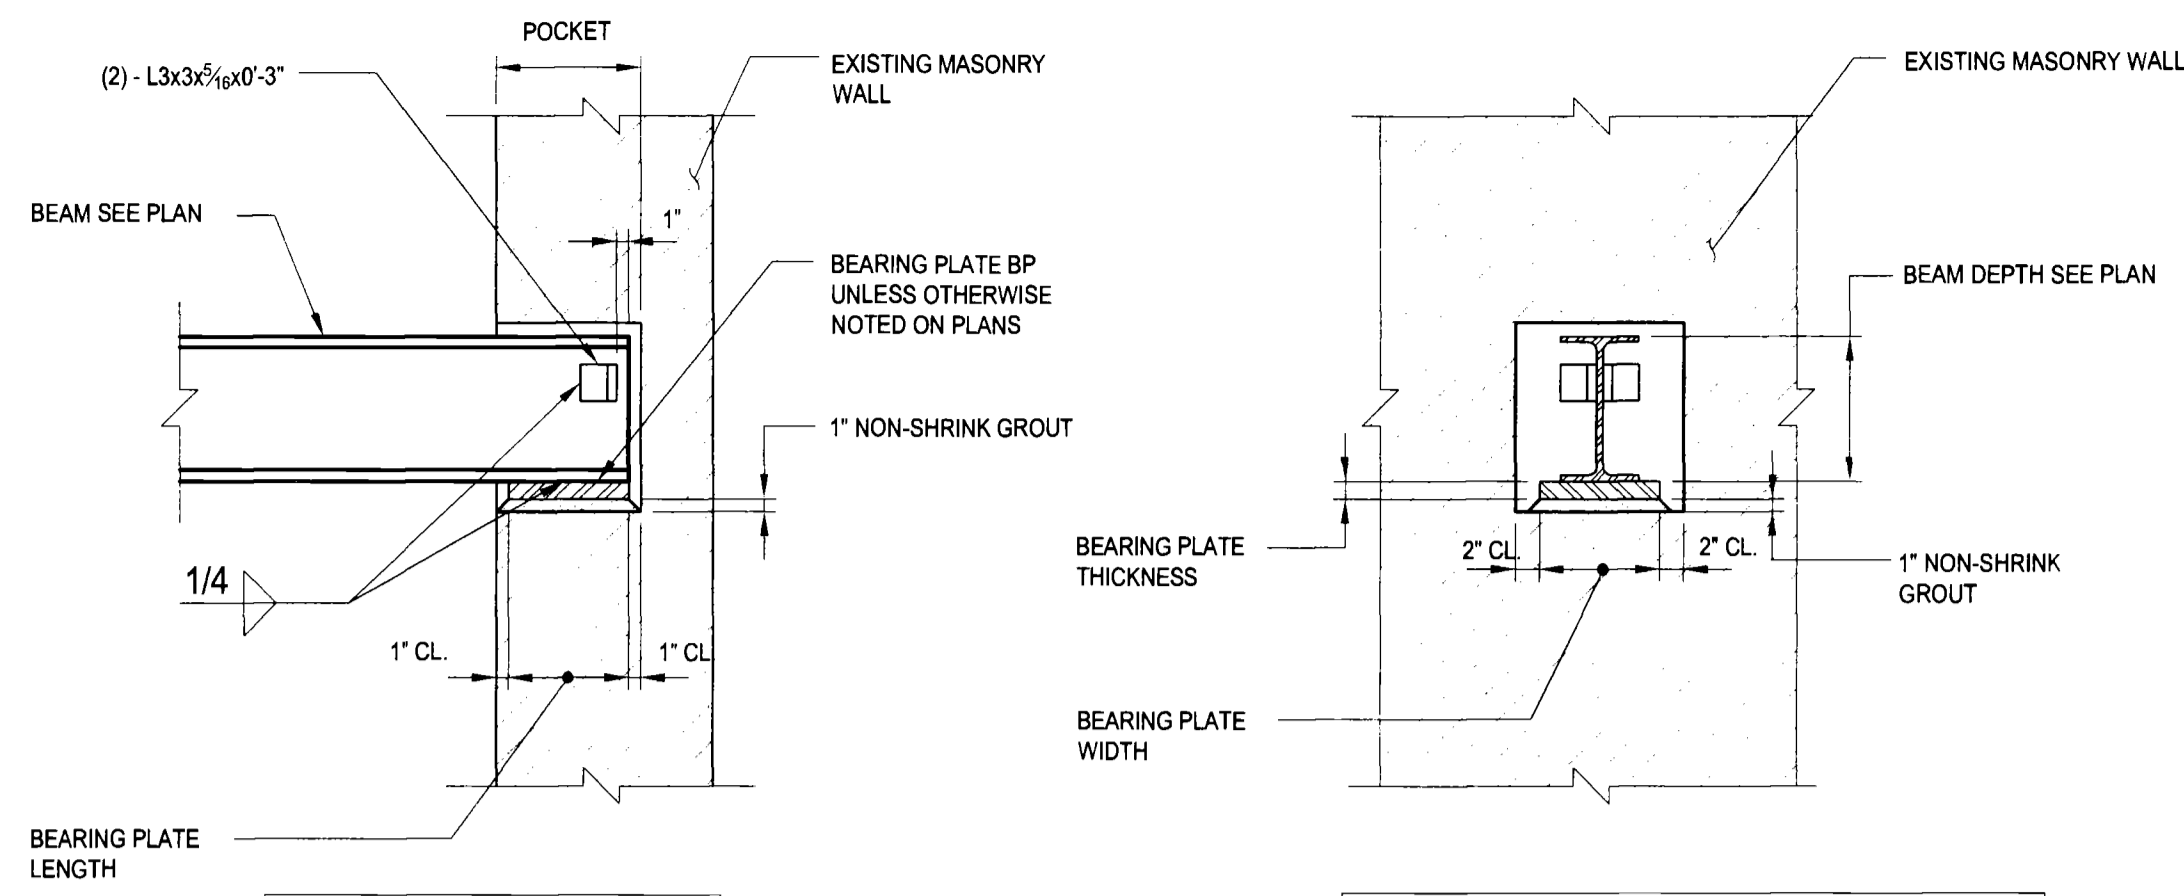


BEARING PLATE SCHEDULE

MARK	LENGTH (L TO BM)	WIDTH (L TO BM)	THICKNESS
BP-1	6	6	3/8
BP-2	6	11	3/4
BP-3	6	(WALL THICKNESS - 1")	3/4


TYPICAL DETAIL BEAM BEARING ON EXISTING WALL
SCALE: 3/4"=1'-0"

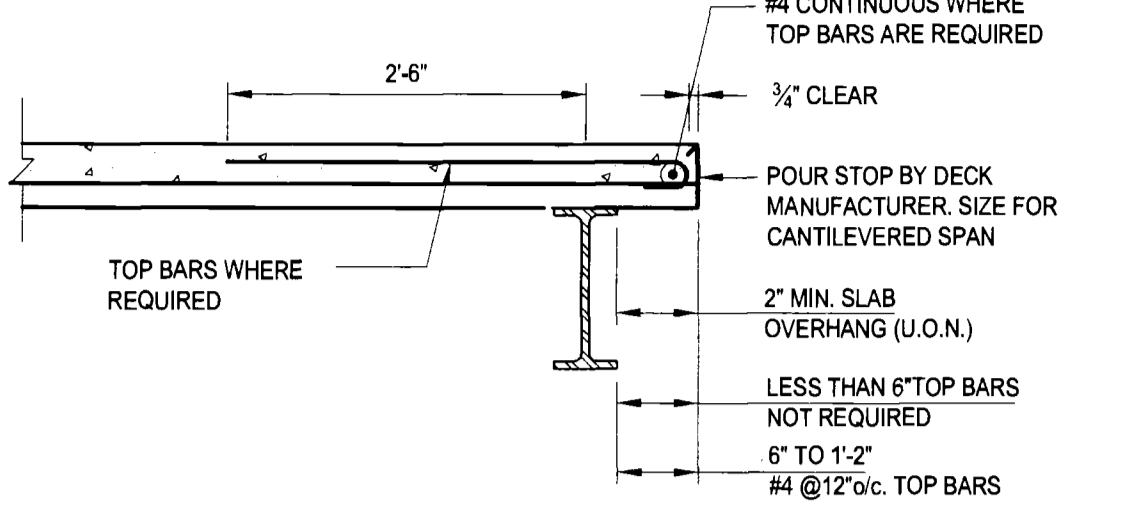

TYPICAL DETAIL COMPOSITE FLOOR DECK PERPENDICULAR EDGE CONDITION
SCALE: 3/4"=1'-0"

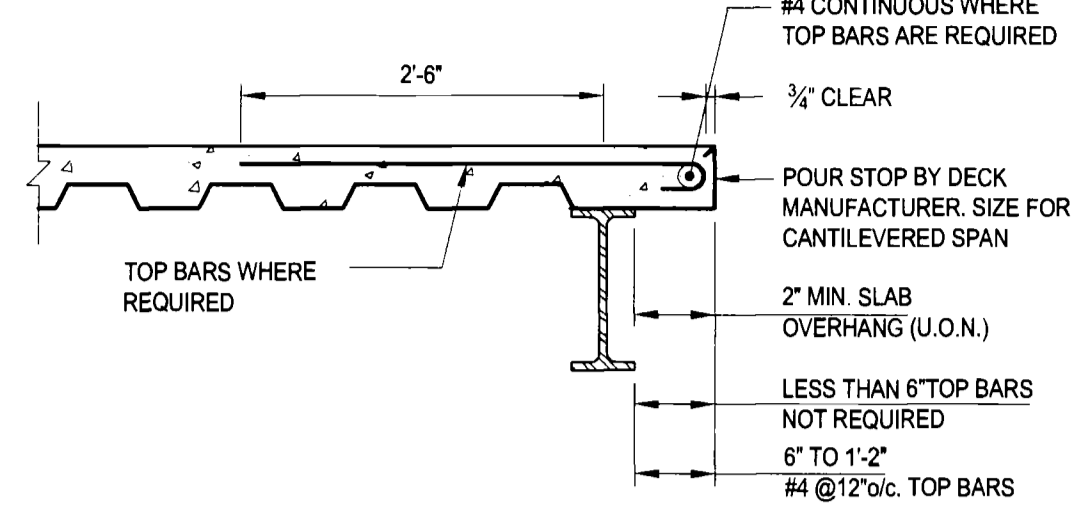


TYPICAL DETAIL COMPOSITE FLOOR DECK PARALLEL EDGE CONDITION
SCALE: 3/4"=1'-0"

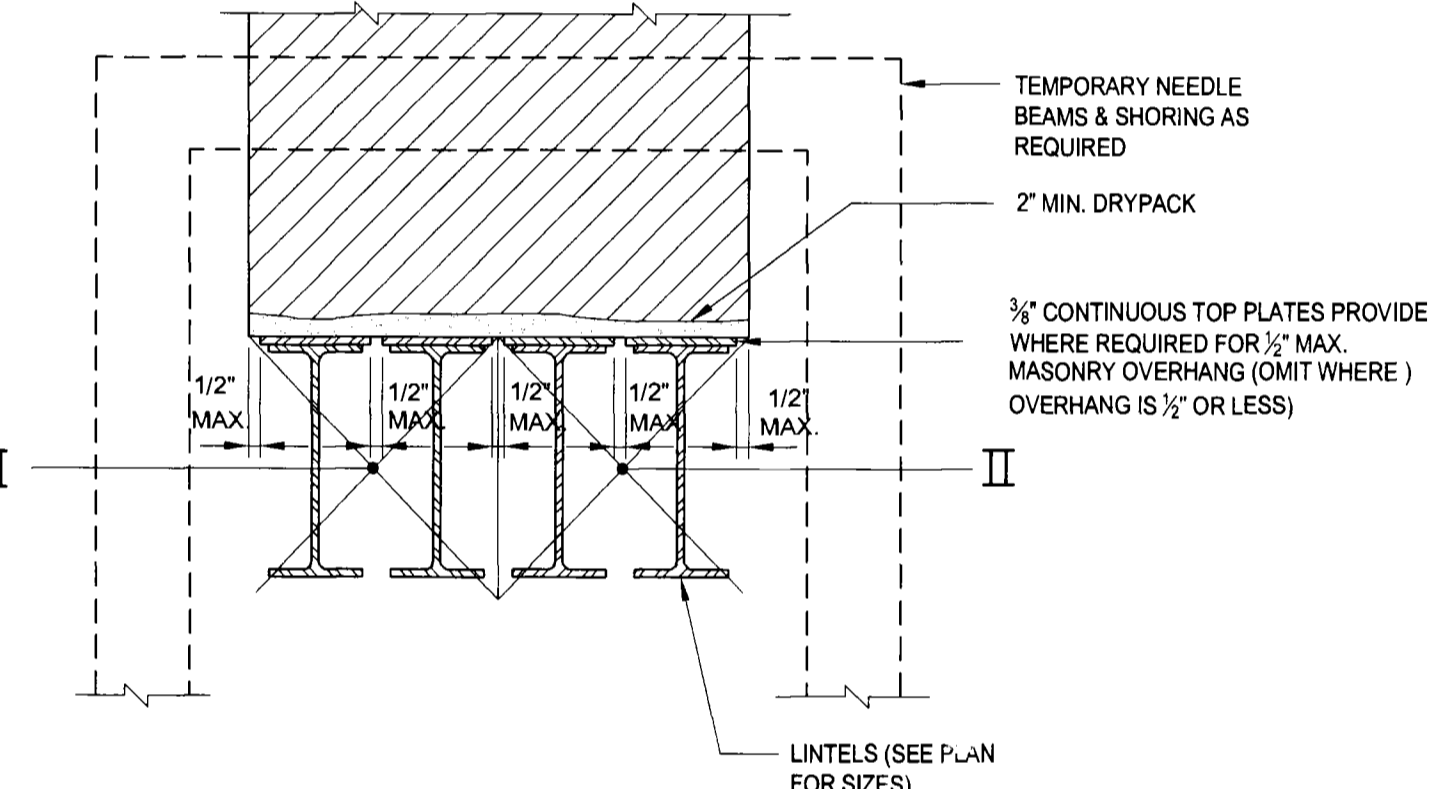


TYPICAL WF LINTEL IN INTERIOR WALL
SCALE: 1"=1'-0"


- SEQUENCE OF CONSTRUCTION**
1. PROVIDE NEEDLING AND SHORING AS REQUIRED FOR EXISTING WALL ABOVE.
 2. INSTALL BEARING PLATE AT EACH END FOR LINTEL BEAM BEARING ON EXISTING WALL.
 3. CHASE OUT EXISTING MASONRY AT I AND INSTALL NEW LINTEL BEAM(S).
 4. PROVIDE CONTINUOUS DRYPACK ABOVE LINTEL.
 5. AFTER DRYPACK AT I HAS SET REPEAT STEPS 2 THRU 4 FOR LINTEL BEAM(S) II.
 6. INSTALL BOLT AND PIPE SEPARATORS AT LINTEL SPAN 1/3 POINTS AND AT EACH END.
 7. REMOVE WALL BELOW LINTEL AT NEW OPENING.

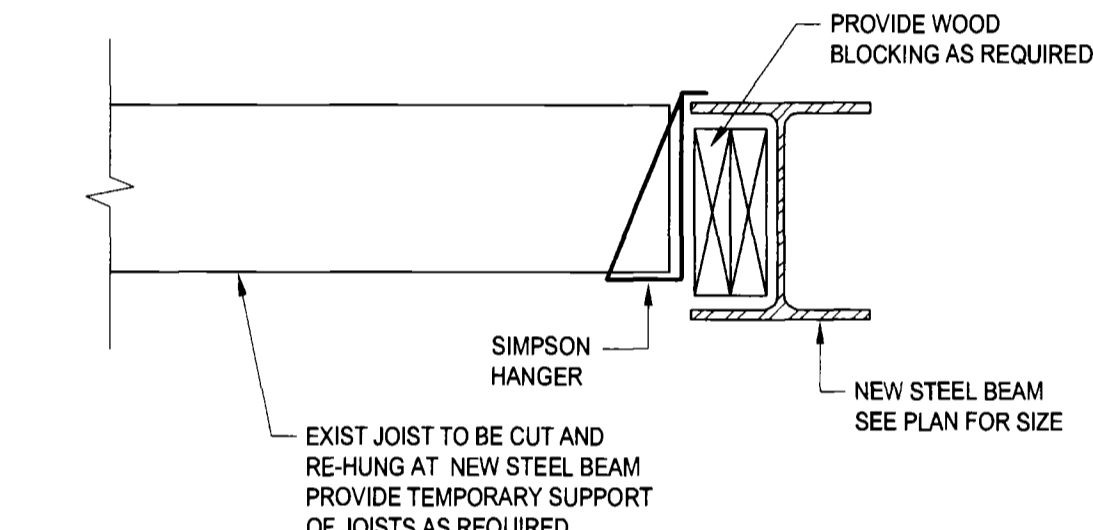


TYPICAL DETAIL EXISTING WOOD JOIST AT NEW STEEL BEAM
SCALE: 1"=1'-0"

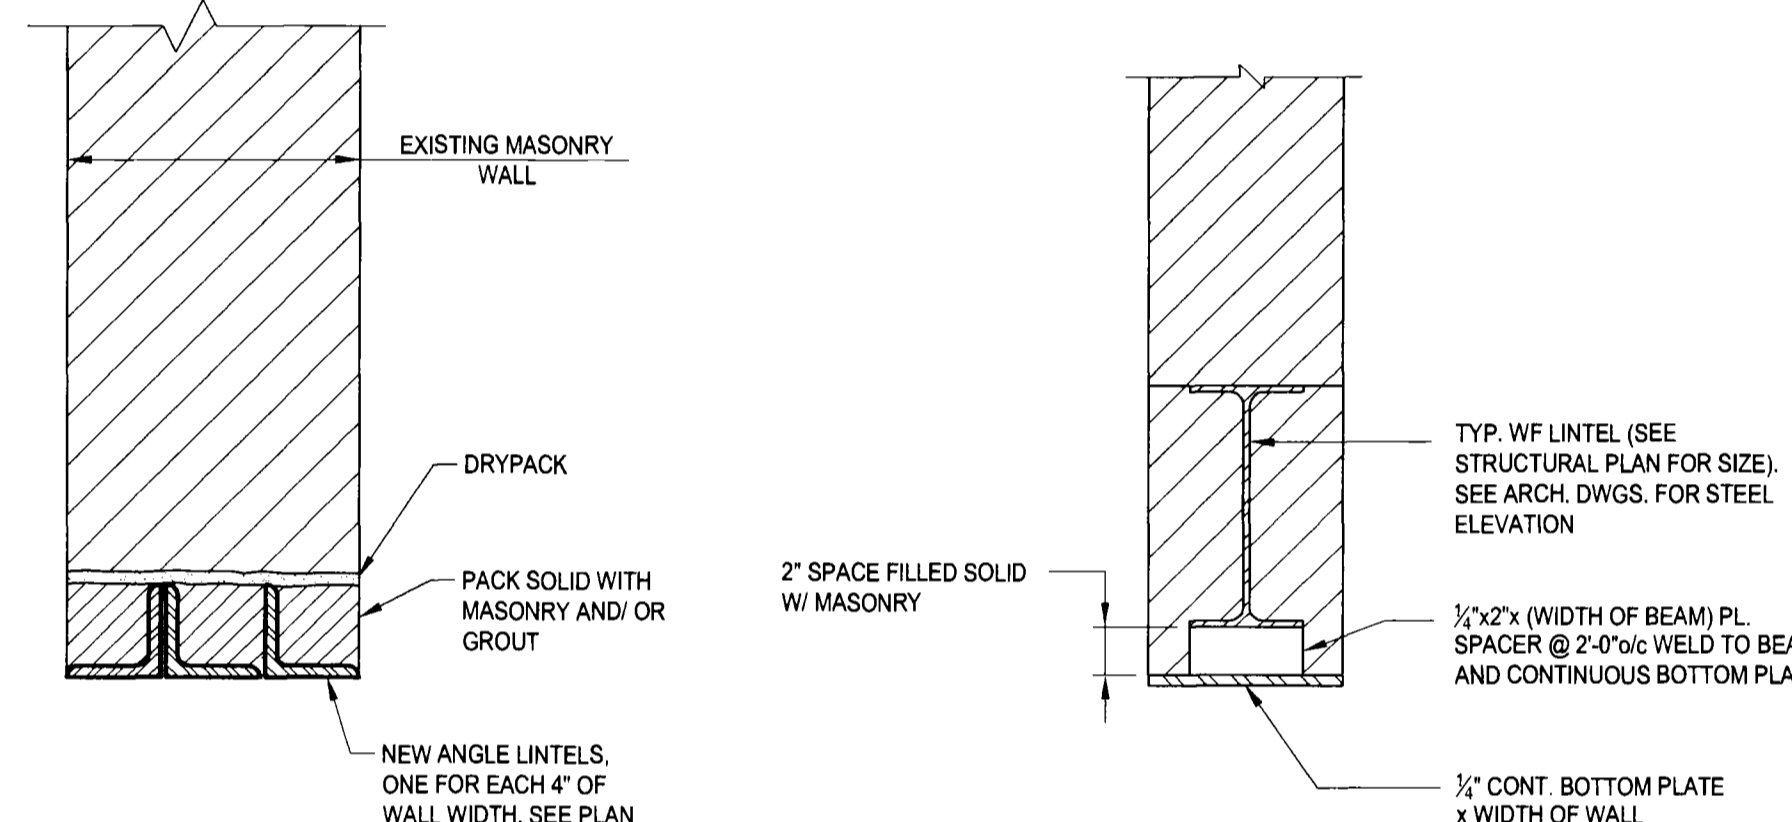


TYPICAL DETAIL LINTEL IN EXISTING MASONRY WALL
SCALE: 1 1/2"=1'-0"

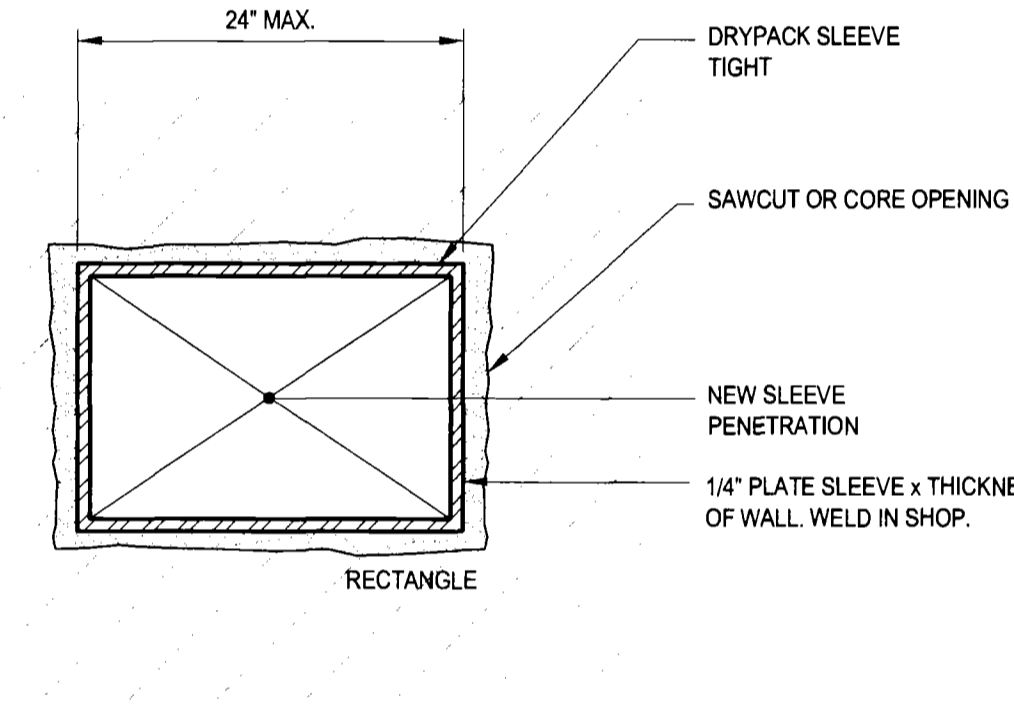


DUCT SLEEVE PENETRATION IN EXISTING WALLS
TYPICAL DETAIL
SCALE: 1"=1'-0"

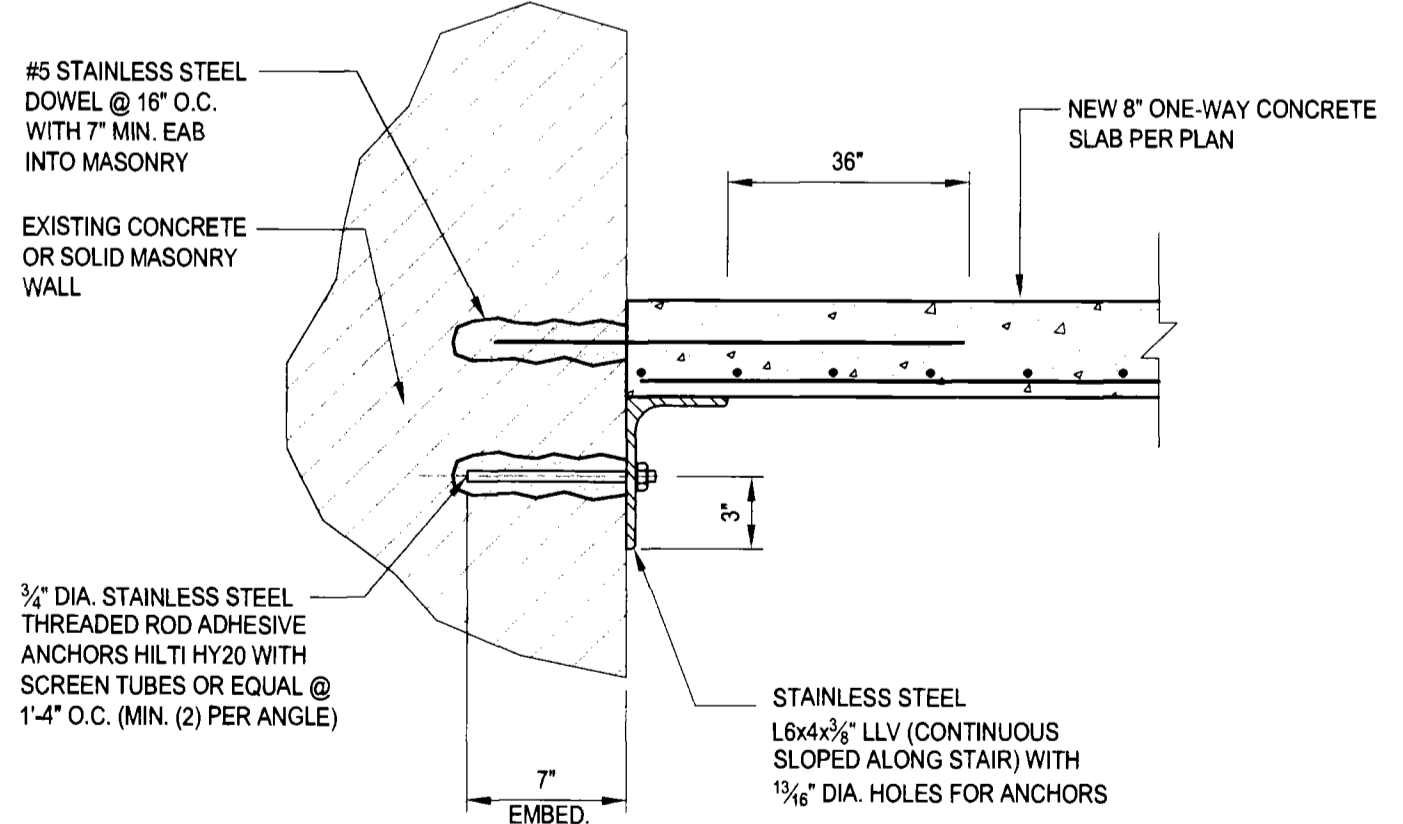


TYPICAL DETAIL SHELF ANGLE AT EXISTING LOAD BEARING WALL FOR ONE WAY SLAB
SCALE: 1 1/2"=1'-0"

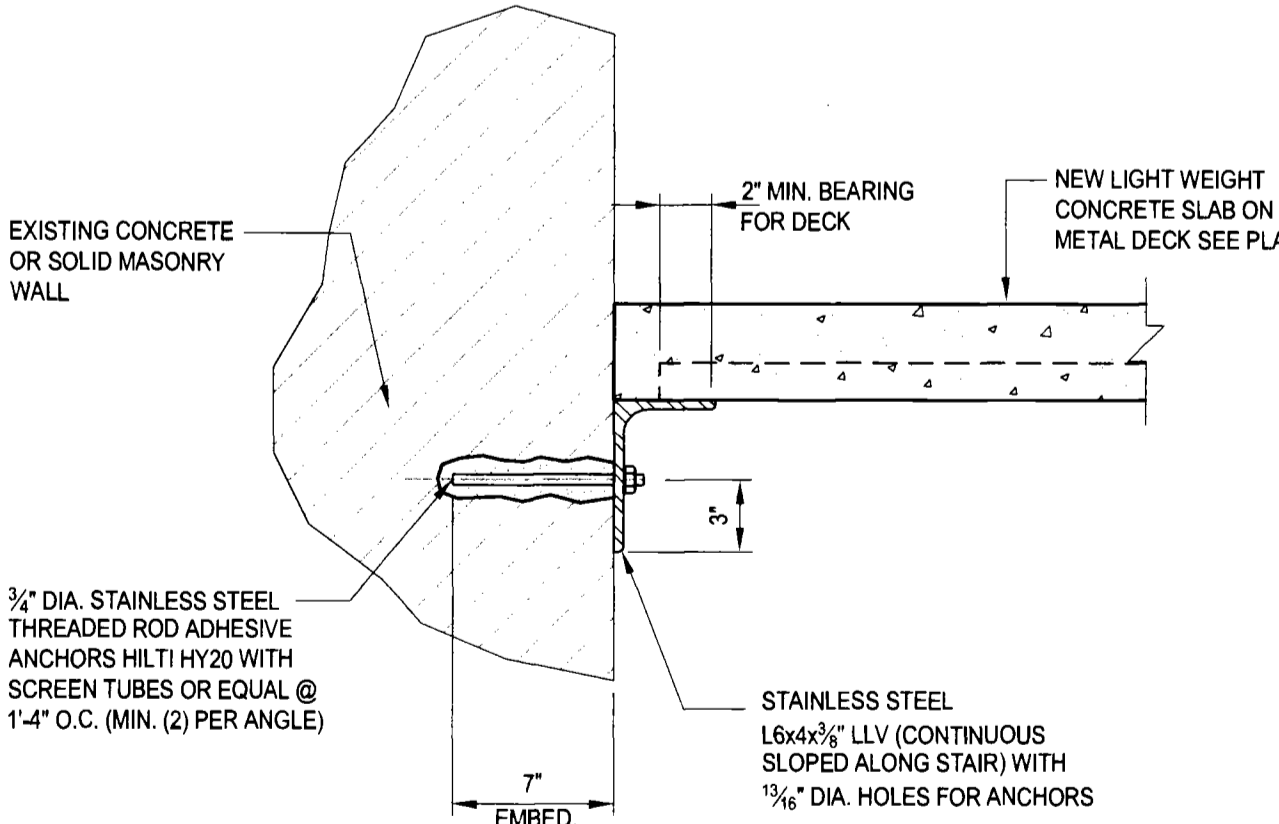


TYPICAL DETAIL SHELF ANGLE AT EXISTING LOAD BEARING WALL FOR ONE WAY SLAB ON DECK
SCALE: 1 1/2"=1'-0"

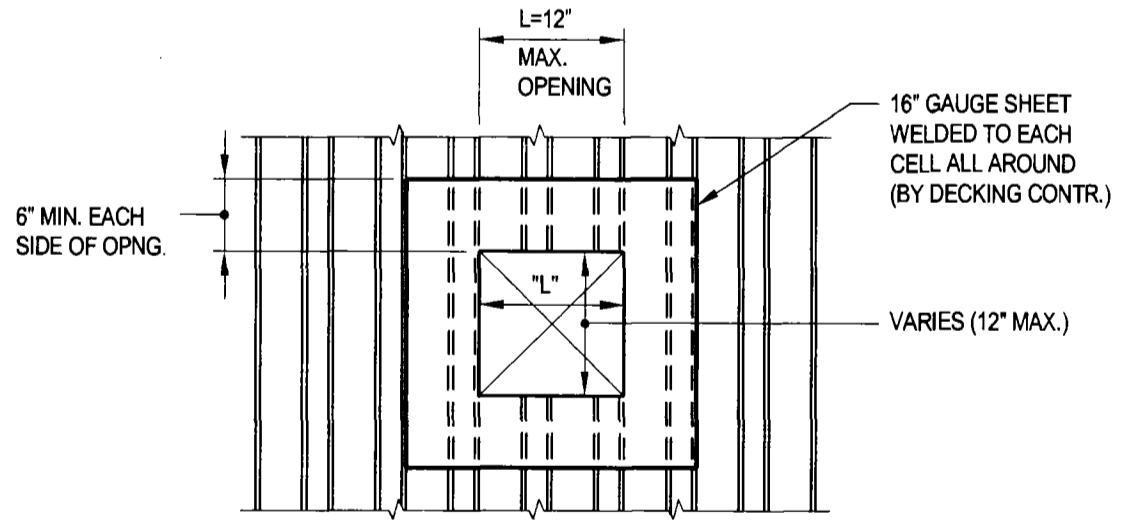


TYPICAL DETAIL REINFORCEMENT FOR UNFRAMED OPENINGS IN COMPOSITE FLOOR DECK
SCALE: 3/4"=1'-0"

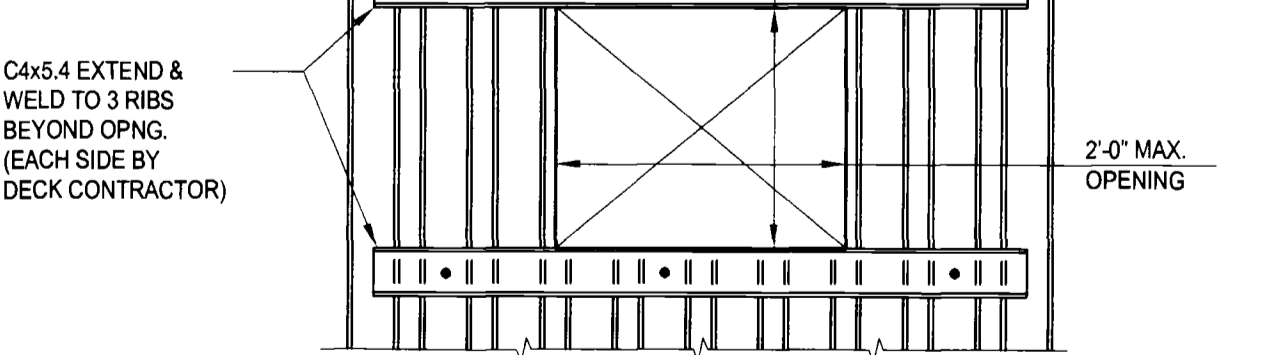

TYPICAL DETAIL REINFORCEMENT FOR UNFRAMED OPENINGS IN COMPOSITE FLOOR DECK
SCALE: 3/4"=1'-0"

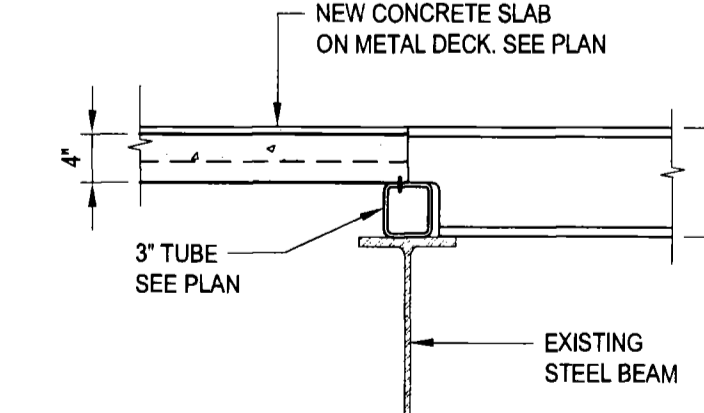

SECTION
SCALE: 3/4"=1'-0"

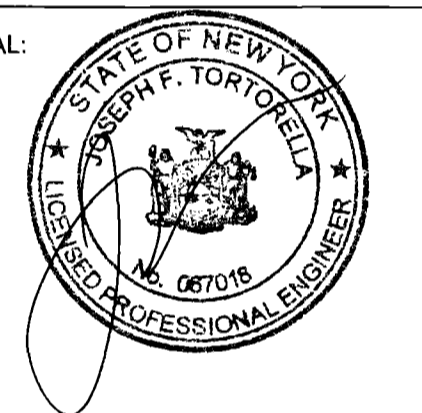

REVISIONS:

NUMBER	DESCRIPTION	DATE



DIVISION OF STRUCTURES
BUREAU OF ARCHITECTURE & ENGINEERING

CAPITAL PROJECT NUMBER:
CITY HALL 2


PROJECT NAME:
Renovation of City Hall Bid Package 2

FOR THE:

DRAWING TITLE:

Typic



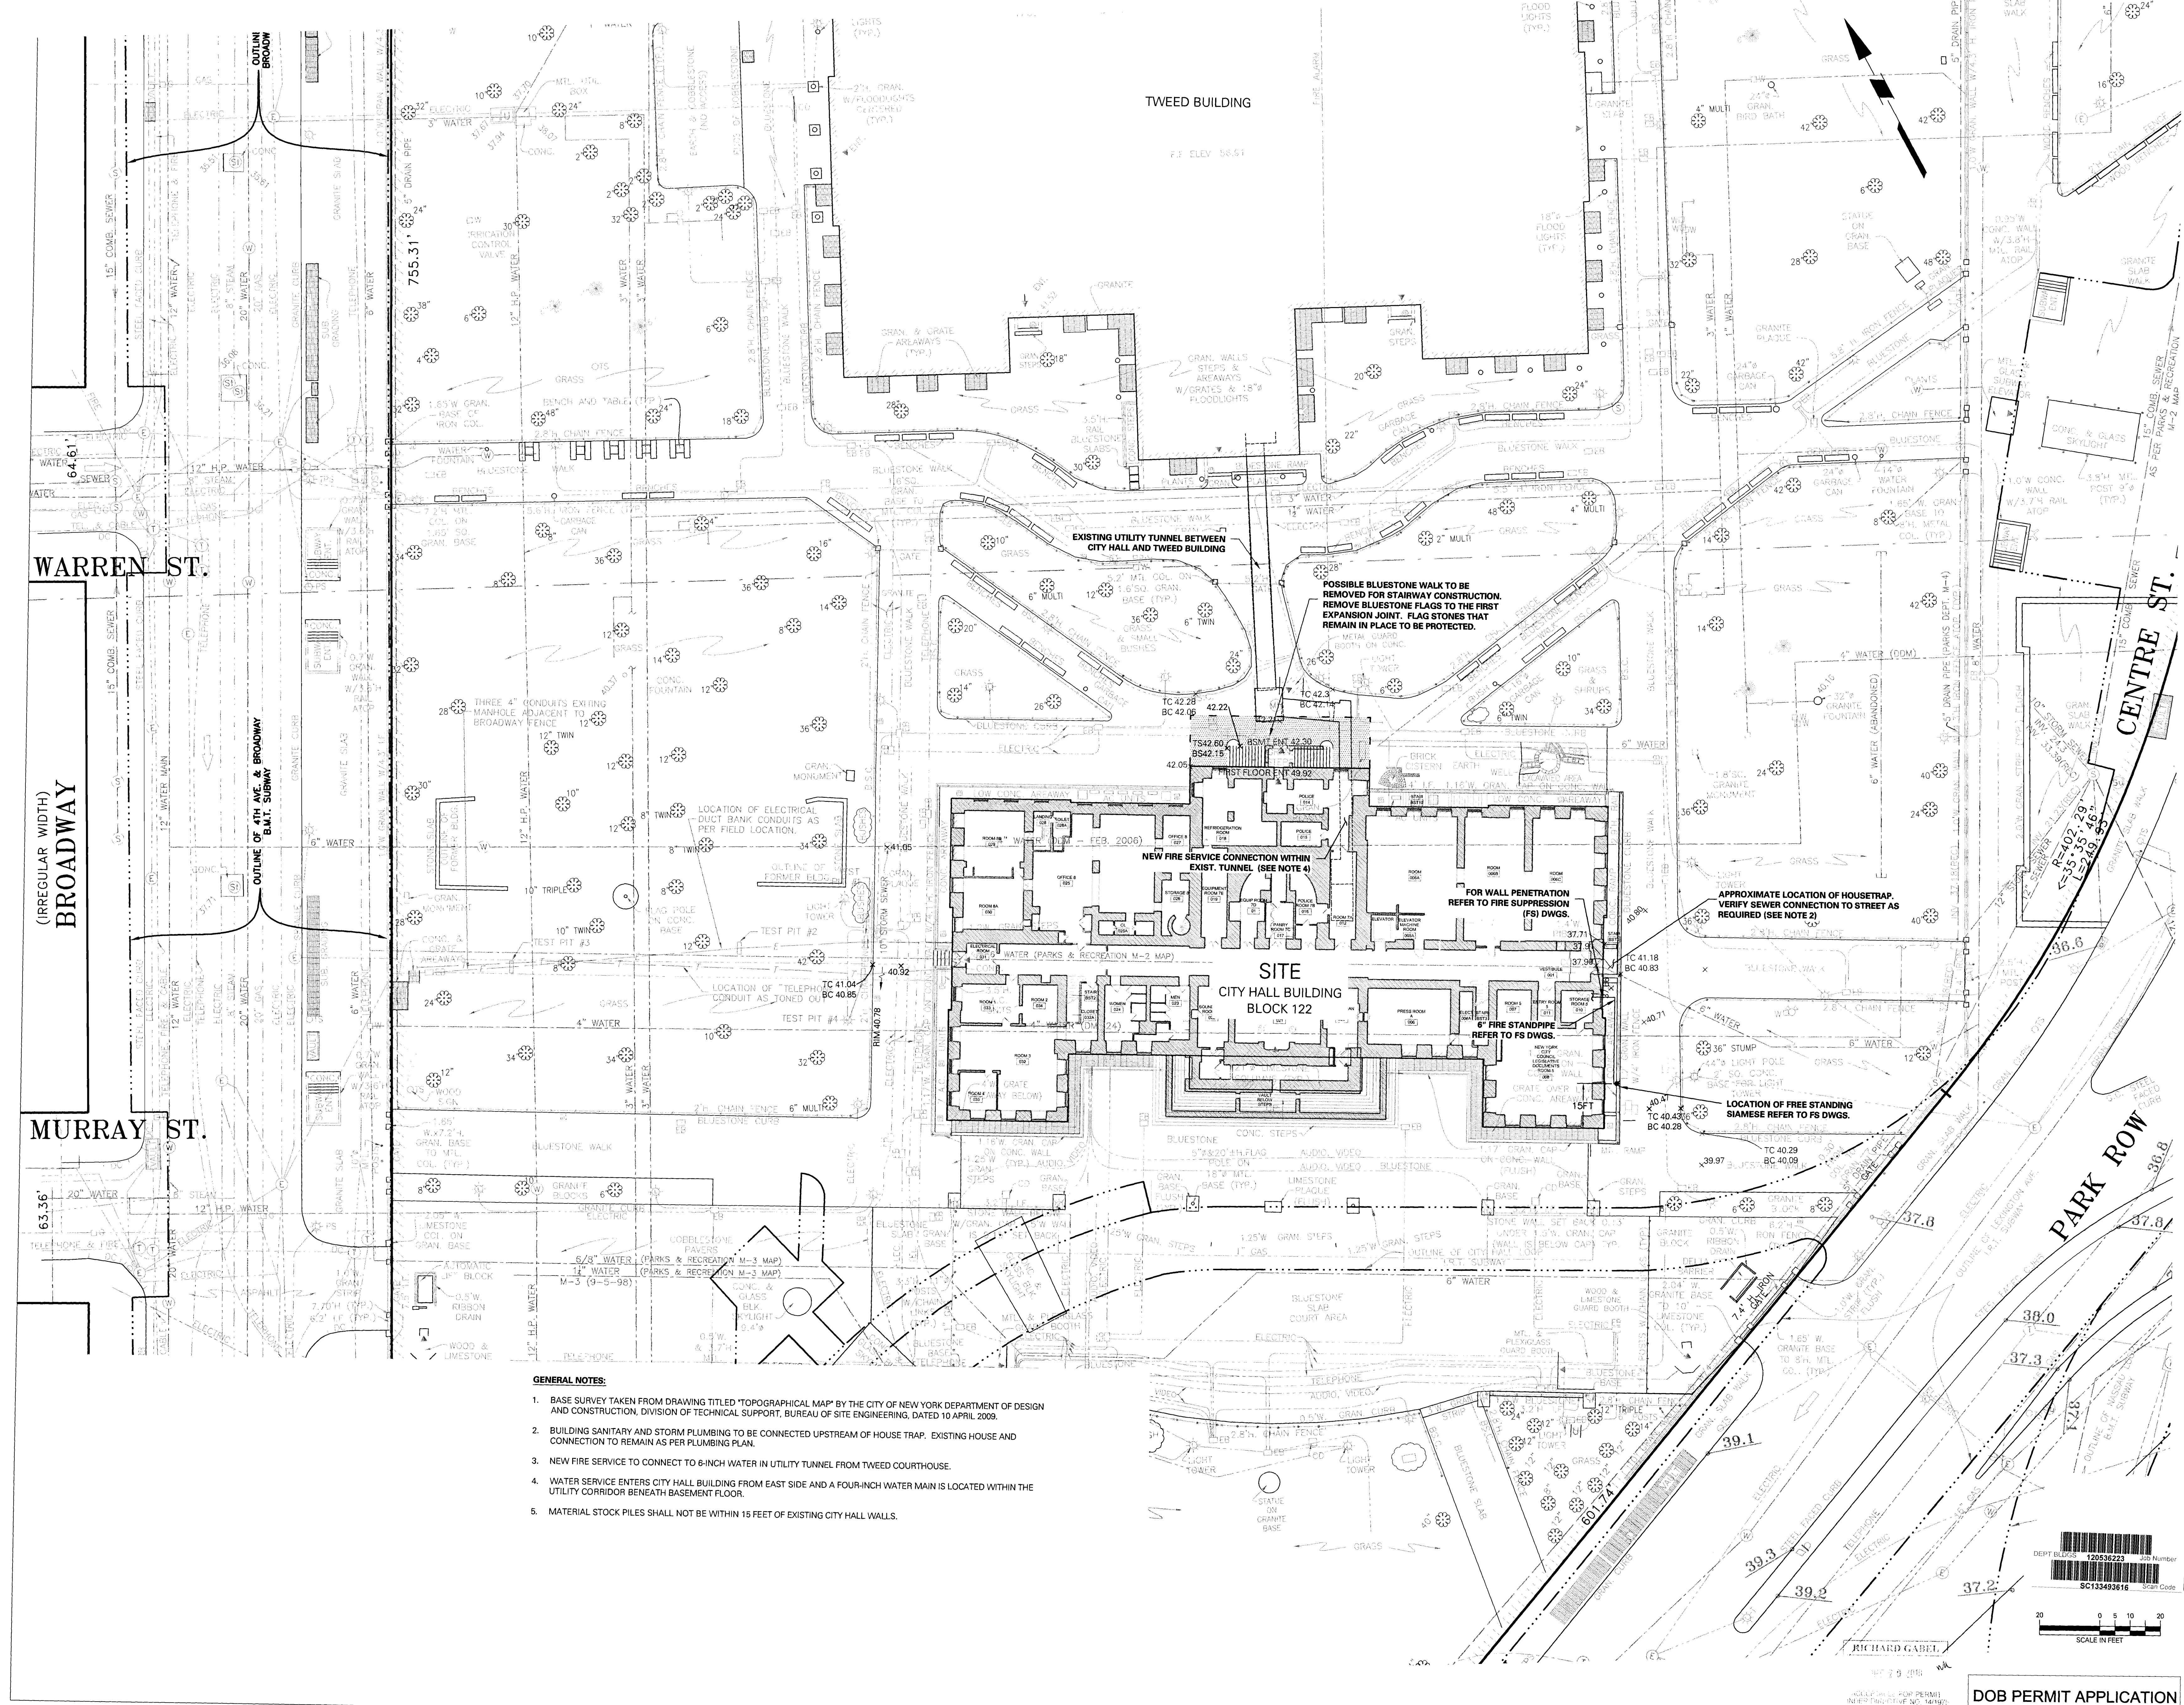

- GENERAL NOTES:**
1. BASE SURVEY TAKEN FROM DRAWING TITLED "TOPOGRAPHICAL MAP" BY THE CITY OF NEW YORK DEPARTMENT OF DESIGN AND CONSTRUCTION, DIVISION OF TECHNICAL SUPPORT, BUREAU OF SITE ENGINEERING, DATED 10 APRIL 2009.
 2. BUILDING SANITARY AND STORM PLUMBING TO BE CONNECTED UPSTREAM OF HOUSE TRAP. EXISTING HOUSE AND CONNECTION TO REMAIN AS PER PLUMBING PLAN.
 3. NEW FIRE SERVICE TO CONNECT TO 6-INCH WATER IN UTILITY TUNNEL FROM TWEED COURTHOUSE.
 4. WATER SERVICE ENTERS CITY HALL BUILDING FROM EAST SIDE AND A FOUR-INCH WATER MAIN IS LOCATED WITHIN THE UTILITY CORRIDOR BENEATH BASEMENT FLOOR.
 5. MATERIAL STOCK PILES SHALL NOT BE WITHIN 15 FEET OF EXISTING CITY HALL WALLS.



REVISIONS:

NUMBER	DESCRIPTION	DATE



DIVISION OF STRUCTURES
BUREAU OF ARCHITECTURE & ENGINEERING

CAPITAL PROJECT NUMBER:
CITYHALL2

PROJECT NAME:
Renovation of City Hall
Bid Package 2

FOR THE:


DRAWING TITLE:
Civil Site Improvement Plan

DRAWN BY: RL/ABN SCALE: 1" = 20'

CHECKED BY: MOC DATE: 10.08.10

DRAWING NUMBER:
C101.00


SHEET NUMBER:
1 OF 2

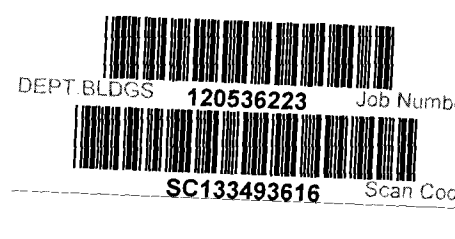

DEPT BLDG# 12253229
SC13349216



DOB PERMIT APPLICATION

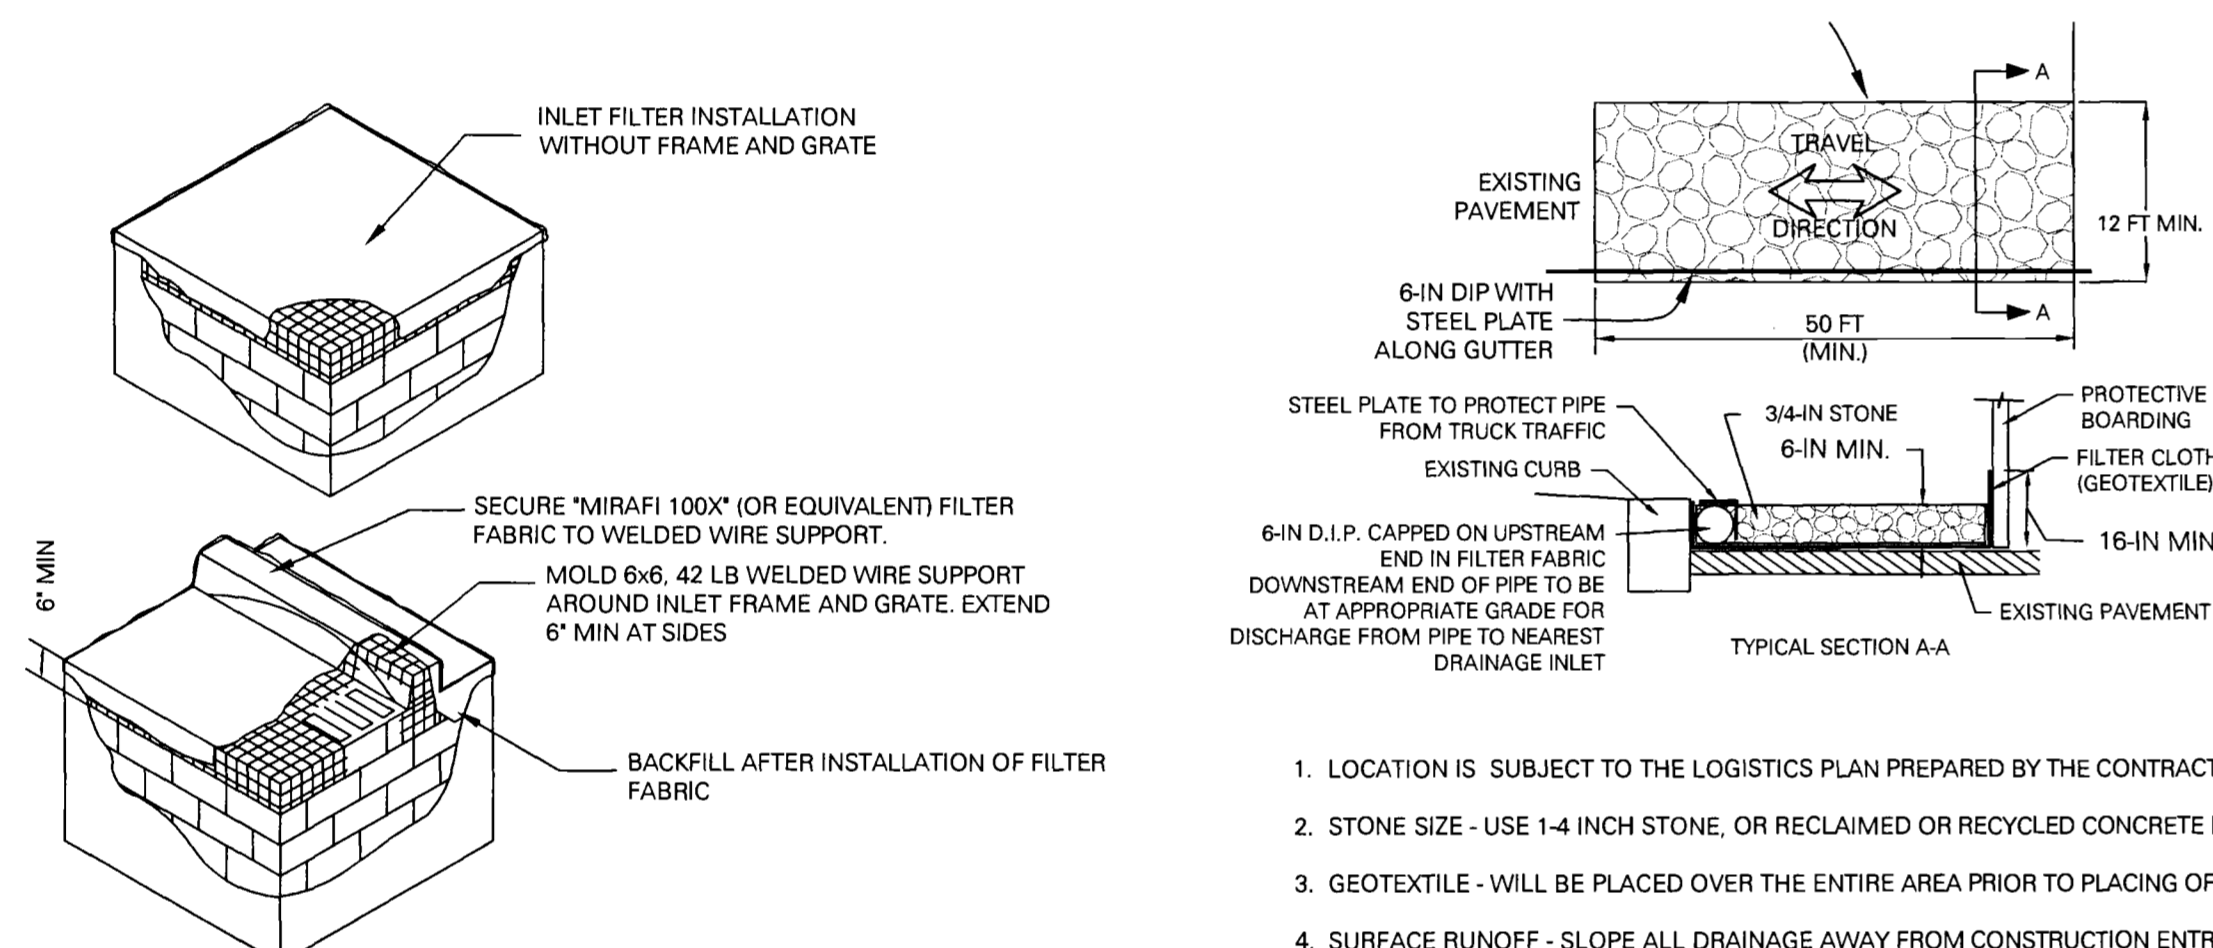


- CONTRACTOR IS TO DESILT CATCH BASIN PRIOR TO CONSTRUCTION
 - THE STRUCTURE SHALL BE INSPECTED AFTER EVERY STORM EVENT. ANY SEDIMENT SHOULD BE REMOVED AND DISPOSED OF ON THE SITE. ANY STONE MISSING SHOULD BE REPLACED. CHECK MATERIALS FOR PROPER ANCHORAGE AND SECURE AS NECESSARY.
 - CONTRACTOR TO REMOVE FABRIC AND MESH AFTER COMPLETION OF BUILDERS PAVEMENT PLAN IMPROVEMENTS.
 - CONTRACTOR SHALL CLEAN AND DE-SILT CATCH BASIN AND PIPE TO NEAREST MANHOLE AFTER ALL SURFACES ARE PERMANENTLY STABILIZED.
- CATCH BASIN INLET PROTECTION WITH FILTER FABRIC**
N.T.S.
- LOCATION IS SUBJECT TO THE LOGISTICS PLAN PREPARED BY THE CONTRACTOR.
 - STONE SIZE - USE 1-4 INCH STONE, OR RECLAIMED OR RECYCLED CONCRETE EQUIVALENT.
 - GEOTEXTILE - WILL BE PLACED OVER THE ENTIRE AREA PRIOR TO PLACING OF STONE.
 - SURFACE RUNOFF - SLOPE ALL DRAINAGE AWAY FROM CONSTRUCTION ENTRANCE. IF SURFACE RUNOFF MUST BE SLOPED TOWARD CONSTRUCTION ENTRANCES IT SHALL BE PIPED BENEATH THE ENTRANCE. IF PIPING IS IMPRACTICAL, A MOUNTABLE BERM WITH 5:1 SLOPES WILL BE PERMITTED.
 - MAINTENANCE - THE ENTRANCE SHALL BE MAINTAINED IN A CONDITION WHICH WILL PREVENT TRACKING OR FLOWING OF SEDIMENT ONTO PUBLIC RIGHTS-OF-WAY. ALL SEDIMENT SPILLED, DROPPED, WASHED OR TRACKED ONTO PUBLIC RIGHTS-OF-WAY MUST BE REMOVED IMMEDIATELY AND DISPOSED OF PROPERLY.
 - WHEN WASHING IS REQUIRED, ALL DOWN FLOW AREAS SHALL BE CHECKED PRIOR TO AND POST WASHING. ALL SEDIMENT SHALL BE REMOVED FROM DOWN FLOW AREAS.
 - PERIODIC INSPECTION AND NEEDED MAINTENANCE SHALL BE PROVIDED AFTER EACH RAIN.
- TRUCK CLEANING PAD**
N.T.S.

PLANNED EROSION AND SEDIMENT CONTROL PRACTICES:


- THE CONTRACTOR IS RESPONSIBLE FOR CONSTRUCTION STAGING AND SEQUENCE OF WORK THAT ESTABLISHES SITE ACCESS, WORK ZONE AND STOCK PILE LOCATIONS. THE CONTRACTOR IS REQUIRED TO ADHERE TO THE FOLLOWING EROSIONS AND SEDIMENT CONTROL PRACTICES.
- DUST CONTROL: SHOULD EXCESSIVE DUST BE GENERATED, IT SHALL BE CONTROLLED BY SPRINKLING.
- ALL VEHICLES INVOLVED IN SOIL MOVING ACTIVITIES SHALL LEAVE THE SITE BY MEANS OF A TRUCK CLEANING BED OR OTHER ACCEPTABLE MEANS OF PREVENTING SOIL TRANSPORT ONTO PUBLIC R.O.W.'S. CONTRACTOR TO FIELD LOCATE SUCH CLEANING BED.
- ALL STOCKPILES SHALL HAVE SILT FENCE INSTALLED AROUND THEIR PERIMETER.

SOIL EROSION AND SEDIMENT CONTROL MAINTENANCE NOTES:


- THE CONTRACTOR WILL BE RESPONSIBLE FOR THE PROPER CONSTRUCTION AND MAINTENANCE OF ALL TEMPORARY EROSION AND SEDIMENTATION CONTROL MEASURES AND RELATED ITEMS INCLUDED WITHIN THIS PLAN. THE CONTRACTOR WILL ALSO BE RESPONSIBLE FOR THE PROPER CONSTRUCTION AND STABILIZATION OF PERMANENT CONTROL MEASURES AND RELATED ITEMS INCLUDED WITHIN THIS PLAN THROUGH COMPLETION OF CONSTRUCTION.
- THE OWNER WILL BE RESPONSIBLE FOR THE MAINTENANCE OF ALL PERMANENT CONTROL MEASURES.
- SEDIMENT REMOVED FROM ANY TEMPORARY CONTROL MEASURE DURING REGULAR MAINTENANCE MAY BE INCORPORATED BACK INTO THE EARTHWORK AS FILL ON THE SITE IF APPROVED BY THE ENGINEER. SEDIMENT THAT IS NOT APPROVED FOR FILL MUST BE DISPOSED OF IN ACCORDANCE WITH ALL APPLICABLE REGULATIONS AND GUIDELINES.
- ALL EROSION AND SEDIMENT CONTROL PRACTICES WILL BE CHECKED FOR STABILITY AND OPERATION FOLLOWING EVERY RUNOFF-PRODUCING RAINFALL BUT IN NO CASE LESS THAN ONCE A WEEK. ANY NEEDED REPAIRS WILL BE MADE IMMEDIATELY TO MAINTAIN ALL PRACTICES DURING A SPECIFIC CONSTRUCTION STAGE.
- SEDIMENT WILL BE REMOVED FROM BEHIND THE SILT FENCE AND/OR PROTECTIVE BOARDING WHEN IT BECOMES APPROXIMATELY 0.5 FEET DEEP, OR WHEN BULGES DEVELOP. THE SILT FENCE AND/OR PROTECTIVE BOARDING WILL BE REPAIRED AS NECESSARY TO MAINTAIN A BARRIER.
- THE TRUCK CLEANING PAD SHALL BE MAINTAINED IN A CONDITION WHICH WILL PREVENT TRACKING OR FLOWING OF SEDIMENT ONTO PUBLIC RIGHTS-OF-WAY (R.O.W.). ALL SEDIMENT SPILLED, DROPPED, WASHED, OR TRACKED ONTO R.O.W.'S MUST BE REMOVED IMMEDIATELY. WHEN WASHING IS REQUIRED, IT SHALL BE DONE ON AN AREA STABILIZED WITH STONE AND WHICH DRAINS INTO AN APPROVED SEDIMENT TRAPPING DEVICE. PERIODIC INSPECTION AND NEEDED MAINTENANCE SHALL BE PROVIDED AFTER EACH RAIN.
- IN ADDITION TO IMPLEMENTATION AND MAINTENANCE OF EROSION AND SEDIMENT CONTROL MEASURES FOR ONGOING ACTIVE CONSTRUCTION ACTIVITY, THE CONTRACTOR SHALL INITIATE STABILIZATION MEASURES AS SOON AS POSSIBLE IN PORTIONS OF THE SITE WHERE CONSTRUCTION ACTIVITIES HAVE TEMPORARILY OR PERMANENTLY CEASED BUT IN NO CASE NO MORE THAN 14 DAYS AFTER THE CONSTRUCTION ACTIVITY IN THAT PORTION OF THE SITE HAD TEMPORARILY OR PERMANENTLY CEASED.
- SOIL EROSION AND SEDIMENT CONTROL MEASURES SHALL BE IN COMPLIANCE WITH EPA STANDARD 832/R/92-005, CHAPTER 3 SEDIMENT AND EROSION CONTROL.
- THE ONLY SOIL THAT WILL BE DISTURBED DURING CONSTRUCTION IS THE SOIL REMOVED DURING EXCAVATION ACTIVITIES. WE THEREFORE ANTICIPATE NO RUN-OFF FROM THE SITE. ALL EXCAVATED SOIL SHALL BE REMOVED FROM THE SITE IN COVERED TRUCKS.
- CONTRACTOR IS RESPONSIBLE FOR PROCURING AND COMPLYING WITH ALL PERMITS REQUIRED.
- CONTRACTOR SHALL PROTECT EXTERIOR SURFACES AS REQUIRED DUE TO PROJECT CONSTRUCTION ACTIVITIES WITHIN PROJECT AREA.
- CONSTRUCTION EQUIPMENT AND VEHICLES WITHIN THE WORK AREA SHALL BE PROPERLY MAINTAINED AND INSPECTED FOR LEAKING, PARTICULARLY FOR IDENTIFICATION OF VEHICLES LEAKING PETROLEUM PRODUCTS THAT MAY ENTER ADJACENT STORMWATER DRAINAGE FACILITIES.
- PAVEMENT AND WALKWAYS WITHIN THE PROJECT LIMITS SHALL BE KEPT CLEAN AND FREE OF SOIL THROUGHOUT CONSTRUCTION.

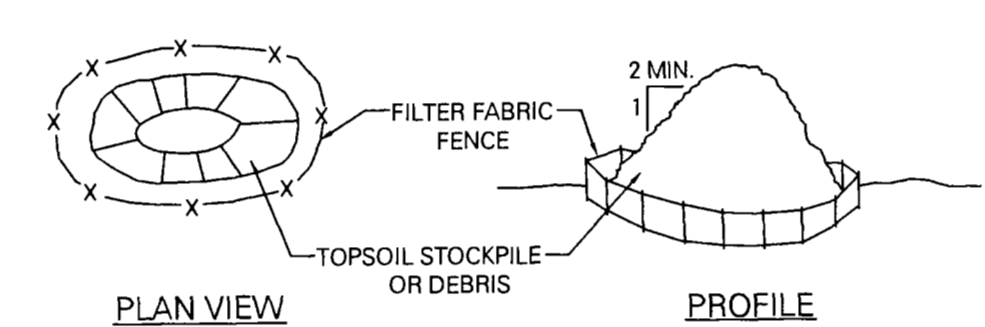


- SILT FENCE MUST BE PLACED AROUND THE PERIMETER OF ALL STOCKPILES.
 - CONTRACTOR TO PROVIDE STOCKPILE COVER AND SECURE IN PLACE.
- DEBRIS OR TOPSOIL STOCKPILE DETAIL**
N.T.S.

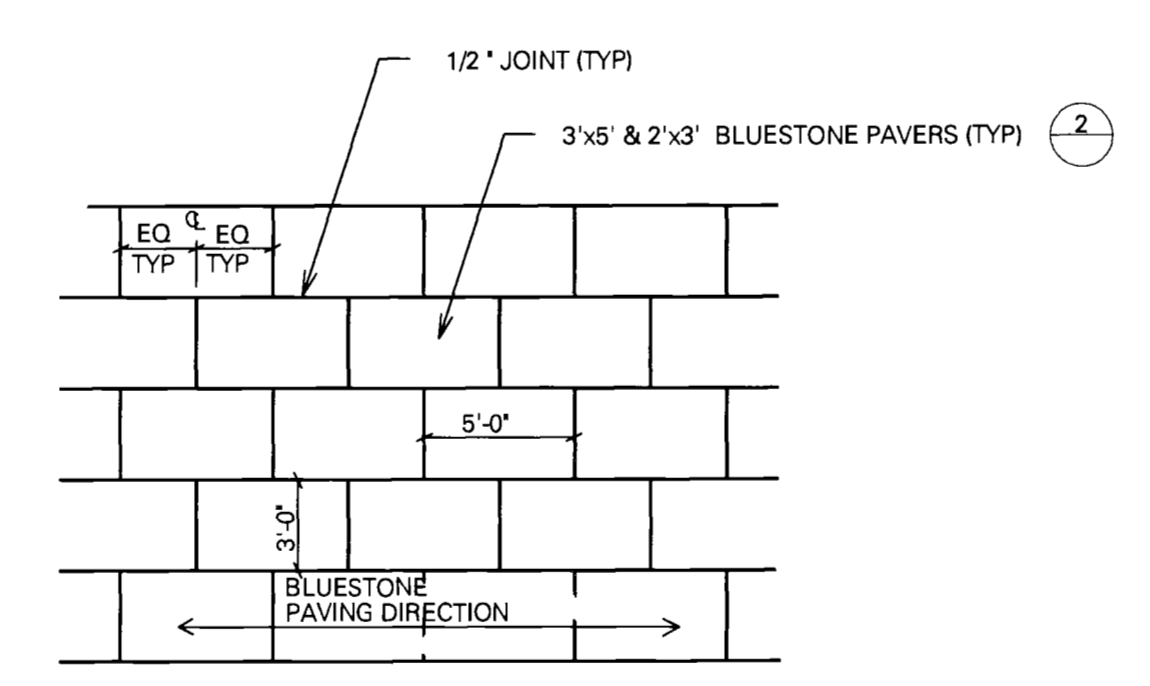


1 Bluestone Pavers-Typical Layout Detail
Scale: N.T.S.

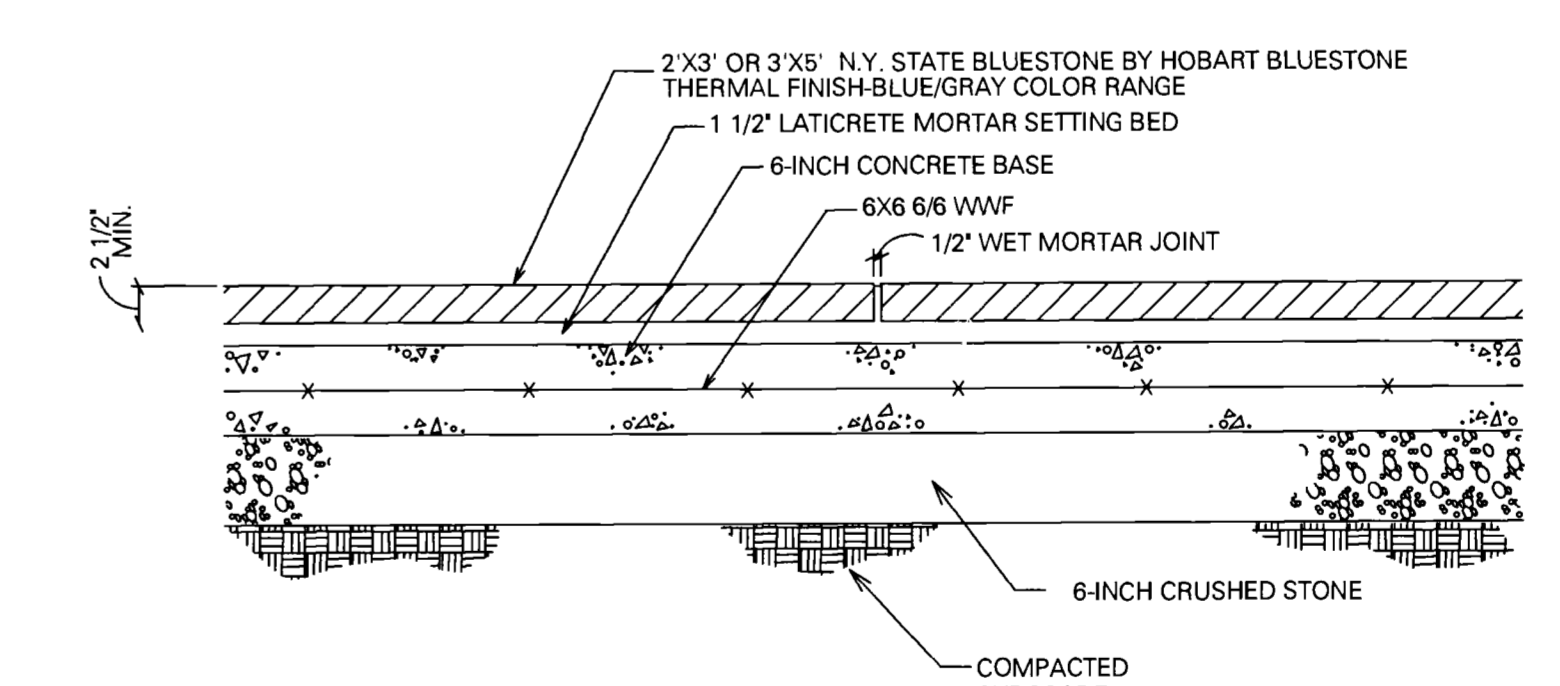

2 Bluestone Pavement (2' X 3' or 3' x 5' Pavers, V.I.F.)
Scale: N.T.S.

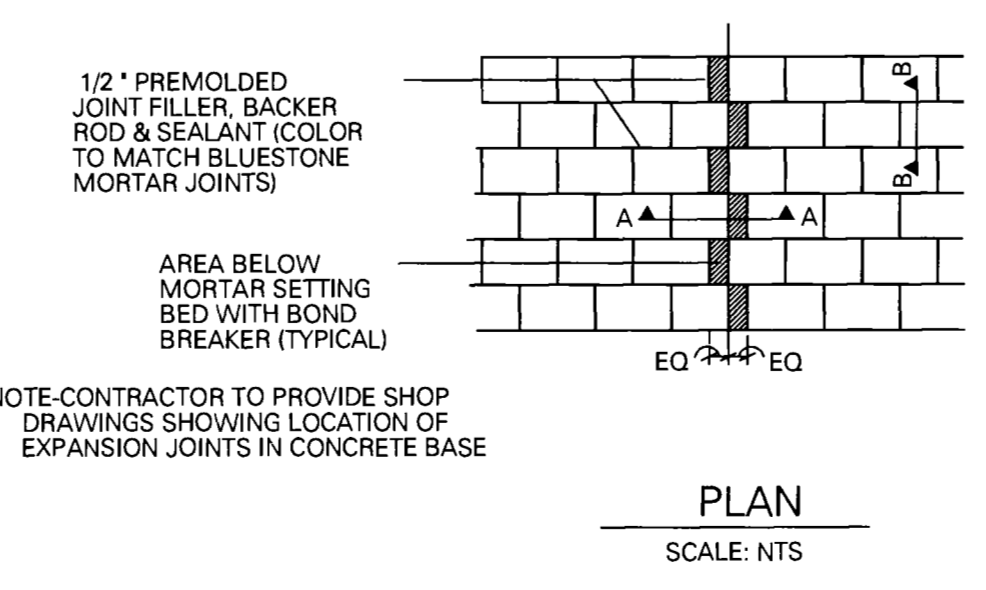

3 Expansion Joint In Bluestone Pavement
Scale: N.T.S.

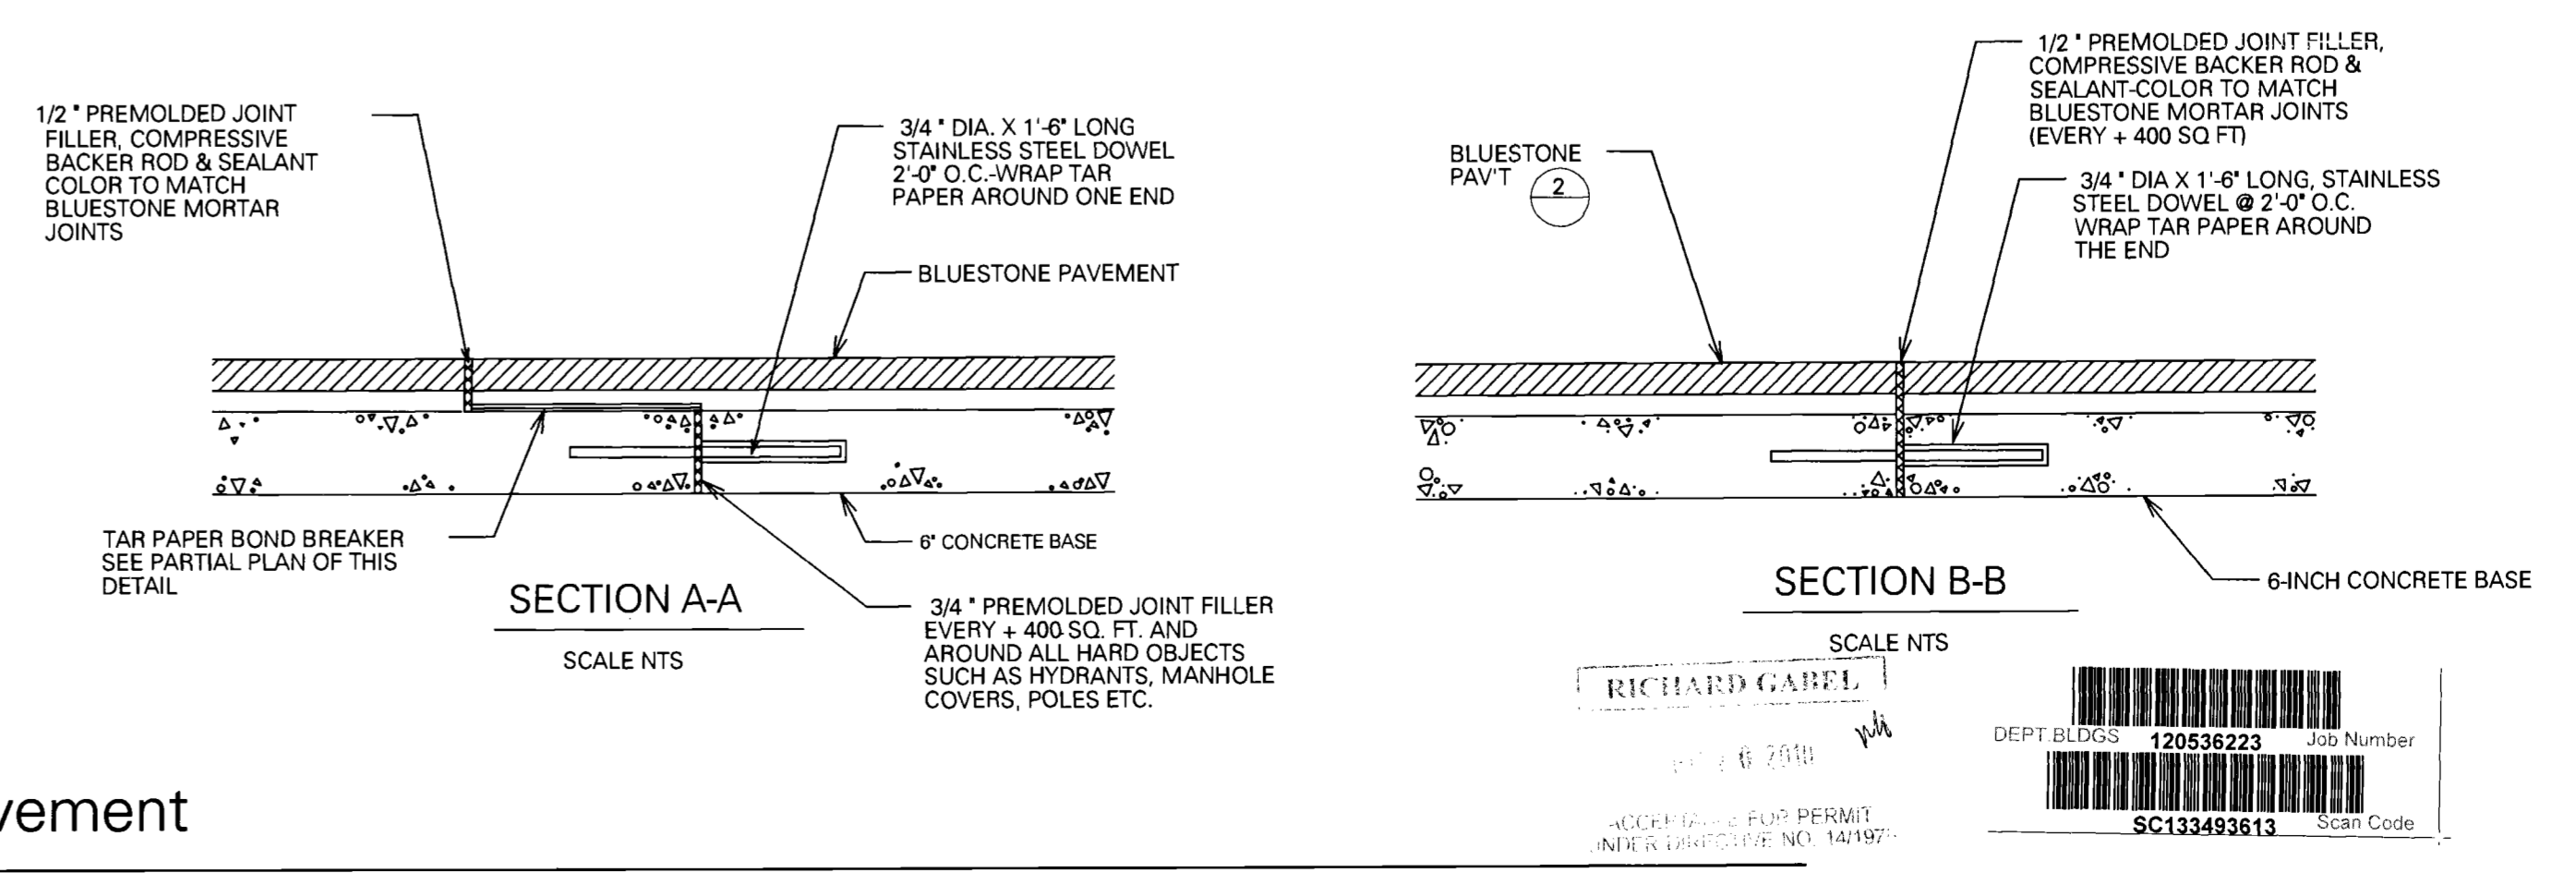

DOB PERMIT APPLICATION

SEAL:



REVISIONS:

NUMBER	DESCRIPTION	DATE



**DIVISION OF STRUCTURES
BUREAU OF ARCHITECTURE & ENGINEERING**

CAPITAL PROJECT NUMBER:
CITYHALL2
PROJECT NAME:
Renovation of City Hall Bid Package 2

FOR THE:

DRAWING TITLE:
Civil Site Improvement Details

DRAWN BY: RL/ABN SCALE: AS NOTED
CHECKED BY: MOC DATE: 10.08.10

DRAWING NUMBER:
C301.00

SHEET NUMBER:
2 OF 2